COMPLYING DEVELOPMENT

PROPOSED INDUSTRIAL UNITS

14D COBBANS CLOSE BERESFIELD

LOT 8 DP 271225





DRAWING SCHEDULE

PROJECT	SHEET	TITLE	REVISION
20322A	CD01	SITE LOCALITY PLAN	3
20322A	CD02	SITE PLAN	3
20322A	CD03	FLOOR PLAN	3
20322A	CD04	MEZZANINE FLOOR PLANS	3
20322A	CD05	ELEVATION & PERSPECTIVES	3
20322A	CD06	ELEVATIONS	3
20322A	CD07	SECTIONS	3
20322A	CD08	SECTION & DETAILS	3
20322A	CD09	DETAILS	3
20322A	CD10	ROOF PLAN	3
20322A	CD11	VEHICLE MOVEMENT PLAN	3
20322A	CD12	LANDSCAPING PLAN	3
20322A	CD13	LANDSCAPING DETAILS & NOTES	3
20322A	CD14	NOTES	3

Council

NEWCASTLE CITY COUNCIL

Client

PRECINCT GROUP





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SITE LOCALITY PLAN NOT TO SCALE

3 01.12.20 FIRE ENGINEERED SOLUTION MC12.10.20 CLIENT & CERTIFIER COMMENT MC 19.10.20 ORIGINAL ISSUE МС DRAWN REV. DATE DESCRIPTION





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Project Title

PROPOSED INDUSTRIAL UNITS

Project Address

14D COBBANS CLOSE **BERESFIELD**

Client

PRECINCT GROUP

Project Status

COMPLYING DEVELOPMENT


Drawing Title

SITE LOCALITY PLAN


Project No. 20322A

Drawing No. **CD01**

Drawings scaled to an A3 sheet

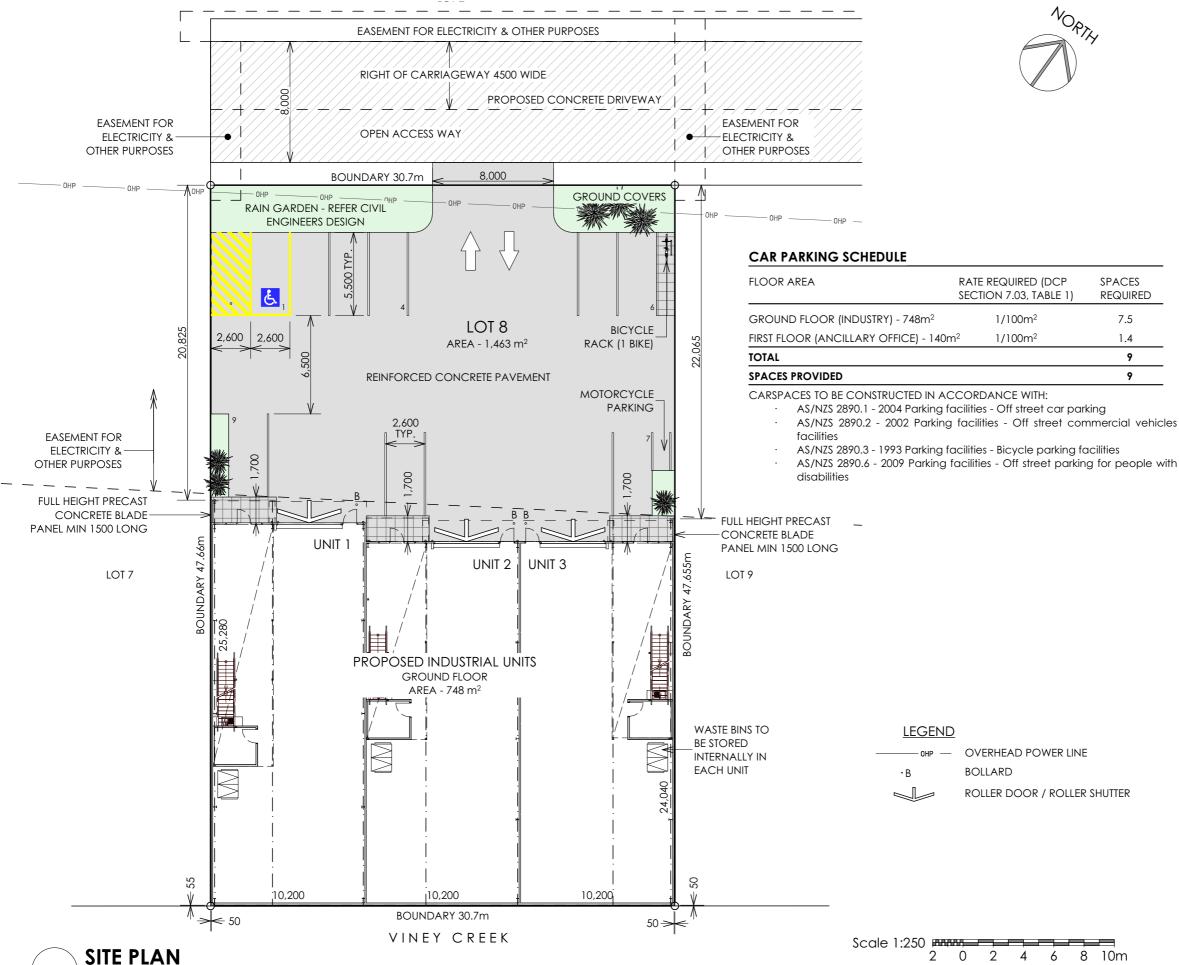

Scale 1:250

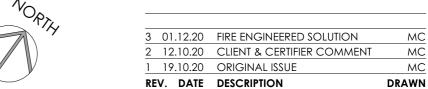



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Project Title

PROPOSED INDUSTRIAL UNITS

Project Address

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Client

PRECINCT GROUP

Project Status

COMPLYING DEVELOPMENT

Drawing Title

SITE PLAN

Project No.	Revision	Drawing No.
20322A	3	CD02

Drawings scaled to an A3 sheet

20322A CDr3.pln Last saved on 1/12/2020 by Mark

2 0 2 4 6 8 10m



RE	V. DATE	DESCRIPTION	DRAWN
1	19.10.20	ORIGINAL ISSUE	MC
2	12.10.20	CLIENT & CERTIFIER COMMENT	MC
3	01.12.20	FIRE ENGINEERED SOLUTION	MC

SMOKE ALARMS TO BE INSTALLED THROUGHOUT THE BUILDING IN ACCORDANCE WITH:

- BCA SPEC E2.2a CLAUSE 3 (a) SMOKE ALARMS TO COMPLY WITH AS 3786, AND TO BE POWERED FROM THE CONSUMERS MAINS SOURCE
- BCA SPEC E2.2a CLAUSE 3 (d)(i) SMOKE ALARMS TO BE LOCATED IN ACCORDANCE WITH THE REQUIREMENTS FOR SMOKE DETECTORS IN AS 1670.1
- SMOKE DETECTORS TO BE INTERCONNECTED TO PROVIDE A COMMON ALARM

REFER FIRE ENGINEERING REPORT BY YGL CONSULTING PTY LTD REFERENCE 2020j0356 DATED NOVEMBER 2020

EMERGENCY LIGHTING TO BE INSTALLED IN ACCORDANCE WITH AS 2293.1 - 2018 TO THE FOLLOWING AREAS:

- INTERNAL STAIRS
- WAREHOUSE / WORKSHOP



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Project Title

PROPOSED INDUSTRIAL UNITS

Project Address

14D COBBANS CLOSE BERESFIELD

Client

PRECINCT GROUP

Project Status

COMPLYING DEVELOPMENT

Drawing Title

FLOOR PLAN

Project No. Revision Drawing No. 20322A 3 CD03

Drawings scaled to an A3 sheet

20322A CDr3.pln Last saved on 1/12/2020 by Mark

-AWNINGS OVER BOUNDARY CD08 -BOUNDARY **AWNINGS** OVER AWNING OVER-ROLLER DOOR Ż 4800H x 4200W ROLLER DOOR ROLLER DOOR 4800H x 4200W 4800H x 4200W UNIT 2 UNIT 3 UNIT 1 **GROUND FLOOR** GROUND FLOOR GROUND FLOOR AREA - 245 m² AREA - 245 m² AREA - 258 m² MEZZANINE MEZZANINE FLOOR OVER FLOOR OVER MEZZANINE FLOOR OVER **KITCHENETTE** BENEATH STAIR UNISEX ACCESSIBLE AMENITIES - REFER DETAIL FULL HEIGHT PRECAST CONCRETE PANEL INTER TENANCY WALLS BOUNDARY ——//\ 10,050 10,050 10,100 100 100 ⇒ 100 100 30,600

FLOOR PLAN

Scale 1:200

LEGEND



EMERGENCY EXIT



TACTILE GROUND SURFACE INDICATORS (TGSI) - REFER DETAIL




EMERGENCY LIGHT





REQUIRED SIGNAGE



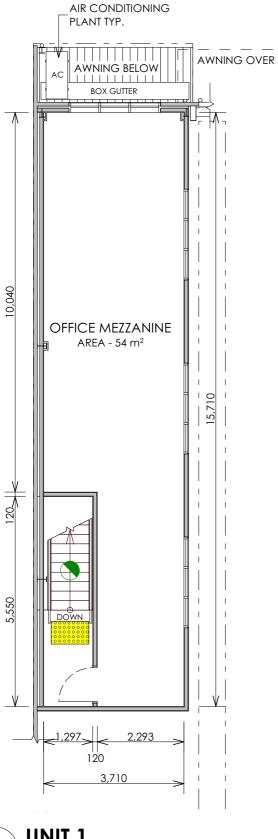

UNIT 1
Scale 1:100

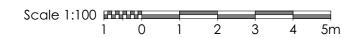


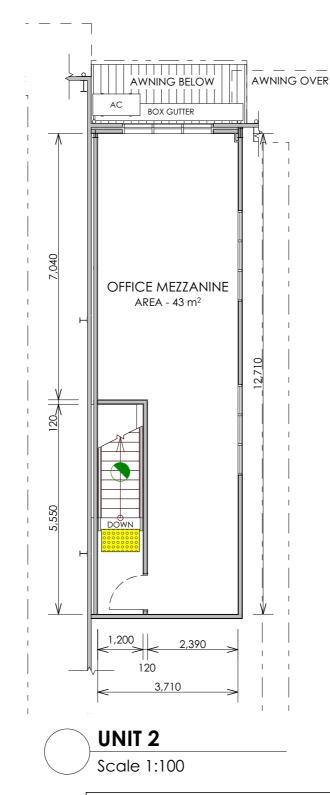

SMOKE ALARMS TO BE INSTALLED THROUGHOUT THE BUILDING IN ACCORDANCE WITH:

- BCA SPEC E2.2a CLAUSE 3 (a) SMOKE ALARMS TO COMPLY WITH AS 3786, AND TO BE POWERED FROM THE CONSUMERS MAINS SOURCE
- BCA SPEC E2.2a CLAUSE 3 (d) (i) SMOKE ALARMS TO BE LOCATED IN ACCORDANCE WITH THE REQUIREMENTS FOR SMOKE DETECTORS IN AS 1670.1
- SMOKE DETECTORS TO BE INTERCONNECTED TO PROVIDE A COMMON ALARM

REFER FIRE ENGINEERING REPORT BY YGL CONSULTING PTY LTD REFERENCE 2020j0356 DATED NOVEMBER 2020

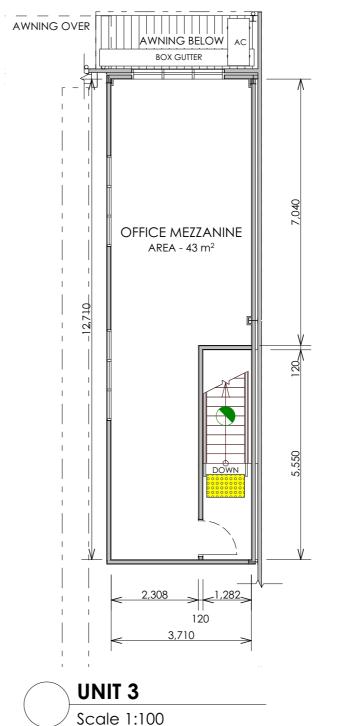

LEGEND



EMERGENCY EXIT



TACTILE GROUND SURFACE INDICATORS (TGSI) - REFER DETAIL



EMERGENCY LIGHT



REQUIRED SIGNAGE

3	01.12.20	FIRE ENGINEERED SOLUTION	MC
2	12.10.20	CLIENT & CERTIFIER COMMENT	MC
1	19.10.20	ORIGINAL ISSUE	MC

EMERGENCY LIGHTING TO BE INSTALLED IN ACCORDANCE WITH AS 2293.1 - 2018 TO THE FOLLOWING AREAS:
- INTERNAL STAIRS
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REV. DATE DESCRIPTION



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Project Title

PROPOSED INDUSTRIAL UNITS

Project Address

14D COBBANS CLOSE BERESFIELD

Client

PRECINCT GROUP

Project Status

COMPLYING DEVELOPMENT


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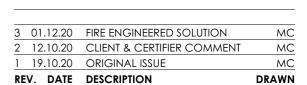
MEZZANINE FLOOR PLANS

Project No. Revision 20322A 3

Drawing No. **CD04**

Drawings scaled to an A3 sheet



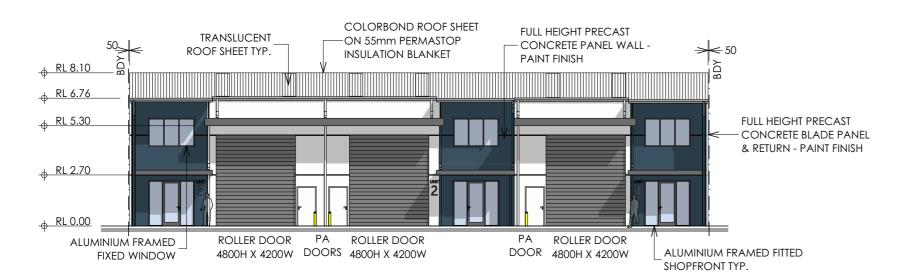











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Project Title

PROPOSED INDUSTRIAL UNITS

Project Address

14D COBBANS CLOSE BERESFIELD

Client

PRECINCT GROUP

Project Status

COMPLYING DEVELOPMENT

Drawing Title


ELEVATION & PERSPECTIVES

Project No. Revision 20322A 3

Drawings scaled to an A3 sheet

Drawing No.

CD05

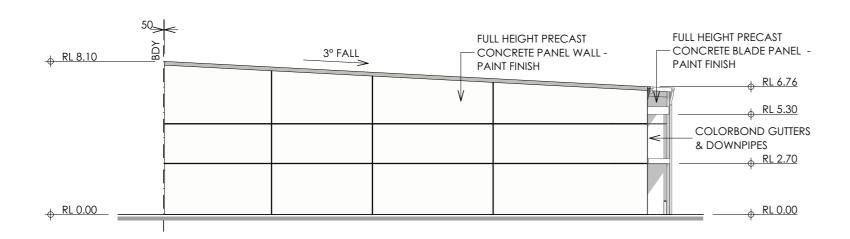


 3
 01.12.20
 FIRE ENGINEERED SOLUTION
 MC


 2
 12.10.20
 CLIENT & CERTIFIER COMMENT
 MC

 1
 19.10.20
 ORIGINAL ISSUE
 MC

 REV.
 DATE
 DESCRIPTION
 DRAWN

2 EAST ELEVATION
CD03 Scale 1:200

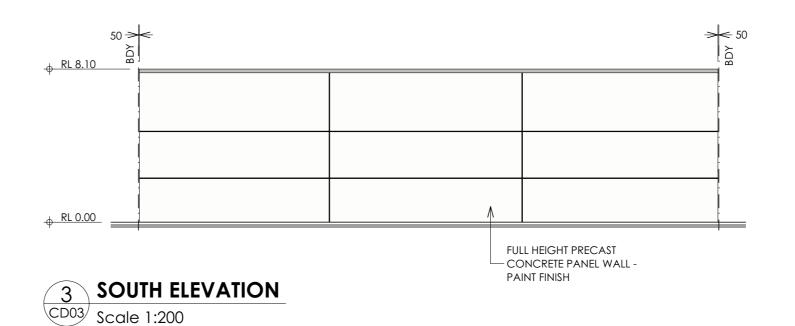

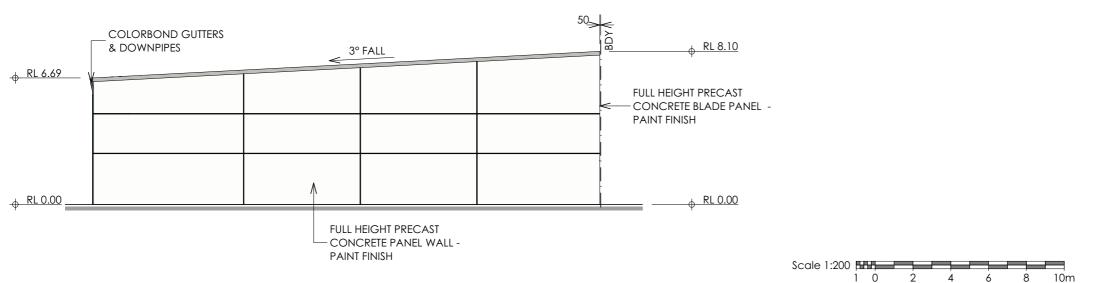

WEST ELEVATION
Scale 1:200





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Project Title

PROPOSED INDUSTRIAL UNITS

Project Address

14D COBBANS CLOSE BERESFIELD

Client

PRECINCT GROUP

Project Status

COMPLYING DEVELOPMENT


Drawing Title

ELEVATIONS

Project No. Revision Drawing No. 20322A 3 CD06

Drawings scaled to an A3 sheet



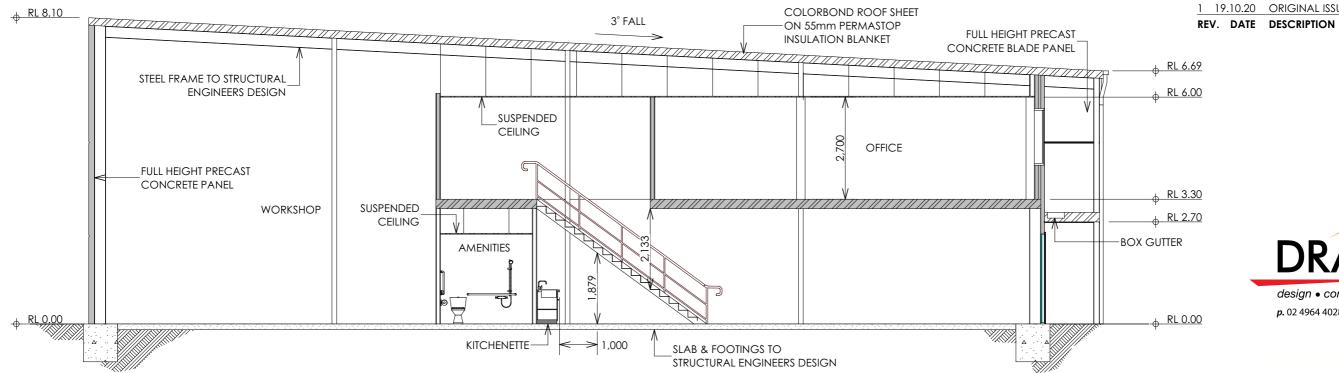



>>> GCA

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Project Title

PROPOSED INDUSTRIAL UNITS

Project Address 14D COBBANS CLOSE

BERESFIELD

Client

PRECINCT GROUP

Project Status


COMPLYING DEVELOPMENT


Drawing Title

SECTIONS


Project No. Revision Drawing No. 20322A 3 **CD07**

Drawings scaled to an A3 sheet

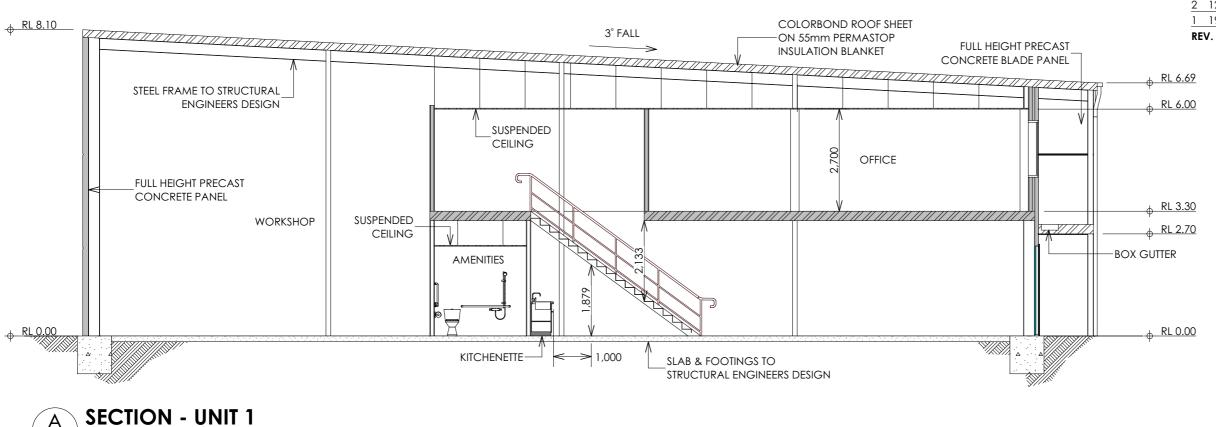

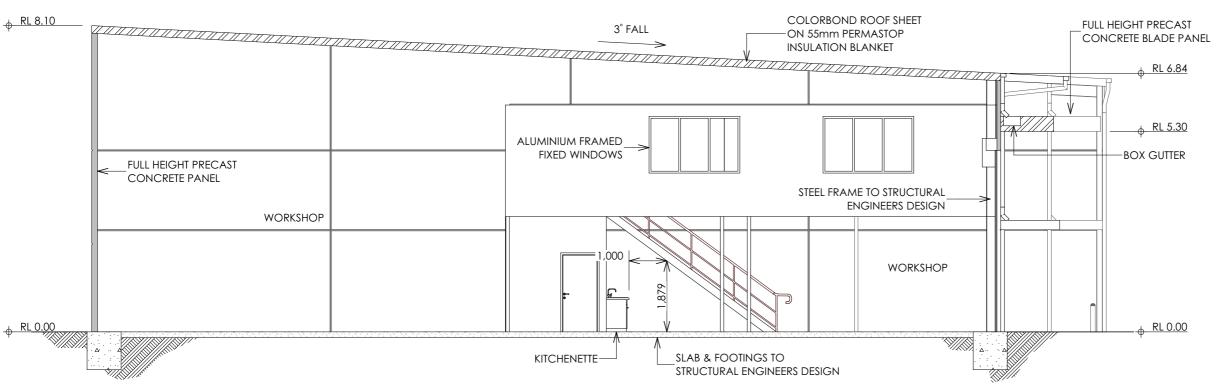

	CLIENT & CERTIFIER COMMENT ORIGINAL ISSUE	MC MC
0.20	CLIENT & CERTIFIER COMMENT	MC
2.20	FIRE ENGINEERED SOLUTION	МС
	2.20	2.20 FIRE ENGINEERED SOLUTION

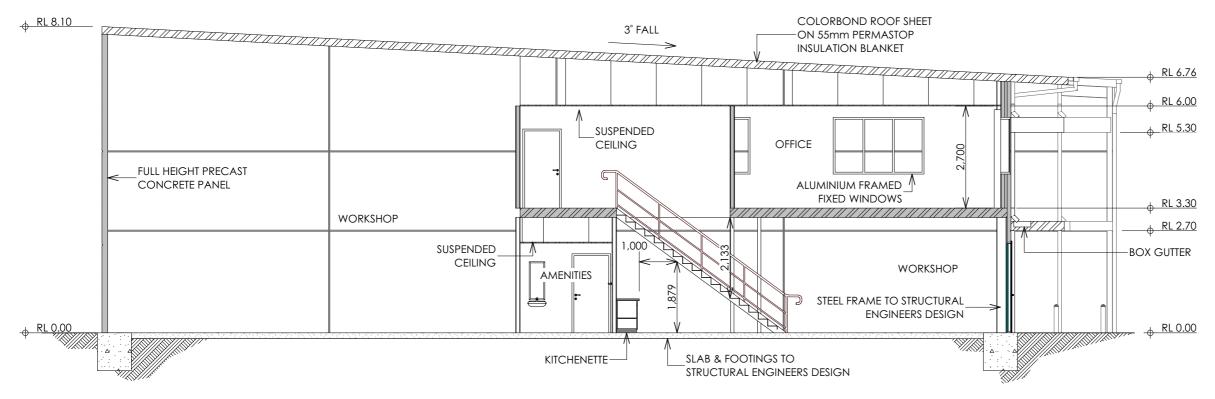

SECTION- UNIT 3

Scale 1:100

DRAYTON

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GCA Engineering Solutions

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Project Title

PROPOSED INDUSTRIAL UNITS

Project Address

14D COBBANS CLOSE BERESFIELD

Client

PRECINCT GROUP

Project Status


COMPLYING DEVELOPMENT


Drawing Title

SECTION & DETAILS

Project No. Revision Drawing No. 20322A 3 CD08

Drawings scaled to an A3 sheet

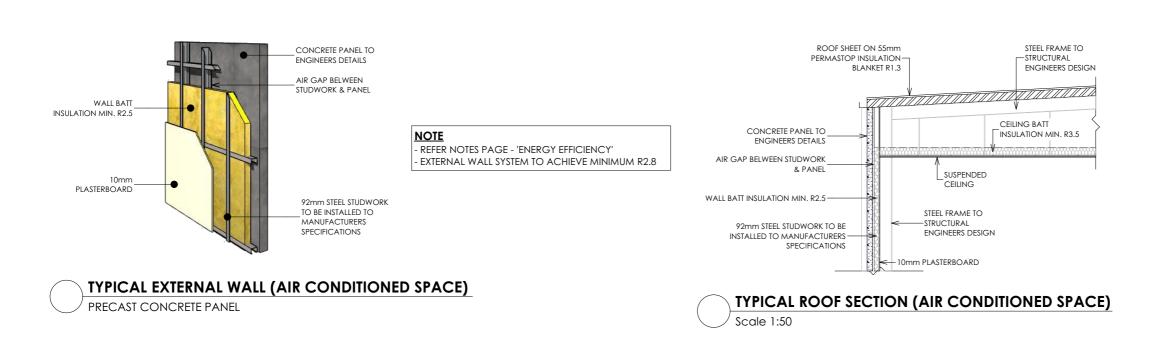

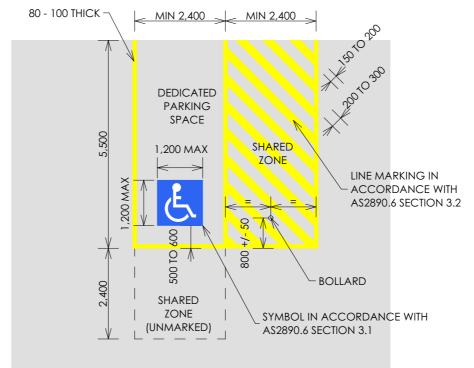



790 - 810

MIN 600

95 - 99.67%

200 - 250



MC

MC

MC

DRAWN

01.12.20 FIRE ENGINEERED SOLUTION

19.10.20 ORIGINAL ISSUE


REV. DATE DESCRIPTION


12.10.20 CLIENT & CERTIFIER COMMENT

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ENGINEERING SOLUTIONS



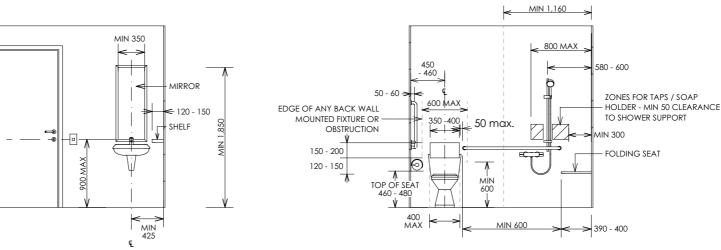

ELEVATION 1 ELEVATION 3

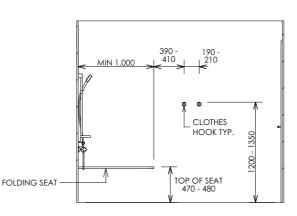NOTE:

SPACE

CLOTHES HOOK

PAN CIRCULATION

DOOR CIRCULATION

SPACE

SHOWER CIRCULATION SPACE

110 >

PLANS OF TYPICAL AMENITIES SHOWING MINIMUM CIRCULATION SPACE, OFFSETS & REQUIRED CLEARANCES. REFER FLOOR PLANS FOR PROJECT AMENITIES DIMENSIONS AND LAYOUT.

SHOWER CIRC'N 1600

DOOR CIRC'C MIN 1,470

850 MIN

CLEAR

TYPICAL ACCESSIBLE WC & SHOWER

PAN CIRC'N MIN 1900

BASIN MIN 450

425 MIN

BASIN CIRC'N MIN 850

CIRCULATION

SPACE

450 - 460

Scale 1:50

ELEVATION 2

240

MIN 440

TOILET PAPER

DISPENSER -

ZONE

KNEE / TOE CLEARANCE

200

ELEVATION 4

PROPOSED INDUSTRIAL UNITS Project Address

GCA Engineering Solutions

Thornton NSW 2322 Ph 02 4964 1811

www.gca.net.au

Project Title

1 Hartley Drive (PO Box 3337),

14D COBBANS CLOSE **BERESFIELD**

Client

PRECINCT GROUP

Project Status

COMPLYING DEVELOPMENT

Drawing Title

DETAILS

Project No.	Revision	Drawing No.
20322A	3	CD09


Drawings scaled to an A3 sheet

20322A CDr3.pln Last saved on 1/12/2020 by Mark

WALL MOUNTED FIXTURE

OR OBSTRUCTION EXCEPT



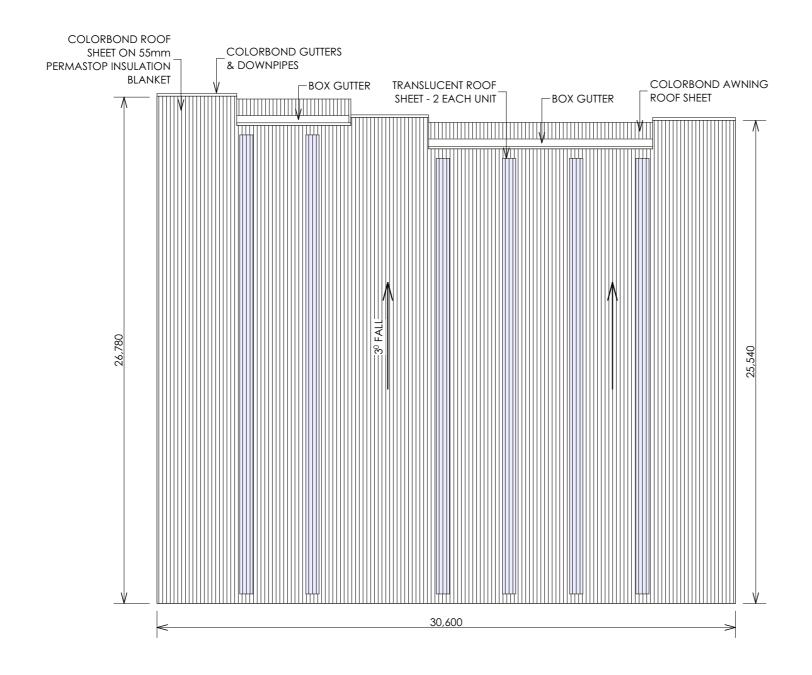





 3
 01.12.20
 FIRE ENGINEERED SOLUTION
 MC

 2
 12.10.20
 CLIENT & CERTIFIER COMMENT
 MC

 1
 19.10.20
 ORIGINAL ISSUE
 MC

 REV.
 DATE
 DESCRIPTION
 DRAWN



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Project Title

PROPOSED INDUSTRIAL UNITS

Project Address

14D COBBANS CLOSE BERESFIELD

Client

PRECINCT GROUP

Project Status


COMPLYING DEVELOPMENT

Drawing Title

ROOF PLAN


Project No. Revision Drawing No. 20322A 3 CD10

Drawings scaled to an A3 sheet

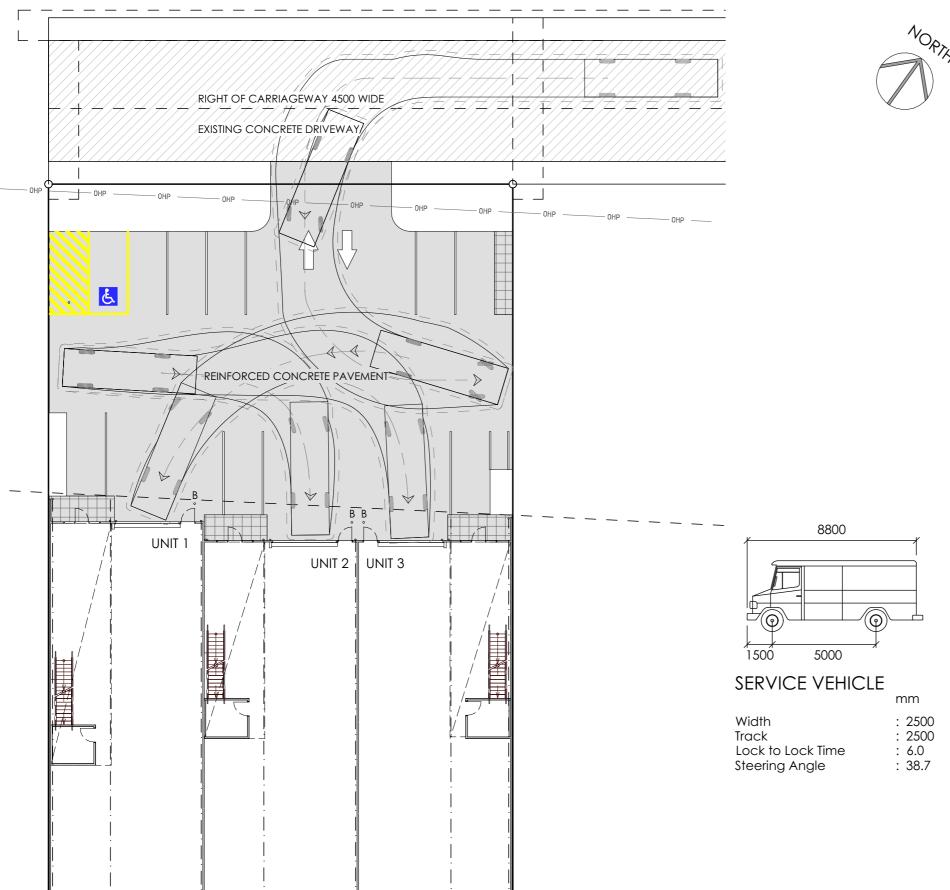

VEHICLE MOVEMENT PLAN

Scale 1:250

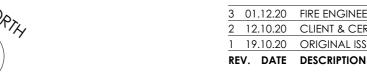

<u> </u>	19.10.20	ORIGINAL ISSUE	MC
	10 10 00	ORIGINAL ISSUE	MC
2	12.10.20	CLIENT & CERTIFIER COMMENT	МС
3	01.12.20	FIRE ENGINEERED SOLUTION	МС



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Project Title

PROPOSED INDUSTRIAL UNITS

Project Address

14D COBBANS CLOSE **BERESFIELD**

Client

PRECINCT GROUP

Project Status

COMPLYING DEVELOPMENT

Drawing Title


VEHICLE MOVEMENT PLAN

Project No. Revision Drawing No. 20322A 3 **CD11**

Drawings scaled to an A3 sheet

20322A CDr3.pln Last saved on 1/12/2020 by Mark

2 0 2 4 6 8 10m

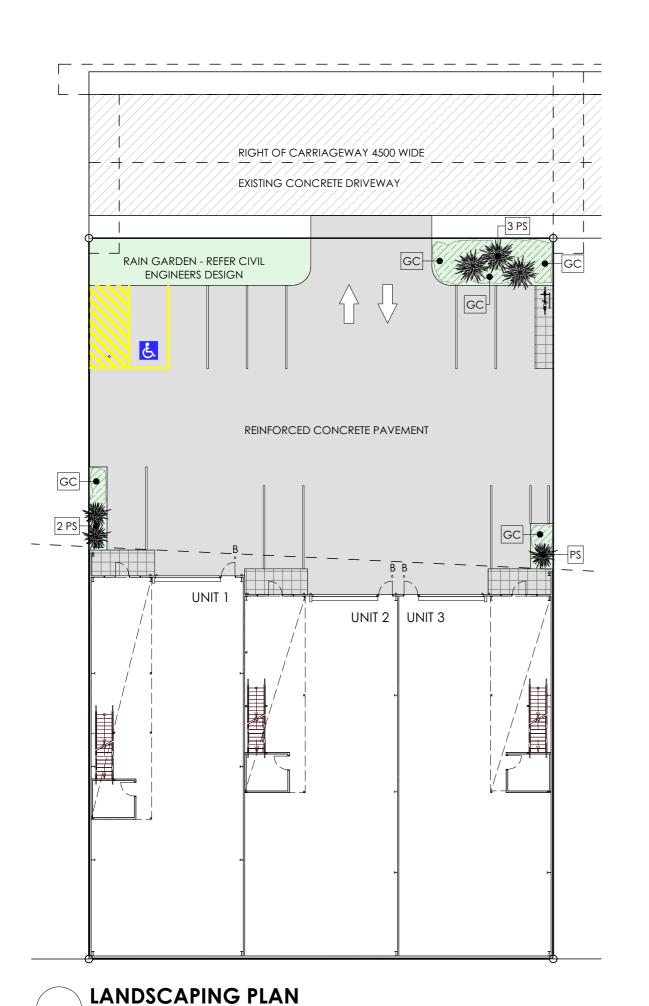

Scale 1:250



V DATE	DESCRIPTION	DRAWN
19.10.20	ORIGINAL ISSUE	МС
12.10.20	CLIENT & CERTIFIER COMMENT	МС
01.12.20	FIRE ENGINEERED SOLUTION	МС

Berry Park Landscaping

Pty Ltd ABN: 20 003 448 888 PO Box 77, Morpeth NSW 2321 PH: 02 4930 5138 FAX: 02 4930 5139



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LEGEND



PURPLE FOUNTAIN GRASS



GROUND COVER MASS PLANTING



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Project Title

PROPOSED INDUSTRIAL UNITS

Project Address

14D COBBANS CLOSE **BERESFIELD**

Client

PRECINCT GROUP

Project Status

COMPLYING DEVELOPMENT

Drawing Title

LANDSCAPING PLAN

Drawing No. Project No. Revision 20322A 3 **CD12**

Drawings scaled to an A3 sheet

20322A CDr3.pln Last saved on 1/12/2020 by Mark


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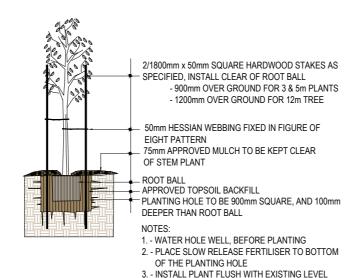
8 10m


LANDSCAPING

- L1. ALL EXISTING TREES MARKED FOR RETENTION SHALL BE PROTECTED FOR THE DURATION OF BUILDING WORKS. REMOVE FROM SITE ALL PERENNIAL WEEDS SUCH AS OXALIS, ONION WEED AND THE LIKE.
- NO REGRADING IS TO BE CARRIED OUT WITHIN THE DRIP LINE OF THE TREES TO BE RETAINED. WHERE EXCAVATION IS NECESSARY USE HAND METHODS TO AVOID DAMAGE TO THE ROOT SYSTEM, DO NOT CUT ROOTS GREATER THAN 50MM, CUT ROOTS CLEANLY WITH A SAW AND DO NOT SEAL THE WOUND.
- DO NOT STORE, STOCKPILE, DUMP OR OTHERWISE REPLACE UNDER OR NEAR TREES, BULK MATERIALS AND HARMFUL MATERIALS INCLUDING OIL, PAINT, WASTE CONCRETE, CLEARINGS, BOULDERS AND THE LIKE. DO NOT PLACE SPOIL FROM EXCAVATIONS AGAINST TREE TRUCKS, EVEN FOR SHORT PERIODS. PREVENT WIND-BLOWN MATERIALS SUCH AS CEMENT FROM HARMING TREES
- PREVENT DAMAGE TO TREE BARK. DO NOT ATTACH STAYS, GUYS AND THE LIKE
- DO NOT REMOVE TOPSOIL FROM WITHIN THE DRIP LINE OF TREES UNLESS OTHERWISE SPECIFIED. IF IT IS NECESSARY TO EXCAVATE WITH IN THE DRIP LINE USE HAND METHODS SUCH THAT ROOT SYSTEMS ARE PRESERVED, INTACT AND UNDAMAGED
- AVOID COMPACTION OF THE GROUND UNDER TREES. IF THE GROUND UNDER TREES HAS BEEN UNDULY COMPACTED DURING THE WORK. LOOSEN THE SOIL
- DO NOT CUT TREE ROOTS EXCEEDING 50MM DIAMETER UNLESS PERMITTED BY THE SUPERINTENDENT. WHERE IT IS NECESSARY TO CUT TREE ROOTS, USE A CHAINSAW OR SIMILAR MEANS SUCH THAT THE CUTTING DOES NOT UNDULY DISTURB OR ROCK THE REMAINING ROOT SYSTEMS. IMMEDIATELY AFTER CUTTING, APPLY AN APPROVED BITUMINOUS FUNGICIDAL SEALANT TO THE CUT SURFACE TO PREVENT THE INCURSION OF ROT OR DISEASE.
- THOROUGHLY CULTIVATE THE SUBSOIL TO THE DEPTHS SPECIFIED.
- TREE PLANTING AREAS TO BE MOUNDED 300MM ABOVE EXISTING GROUND LINE TO IMPROVE DRAINAGE FROM PLANTING HOLES. TREE HOLES TO BE EXCAVATED 2 TIMES LARGER THAN THE ROOTBALL AND BACKFILLED.
- SUPPLY AND PLACE 75MM LAYER OF HARDWOOD HORTICULTURAL GRADE MULCH (GRADED IN SIZE 15MM x 15MM x 15MM. FREE FROM WOOD SLIVERS.) SET DOWN 25MM FROM ADJACENT PAVING
- APPLY SHIRLEYS NO.17 LAWN FERTILISER OR SIMILAR TO SOIL, APPLIED IN ACCORDANCE WITH THE MANUFACTURERS INSTRUCTIONS.
- L12. ALL PLANTS SHALL BE TRUE TO TYPE OF HEALTHY GROWTH DISEASE FREE NURSERY STOCK AND NOT DISPLAYING RESTRICTED GROWTH PATTERNS. SHOULD THERE BE A REQUIREMENT FOR SUBSTITUTIONS THEY SHALL NOT BE CHANGED WITHOUT PRIOR APPROVAL. NO VARIEGATED STRAIN SHALL BE USED. ALLOW FOR SLOW RELEASE FERTILISER TO ALL PLANTINGS APPLIED AT THE MANUFACTURES RECOMMENDED RATE TO BE SAME OR SIMILAR TO OSMOCOTE.





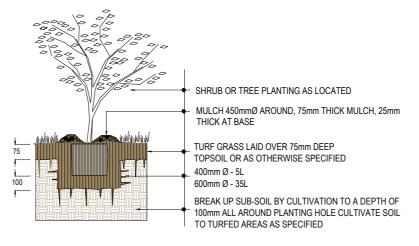

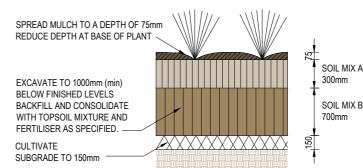





3 01.12.20 FIRE ENGINEERED SOLUTION

Berry Park Landscaping

ABN: 20 003 448 888

PO Box 77, Morpeth NSW 2321

PH: 02 4930 5138 FAX: 02 4930 5139

19.10.20 ORIGINAL ISSUE

REV. DATE DESCRIPTION

12.10.20 CLIENT & CERTIFIER COMMENT

MC

MC

MC

DRAWN



ENGINEERING SOLUTIONS

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Project Title

PROPOSED INDUSTRIAL UNITS

Project Address

14D COBBANS CLOSE BERESFIELD

Client

PRECINCT GROUP

Proiect Status

COMPLYING DEVELOPMENT

Drawing Title

LANDSCAPING **DETAILS & NOTES**

Project No. Revision Drawing No. 20322A 3 **CD13**

Drawings scaled to an A3 sheet

SOIL MIX A SOIL MIX B

STAKING & TYING PLANTS WITH GRATE NOT TO SCALE

4. - PLANT TO BE PLACED AS SPECIFIED

TYPE	CVAADOL	BOTANICAL NAME COMMON NA	COMMON NAME	MATUF		OHANITITY	DOT CITE
ITFE	STMBOL	BOTANICAL NAME	COMMON NAME	HEIGHT (m)	SPREAD (m)	QUANTITY	POT SIZE
SHRUBS	PS	Pennisetum setaceum	PURPLE FOUNTAIN GRASS	3	2		200mm
MASS PLANTING -	- GC	Hardenbergia violacea	NATIVE SARSAPARILLA	0.5			
		Dianella hybrid	SILVER STREAK	0.6			
SELECT FROM:		Lomandra confertifolia	DWARF MAT RUSH	0.5		1 PLANT	TUBE
		Dianella caerulea	BLUE FLAX LILY	1		PER m ²	STOCK
		Lomandra longifolia	SPINY-HEAD MAT-RUSH	1			
		Isolepis nodosa	KNOBBY CLUB RUSH	1.5			

GENERAL

- G1. ALL EXISTING UNDERGROUND SERVICES MUST BE LOCATED AND EXPOSED PRIOR TO EARTHWORKS COMMENCING AND IT IS THE RESPONSIBILITY OF THOSE PERSONS USING THIS PLAN TO CONFIRM BOTH POSITION & LEVEL OF THESE UTILITIES IN CONJUNCTION WITH THE APPROPRIATE AUTHORITY.
- G2. THE BUILDER SHALL CHECK AND VERIFY ALL DIMENSIONS AND VERIFY ALL ERRORS AND OMISSIONS TO THE DESIGNER. DO NOT SCALE THE DRAWINGS. DRAWINGS SHALL NOT BE USED FOR CONSTRUCTION PURPOSES UNTIL ISSUED BY THE DESIGNER FOR CONSTRUCTION.
- G3. WRITTEN DIMENSIONS TO TAKE PRECEDENCE OVER SCALED MEASUREMENTS. IF IN DOUBT REFER TO DESIGNER.
- G4. EMERGENCY LIGHTING & EXIT / EXIT DIRECTION SIGNAGE TO BE INSTALLED TO ALL EGRESS PATHS & INTERNAL STAIRWAYS IN ACCORDANCE WITH AS2293.1-2018 & BCA CLAUSES E4.2, E4.4, E4.5, E4.6 & E4.8.
- G5. AMENITIES TO BE MECHANICALLY VENTILATED.
- G6. ALL GLAZED ASSEMBLIES TO COMPLY WITH AS1288-2006 AND AS2047-2014 (AS APPLICABLE).
- G7. ALL NEW FLOOR LININGS, FLOOR COVERINGS, WALL LININGS & CEILING LININGS TO COMPLY WITH BCA CLAUSE C1.10.
- G8. EXIT TRAVEL DISTANCES TO BE IN ACCORDANCE WITH BCA CLAUSE D1.4.
- G9. THE MINIMIUM UNOBSTRUCTED HEIGHT OF ANY REQUIRED EXIT OR PATH OF TRAVEL TO BE 2000mm THROUGHOUT EXCEPT DOORWAYS (MIN 1980mm) IN ACCORDANCE WITH BCA PART D1.6
- G10. WHERE APPLICABLE TACTILE INDICATORS TO BE PROVIDED TO INTERNAL STAIRWAYS (TOP & BOTTOM LANDINGS).
- G11. WHERE APPLICABLE LIFTS TO COMPLY WITH CLAUSES 3.1, 3.3, TABLES E3.6a & E3.6b OF THE BCA AND AS 1735.12. MINIMUM DIMENSIONS 1100mm WIDE x 1400mm DEEP WITH 900mm CLEAR OPENING.
- G12. WET AREAS TO BE WATERPROOFED IN ACCORDANCE WITH BCA TABLE F1.7 & AS3740-2010.
- G13. WINDOWS & EXTERNAL SLIDING FRAMED GLAZED DOORS TO COMPLY WITH AS2047-2014.
- G14. ARTIFICIAL LIGHTING TO BE PROVIDED IN ACCORDANCE WITH BCA PART F4.4 & TO COMPLY WITH AS/NZS1680.0-2009
- G15. MECHANICAL VENTILATION TO COMPLY WITH AS1668.2-2012.
- G16. WHERE APPLICABLE ALL BALUSTRADES TO MEZZANINE FLOOR & STAIRWAYS TO COMPLY WITH BCA CLAUSES D2.16-D2.18, AS1170.1, AS1657 & AS1428.1.
- G17. STAIRWAYS TO COMPLY WITH BCA CLAUSE D2.13, TABLE D2.13, CLAUSE D2.14 AND TABLE D2.14
- G18 DOORS IN A REQUIRED EXIT, FORMING PART OF A REQUIRED EXIT OR IN THE PATH OF A REQUIRED EXIT TO COMPLY WITH BCA CLAUSE D2.21 OPERATION OF LATCH
- G19. DAMP-PROOFING TO BE IN ACCORDANCE WITH AS2904 DAMP-PROOF COURSES AND FLASHINGS OR AS3660.1 TERMITE MANAGEMENT NEW BUILDING WORK.
- G20 CAR PARKING & DRIVEWAY LAYOUT TO COMPLY WITH AS2890.1-2004.
- G21. CONSTRUCTION OF SANITARY COMPARTMENTS TO COMPLY WITH BCA CLAUSE F2.5.
- G22. OUTDOOR LIGHTING TO COMPLY WITH AS 4282-1997
- G23. TERMITE RISK MANAGEMENT SYSTEM TO BE PLACED IN ACCORDANCE WITH BCA CLAUSE BI.4 & AS 3660.1
- G24. PORTABLE FIRE EXTINGUISHERS ARE TO BE PROVIDED IN ACCORDANCE WITH BCA CLAUSE E1.6

ENERGY EFFICIENCY

- E1. THERMAL CONSTRUCTION TO AIR CONDITIONED SPACE INSULATION MUST BE INSTALLED IN ACCORDANCE WITH BCA CLAUSE 1.2 & COMPLY WITH AS4859.1.
- E2. ROOF & CEILING TO ACHIEVE THE MINIMUM TOTAL "R" VALUE OUTLINED IN TABLE BCA J1.3. CONSTRUCTION OF ROOF TO COMPLY WITH BCA CLAUSE J3.6 (TYPICALLY R3.2) REFER DETAILS.
- E3. GLAZING TO COMPLY WITH BCA CLAUSE J2.3 & J2.4. REFER GLAZING CALCULATED DATA SHEET (AIR CONDITIONED SPACE ONLY) & AS1288-2006.
- E4. EXTERNAL DOORS TO AIR CONDITIONED SPACE BE SELF CLOSING & SEALED IN ACCORDANCE WITH BCA CLAUSE J3.4.
- E5. AIR CONDITIONING TO COMPLY WITH BCA PART J5.
- 6. NATURAL LIGHTING TO COMPLY WITH BCA CLAUSES F4.2, 4.3 & 4.4.
- E7. ARTIFICIAL INTERIOR LIGHTING TO COMPLY WITH A\$1680 & BCA CLAUSES J6.2-6.4.
- E8. ARTIFICIAL EXTERIOR LIGHTING TO COMPLY WITH BCA CLAUSE J6.5.
- VENTILATION TO COMPLY WITH BCA CLAUSES J4.5-4.7.
- HOT WATER SYSTEM TO BE INSTALLED IN ACCORDANCE WITH SECTION 8 AS3500.4 & BCA PART J7.
- E11. EXTERNAL WALLS TO ACHIEVE MINIMUM TOTAL "R" VALUE OUTLINED IN TABLE BCA J1.5b REFER DETAILS.

ACCESSIBILITY

- A1. DISABLED ACCESS TO BE PROVIDED IN ACCORDANCE WITH BCA PART D3 & AS1428.1.
- A2. STAIRWAYS TO COMPLY WITH AS1428.1 INCLUDING COMPLIANT RISERS, CONTRASTING NOSE STRIP & TACTILE INDICATORS AT TOP & BOTTOM LANDINGS
- A3. DOORWAYS TO HAVE MINIMUM CLEAR WIDTH OF 850mm (MINIMUM 920 LEAF DOOR)
- A4. DOOR HANDLES TO BE:
 - D-TYPE LEVER HANDLES LOCATED BETWEEN 900-1100mm HEIGHT.
 - CLEARANCE BETWEEN GRIP AND DOOR FACE TO BE 35-45mm IN ACCORDANCE WITH BCA PART D2.22
 - OPENABLE FROM THE SIDE FACING A PERSON SEEKING EGRESS WITHOUT A KEY
- A5. MINIMUM CLEAR WIDTH OF ACCESS WAYS TO BE 1000mm.
- A6. DOORWAYS INTO & WITHIN THE BUILDING TO HAVE MINIMUM LUMINANCE CONTRAST OF 30% PROVIDED BETWEEN DOOR & JAMB/WALL MINIMUM WIDTH 50mm IN ACCORDANCE WITH AS1428.1 CLAUSE 13.1.
- A7. FLOOR & GROUND SURFACES TO COMPLY WITH AS1428.1 CLAUSE 7.
- A8. CARPET AS1428.1 DOES NOT APPLY. CARPET PILE/BACKING THICKNESS AND HEIGHT TO BE IN ACCORDANCE WITH BCA PART D3.3 (g) & (h).
- A9. TACTILE INDICATORS TO BE PROVIDED & INSTALLED IN ACCORDANCE WITH A\$1428.4.
- A10 ALL GLAZING ON ACCESSWAYS TO BE CLEARLY MARKED WITH A MIN 75mm WIDE VISION STRIP IN ACCORDANCE WITH BCA PART D3.12 & AS1428.1 CLAUSE 6.6
- A11. DISABLED TOILET TO BE CONSTRUCTED IN ACCORDANCE WITH A\$1428.1.

FIXTURES TO WC				
GRAB RAILS				
DIAMETER	Ø30-40mm			
HEIGHT	800-810mm			
HAND BASIN	LIP 770-800mm			
TOILET ROLL HOLDER	700mm MAX			
MIRROR	900-1850mm			
SOAP DISPENSER	1000-1100mm			
SHOWER				
BASE OF ADJUSTMENT	1000-1100mm			
TOP	1880-1900mm			
FLUSH CONTROL	1100 MAX			
DOOR LOCK	ONE HAND UNLOCK			
	900-1100mm			
DOOR SWING	OUTWARD/SLIDER			
FLOOR SURFACE	SLIP RESISTANT			
GRADIENT				
SHOWER	1:50-1:60			
CIRC. AREA	1:70-1:80			
ELECTRICAL OUTLET	900-1100mm			
HEIGHT				
SIGN	DISABLED BRAILLE AS PER			
	AS1428.1 14.4/5			
LUMINANCE CONTRAST	MIN DIFFERENTIAL 30%			
	AS PER AS1428.1 CLAUSE			
	15.2.3			
FINISHED FLOOR	MAX 3mm AS PER			
DIFFERENTIAL SURFACES	AS1428.1 Section 7			
TACTILE INDICATORS	AS PER BCA PART D3.8			
CIRCULATION SPACE	2300 x 1900mm M IN			

RF	V DATE	DESCRIPTION	DRAWN
1	19.10.20	ORIGINAL ISSUE	МС
2	12.10.20	CLIENT & CERTIFIER COMMENT	МС
3	01.12.20	FIRE ENGINEERED SOLUTION	MC





ENGINEERING SOLUTIONS

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Project Title

PROPOSED INDUSTRIAL UNITS

Project Address

14D COBBANS CLOSE BERESFIELD

Client

PRECINCT GROUP

Project Status

COMPLYING DEVELOPMENT

Drawing Title

NOTES

Project No. Revision 20322A 3

ision Drawing No.

CD14

Drawings scaled to an A3 sheet