Address: 13-35 MACKEY ST, NORTH GEELONG. VIC

Client: TRIBAL CAMPUS

**Drawing Issue:** ISSUE FOR BUILDING PERMIT

Issue Date: DECEMBER 2016

### GENERAL NOTES (NCC 2015 BCA VOL 1)

ALL MATERIALS AND WORK PRACTICES SHALL COMPLY WITH, BUT NOT LIMITED TO THE BUILDING REGULATIONS 2006, THE NATIONAL CONSTRUCTION CODE SERIES 2015 BUILDING CODE OF AUSTRALIA VOLUME 1 AND ALL RELEVANT CURRENT AUSTRALIAN STANDARDS (AS

UNLESS OTHERWISE SPECIFIED, THE TERM BCA SHALL REFER TO NATIONAL CONSTRUCTION CODE SERIES 2015 BUILDING CODE OF AUSTRALIA VOLUME 1.

ALL MATERIALS AND CONSTRUCTION PRACTICE SHALL MEET THE PERFORMANCE REQUIREMENTS OF THE BUILDING CODE OF AUSTRALIA. WHERE AN ALTERNATIVE SOLUTION IS PROPOSED THEN PRIOR TO IMPLEMENTATION OR INSTALLATION IT FIRST MUST BE ASSESSED AND APPROVED BY THE RELEVANT BUILDING SURVEYOR AS MEETING THE PERFORMANCE REQUIREMENTS OF THE BUILDING CODE OF AUSTRALIA.

STEP SIZES (OTHER THAN FOR SPIRAL STAIRS) TO BE: RISERS (R) 190MM MAXIMUM AND 115MM MINIMUM

- GOING (G) 355MM MAXIMUM AND 240MM MINIMUM
- 2R + 1G = 700MM MAXIMUM AND 550MM MINIMUM WITH LESS THAN 125MM GAP BETWEEN OPEN TREADS
- ALL TREADS, LANDINGS AND THE LIKE TO HAVE NON SLIP FINISH OR SUITABLE NON-SKID STRIP NEAR EDGE OF NOSING.

PROVIDE BALUSTRADES WHERE CHANGE IN LEVEL EXCEEDS 1000MM ABOVE THE SURFACE BENEATH LANDINGS, RAMPS AND/OR TREADS, BALUSTRADES (OTHER THAN TENSIONED WIRE BALUSTRADES) TO BE: 1000MM MIN. ABOVE FINISHED SURFACE LEVEL OF BALCONIES, LANDINGS OR THE LIKE, AND

865MM MIN. ABOVE FINISHED SURFACE LEVEL OF STAIR NOSING OR RAMP, AND VERTICAL WITH LESS THAN 125MM GAP BETWEEN, AND

ANY HORIZONTAL ELEMENT WITHIN THE BALUSTRADE BETWEEN 150MM AND 760MM ABOVE THE FLOOR MUST NOT FACILITATE CLIMBING WHERE CHANGES IN LEVEL EXCEEDS 4000MM ABOVE THE SURFACE BENEATH LANDINGS, RAMPS AND/OR TREADS. WIRE BALUSTRADE CONSTRUCTION TO COMPLY WITH BCA PART 3.9.2.3 FOR CLASS 1 AND 10 BUILDINGS AND NCC 2012 BCA VOLUME 1

TOP OF HAND RAILS TO BE MINIMUM 865MM ABOVE STAIR NOSING AND FLOOR SURFACE OF RAMPS.

WINDOW SIZES NOMINATED ARE NOMINAL ONLY. ACTUAL SIZE MAY VARY ACCORDING TO MANUFACTURER. WINDOWS TO BE FLASHED ALL AROUND.

WATERPROOFING OF WET AREAS TO COMPLY WITH BCA PART F1.7

FOR BUILDINGS IN MARINE OR OTHER EXPOSURE ENVIRONMENTS SHALL HAVE MASONRY UNITS, MORTAR AND ALL BUILT IN COMPONENTS AND THE LIKE COMPLYING WITH THE DURABILITY REQUIREMENTS OF AS3700-2011 MASONRY STRUCTURES

ALL STORM WATER TO BE TAKEN TO THE LEGAL POINT OF DISCHARGE TO THE RELEVANT AUTHORITIES' APPROVAL

THESE DRAWINGS SHALL BE READ IN CONJUNCTION WITH ALL ARCHITECTURAL SPECIFICATIONS, RELEVANT STRUCTURAL AND ALL OTHER CONSULTANTS' DRAWINGS/DETAILS AND SPECIFICATIONS AND WITH ANY OTHER WRITTEN INSTRUCTIONS ISSUED IN THE COURSE OF THE

ALL MEASUREMENTS AND LEVELS IN MILLIMETRES U.N.O.

FIGURED DIMENSIONS TAKE PRECEDENCE OVER SCALED DIMENSIONS

THE BUILDER SHALL TAKE ALL STEPS NECESSARY TO ENSURE THE STABILITY AND GENERAL WATER TIGHTNESS OF ALL NEW AND/OR EXISTING STRUCTURES AND ALL ESSENTIAL SERVICES TO BE MAINTAINED DURING ALL WORKS

THE BUILDER AND SUBCONTRACTORS SHALL CHECK AND VERIFY ALL DIMENSIONS, SETBACKS, LEVELS AND SPECIFICATIONS AND ALL OTHER RELEVANT DOCUMENTATION PRIOR TO THE COMMENCEMENT OF ANY WORKS. REPORT ALL DISCREPANCIES TO THIS OFFICE FOR CLARIFICATION.

INSTALLATION OF ALL SERVICES SHALL COMPLY WITH THE RESPECTIVE SUPPLY AUTHORITY REQUIREMENTS.

THE BUILDER AND SUBCONTRACTOR SHALL ENSURE THAT ALL STORM WATER DRAINS, SEWER PIPES AND THE LIKE ARE LOCATED AT A SUFFICIENT DISTANCE FROM ANY BUILDINGS FOOTING AND/OR SLAB EDGE BEAMS SO AS TO PREVENT GENERAL MOISTURE PENETRATION, DAMPNESS, WEAKENING AND UNDERMINING OF ANY BUILDING AND ITS FOOTING SYSTEM 100 MM DIA. CLASS 6 UPVC STORMWATER LINE LAID TO A MINIMUM GRADE OF 1:100 AND CONNECTED TO THE LEGAL POINT OF STORMWATER DISCHARGE. PROVIDE INSPECTION OPENINGS AT 9000MM C/C AND AT EACH CHANGE OF DIRECTION.

THE COVER TO UNDERGROUND STORMWATER DRAINS SHALL BE NOT LESS THAN

100MM UNDER SOIL 50MM UNDER PAVED OR CONCRETE AREAS

100MM UNDER UNREINFORCED CONCRETE OR PAVED DRIVEWAYS 75MM UNDER REINFORCED CONCRETE DRIVEWAYS

THESE PLANS HAVE BEEN PREPARED FOR THE EXCLUSIVE USE BY THE CLIENT OF Another Dimension Building Design ('THE DESIGNER') FOR THE PURPOSE EXPRESSLY NOTIFIED TO THE DESIGNER, ANY OTHER PERSON WHO USES OR RELIES ON THESE PLANS WITHOUT THE DESIGNER'S WRITTEN CONSENT DOES SO AT THEIR OWN RISK AND NO RESPONSIBILITY IS ACCEPTED BY THE DESIGNER FOR SUCH USE AND/OR RELIANCE.

USE OR A CONTRACT VARIATION. ANY SAID VARIATIONS MUST BE ACCEPTED BY ALL PARTIES TO THE AGREEMENT AND WHERE APPLICABLE THE RELEVANT BUILDING SURVEYOR PRIOR TO IMPLEMENTING THE SAID VARIATION.

ELECTRICAL SWITCHBOARDS LOCATED IN THE PATH OF TRAVEL TO EXITS TO BE ENCLOSED IN A METAL OR OTHER NON COMBUSTIBLE CABINET WITH SMOKE PROOF DOORS. SIGNIFICANT SWITCHBOARDS SHALL BE PROVIDED WITH A 5KG CARBON DIOXIDE EXTINGUISHER OR ANOTHER TYPE OF EXTINGUISHER WITH A MINIMUM CLASSIFICATION OF 1A:E AND FITTED WITH A HOSE COMPLETE WITH EXTINGUISHER IDENTIFICATION SIGNAGE AND SHALL BE LOCATED BETWEEN 2M AND 20M FROM THE SIGNIFICANT SWITCHBOARD.

FIRE HAZARD PROPERTIES OF MATERIALS AND ASSEMBLIES TO COMPLY WITH BCA SPECIFICATION C1.10.

MECHANICAL VENTILATION OR AIR-CONDITIONING OF ROOMS TO BE PROVIDED WITH A SYSTEM COMPLYING WITH AS1668.2 AND AS/NZS 3666.1 AS AMENDED. EXHAUST OUTLETS TO BE LOCATED NO CLOSER THAN 6.0M TO FRESH AIR INLETS.

PERSONAL LOADING: BASED ON SANITARY FACILITIES PROVIDED PER BCA TABLE. F2.3

BUILDING CLASSIFICATION: Class 9b – Assembly building (public halls, function rooms or the like) PER TENANCY NUMBERS MALE PATRONS:

FEMALE PATRONS: 25 MAX 50 MAX TOTAL PATRONS:

# **GENERAL NOTES:**

BUILDER TO IMPLEMENT A SITE SAFETY MANAGEMENT PLAN DURING THE BUILDING WORKS INCLUDING DEMOLITION AND PROPOSED WORKS.

ANY OPENINGS TO BE FORMED IN EXISTING WALLS TO BE CHECKED BY A STRUCTURAL ENGINEER FOR ADEQUACY OF EXISTING STRUCTURE/LINTELS.

ALL WASTE AND RUBBLE TO BE CONTAINED ON SITE AND DUST ATTENUATION PROCEDURES TO BE IN PLACE WHEN CUTTING BRICKWORK AND CONCRETE (IE, WATER FEED TO SAWS ETC) TO ELIMINATE DISRUPTION TO NEIGHBOURING TENANCIES.

NOISY WORKS TO BE CONDUCTED DURING NORMAL BUSINESS HOURS, 9AM - 5PM, NO NOISY WORKS TO BE CARRIED OUT OUTSIDE OF THESE TIMES.

EXISTING BRICK WALLS AND STEEL COLUMNS TO REMAIN UNLESS OTHERWISE NOTED, BRICKWORK TO BE CLEANED TO AN ACCEPTABLE LEVEL FOR EXPOSED PRESENTABLE FINISH TO INTERIOR FACES.

### **EXISTING CONDITIONS & SITE CONFIRMATION NOTE:**

ALL DIMENSIONS TO BE CHECKED AND CONFIRMED ON SITE PRIOR TO ANY WORKS COMMENCING, WHERE DISCREPANCIES MAY ARISE IN PLACEMENT OF WINDOWS AND DOORS AS A RESULT OF EXISTING CONDITIONS, THE BUILDER/OWNER TO MAKE ADJUSTMENTS TO SIZES AS REQUIRED TO SUIT THE PROPOSED WORKS, ANY DISCREPANCIES AFFECTING DOORS AND OPENING CLEARANCES ARE TO BE CLARIFIED WITH HE BUILDING SURVEYOR TO CONFIRM ADEQUATE CLEARANCES ARE ACHIEVED FOR DISABILITY ACCESS.

## **WALL & CEILING NOTES:**

ALL EXISTING ROOF SHEETING TO BE ASSESSED AND ANY ROOF SHEETS WITH HOLES TO BE REPLACED TO PROVIDE WATERTIGHT BUILDING.

PROVIDE ACOUSTIC INSULATION BATTS (9kg/m²) TO WALL CAVITIES OF AMENITIES PRIOR TO INSTALLATION OF PLASTERBOARD WALL LINING.

PLASTERBOARD CEILINGS TO BE FLUSH STOPPED AT ALL JUNCTIONS, WHERE PLASTERBOARD MEETS BRICKWORK PROVIDE TIMBER STOPPING BEAD TO ENABLE SQUARE STOPPED FINISH ALONG BRICKS.


EXISTING STEEL TRUSSES TO BE WIRE BRUSHED AND HAVE NEW PAINT FINISH APPLIED TO FRESHEN UP.

PROVIDE MECHANICAL VENTILATION TO TOILETS IN THE FORM OF EXTRACTION FANS SWITCHABLE FROM THE LIGHT SWITCH COMPLYING WITH AS1668.2 AND AS/NZS 3666.1 AS AMENDED. EXHAUST OUTLETS TO BE LOCATED NO CLOSER THAN 6.0M TO FRESH AIR INLETS. PROVIDE AUTO CLOSING DAMPERS TO ALL OUTLETS

## **LIGHTING NOTES:**

ALL LIGHTING TO NEW AMENITIES AREAS TO BE RECESSED LOW VOLTAGE LED DOWNLIGHT FITTINGS.

ALL LIGHTING AND EMERGENCY LIGHTING TO BE IN ACCORDANCE WITH ELECTRICAL ENGINEER'S DOCUMENTATION.

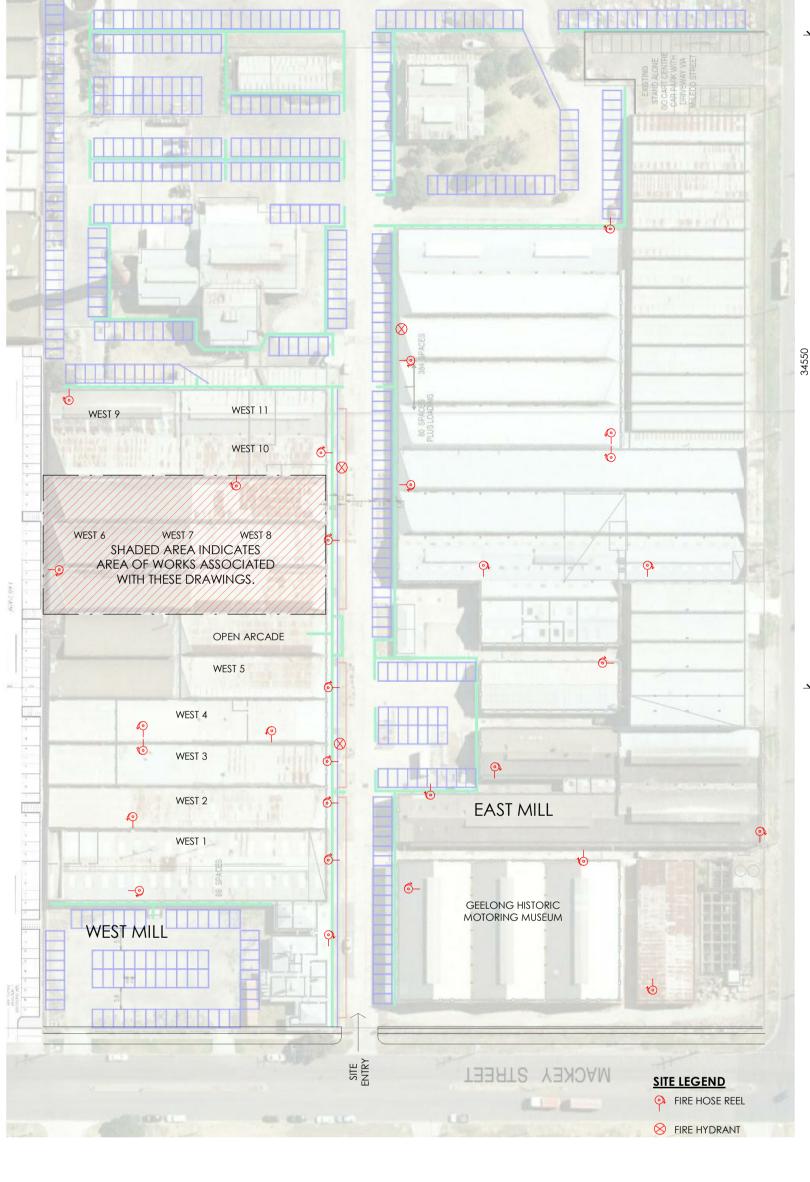

## SITE PLAN

## **ELECTRICAL NOTES:**

**HEIGHTS OF GPO'S AS FOLLOWS:** GENERALLY - 1000mm ABOVE FLOOR ABOVE BENCH - 200mm ABOVE TOP OF BENCH LEVEL EXTERNAL - 600mm ABOVE GROUND/FLOOR LEVEL

GPOS & SWITCHES TO BE HPM STANDARD PLATES, MOUNTED ON HPM MOUNTING BLOCKS IN WAREHOUSE AREA AND WALL MOUNTED IN KITCHEN AREAS, ALTERNATIVE TYPES MAY BE USED WITH APPROVAL BY

ALL WIRING IN WAREHOUSE TO BE CONDUITED OR GIRDER CLIPPED IN ACCORDANCE WITH ELCTRICAL SAFETY STANDARDS.

HEIGHTS OF ALL LIGHT SWITCHES TO BE 1100mm ABOVE

FINAL LOCATION FOR ALL ELECTRICAL AND LIGHTING FIXTURES IS TO BE CONFIRMED ON SITE WITH BUILDER, OWNER & ELECTRICIAN PRIOR TO CUTTING HOLES INTO WALLS AND CELLINGS OR RUNNING CABLING. LAYOUT TO BE MARKED OUT ON FLOOR BY ELECTRICIAN FOR REVIEW AND APPROVAL.

EMERGENCY LIGHTING TO BE "CLEVERTRONICS - LIFELIGHT" EMERGENCY LIGHTING IN ACCORDANCE WITH AS-2293.1-2005 D40 CLASSIFICATION FITTINGS SPACED AT MAXIMUM 20.1m SPACINGS IN ACCORDANCE WITH MANUFACTURERS PERFORMANCE STANDARD FOR MOUNTING HEIGHT OF 4.25m. NOTE: THE FITTINGS ARE TO BE MOUNTED TO THE UNDERSIDE OF THE ROOF TRUSSES UNDER RIDGE LINE. SUBSTITUTE FITTINGS MAY BE USED AT THE DISCRETION OF THE

BUILDING SURVEYOR.

## **ELECTRICAL & LIGHTING LEGEND:**

LED HIGHBAY LIGHT FITTING, SUNNY LIGHTING

SD SMOKE DETECTORS - HARD WIRED TO SWITCHBOARD WITH DEDICATED CIRCUIT & 9V BATTERY BACKUP.

ROOMS & ENSUITES WITH NO WINDOWS.

FITTING - TYPICAL 15W

EMERGENCY EXIT SIGNAGE TO BE "CLEVERTRONICS - CLEVERFIT" EXIT SIGNS FIXED ABOVE EXIT DOORWAYS CLEVERFIT" EXIT SIGNS FIXED ABOVE EXIT DOORWAYS IN ACCORDANCE WITH AS-2293

EXHAUST FAN - BUILDER SELECTED. DUCTED TO EXTERIOR, TO HAVE SELF CLOSING DAMPER. TO BE WIRED TO LIGHT SWITCH IN POWDER

GPO - DOUBLE

BUILDING SURVEYOR.

LED TROFFER FLUSH MOUNT LIGHTS

SWITCHBOARD - EXISTING

PRODUCT CODE: SHB130W/AR WW

O BATTEN HOLDER OR RECESSED LED LIGHT

SUBSTITUTE FITTINGS MAY BE USED AT THE DISCRETION OF THE

### NCC 2015 Volume 1, Part J6 Artificial Lighting & Power INTERNAL LIGHTING - WEST 7 PROPOSED NEW FLOOR AREA $= 784m^{2}$ LIGHTING LOAD ALLOWANCE (RETAIL SPACE) $= 22W/m^{2}$ TOTAL LIGHTING LOADING ALLOWED = 17248W PROPOSED LIGHTING: LED RECESSED & LED HIGHBAY LIGHT FITTINGS LED RECESSED LIGHT FITTINGS X 49 @ 30W = 1470W LED HIGH BAY FITTINGS X 1.5 @ 130W = 1950W = 3420W TOTAL LIGHTING PROPOSED Colour Temp. 3000K (OR SIMILAR APPROVED) LIGHTING LOAD W/pm<sup>2</sup> $= 4.36W/m^2$

LIGHTING LOAD CALCULATIONS - SPECIFICATION

VENTILATION

**WEST 6 - 11 TENANCIES PLAN** 

EXISTING CONCRETE FLOOR TO BE REPAIRED TO PROVIDE SMOOTH

EXISTING ASBESTOS CEILING TO BE REMOVED AND RELINED WITH

EXISTING FIRE RATED DOORS BETWEEN TENANCIES TO BE ASSESSED

TO BE INFILLED. INFILL BRICKWORK TO MATCH EXISTING.


FRAME WITH CLEAR GLAZING.

ANY NEW WINDOWS TO HIGHLIGHTS TO MATCH EXISTING T-BAR STYLE

MODERN EQUIVALENT WITH PAINT FINISH TO MATCH EXISTING CEILING.

FOR FUNCTIONALITY. IF DEEMED TO BE INADEQUATE, DOORWAYS ARE

EXTERNAL LIGHTING NOTE: ALL ARTIFICIAL LIGHTING (IF INSTALLED) AROUND THE PERIMETER OF THE BUILDING MUST BE CONTROLLED BY A DAYLIGHT SENSOR & A MOTION DETECTOR IN ACCORDANCE WITH SPECIFICATION J6.

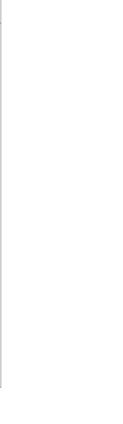

constant current LED driver

VENTILATION

8.28m<sup>2</sup>

NATURAL VENTILATION NOTE

TOTAL NATURAL VENTILATION

FLOOR AREA):

WEST 6 = 44.85m<sup>2</sup>

WEST 7 =  $39.2m^2$ 

WEST 8 = 41.3m<sup>2</sup>

WEST 9 = 37.95m<sup>2</sup>

WEST 10 =  $22.7m^2$ 

WEST 11 =  $21.5m^2$ 

AREA ACHIEVABLE:

WEST 6 = 13.86m<sup>2</sup>


WEST 7 = 14.29m<sup>2</sup>

WEST 8 = 17.25m<sup>2</sup>

WEST 9 = 13.68m<sup>2</sup>

WEST  $10 = 8.28 \text{m}^2$ 

WEST 11 = 5.78m<sup>2</sup>

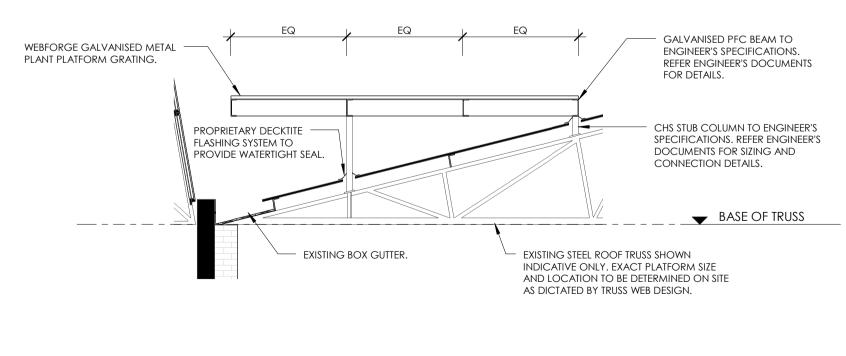

GLASS ENTRY DOORS.

VENTILATION

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THE CONTRACTOR SHALL VARIFY ALL DIMENSIONS WITH SITE CONDITIONS AND REFER ANY DISCREPANCIES TO THE BUILDER/DESIGNER PRIOR TO COMMENCING WORK.

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**PROJECT No:** 16-023

**CLIENT:** TRIBAL CAMPUS DECEMBER 2016 **PROJECT:** TRIBAL CAMPUS FITOUT

As indicated @A1 ADDRESS: 13-35 MACKEY ST, NORTH GEELONG. VIC

DRAWING LIST

COVER & SITE PLAN

A003 FURNITURE LAYOUT PLAN AMENITY DETAILS A005 REFLECTED CEILING PLAN

TILLED, SELECTED BRICK TYPE TO

VENTILATION STORE FRONT WALL. VENTILATION


PROPOSED FLOOR PLAN

REV ISSUE DATE


07/12/16 07/12/16

**DWG TITLE:** COVER & SITE PLAN

asho miceski | registered building practitioner | dp-ad 206

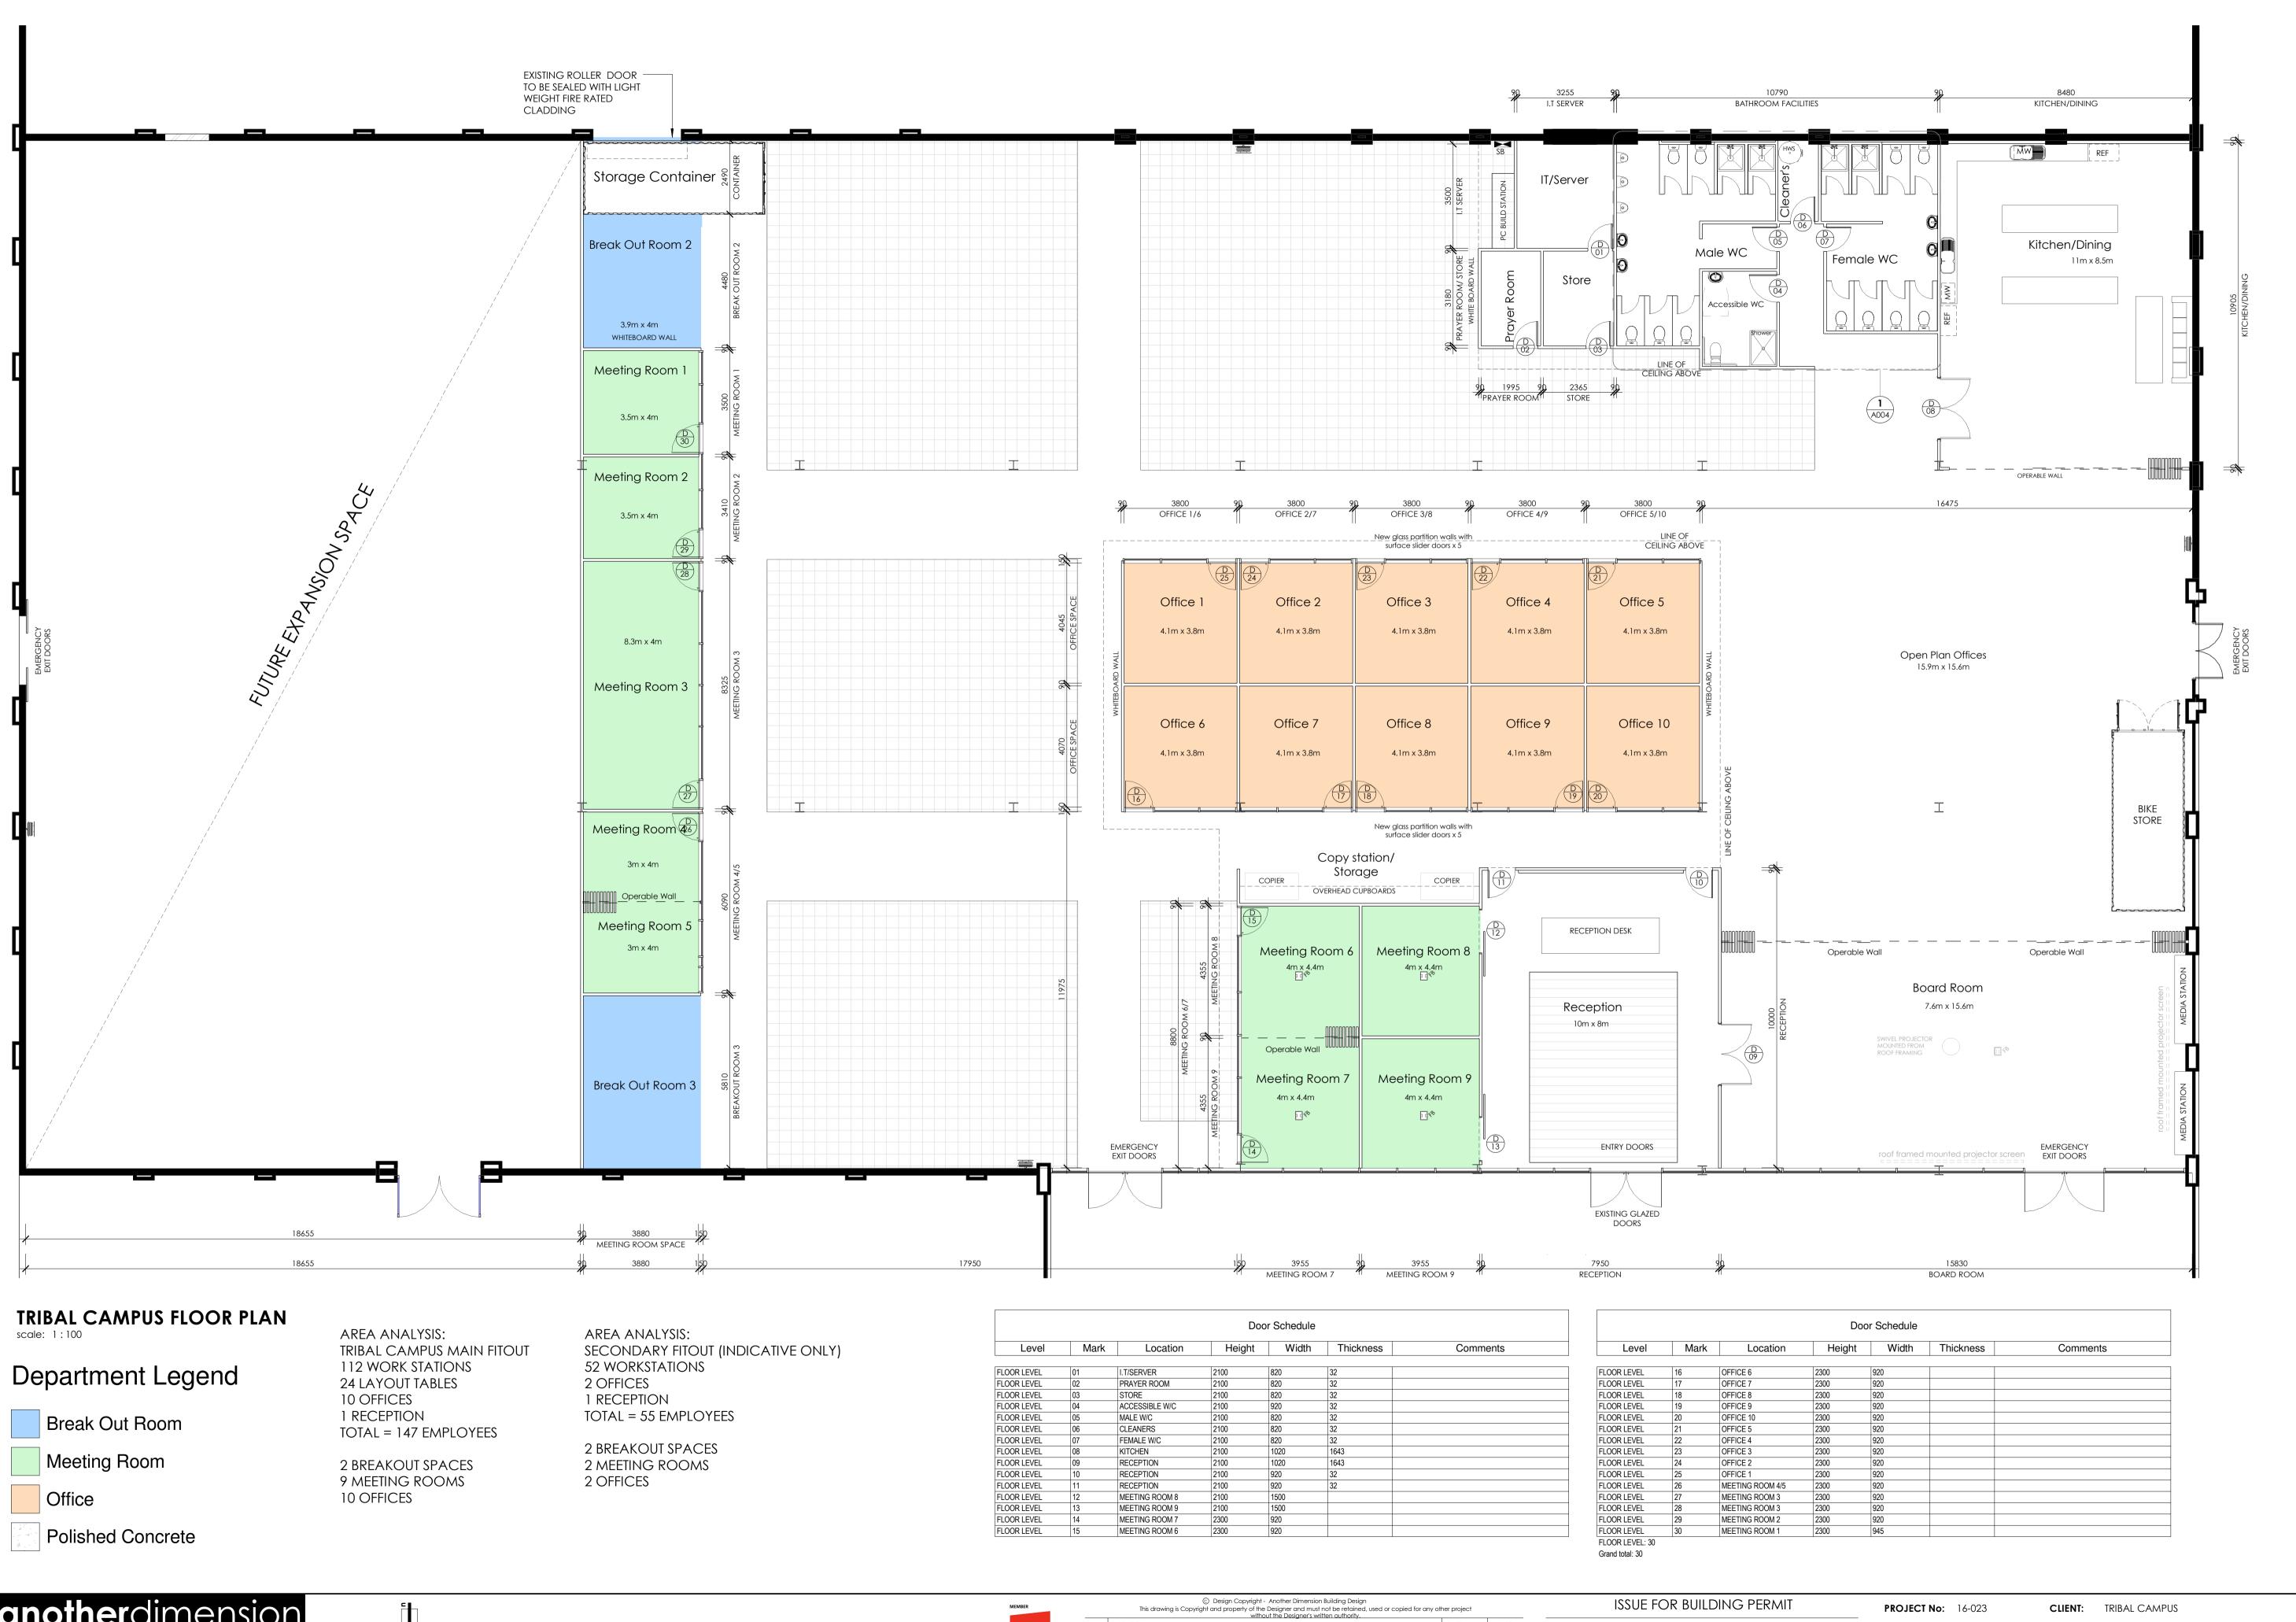



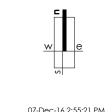



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PROJECT No: 16-023 CLIENT: IRIBAL CAMPUS

DATE: DECEMBER 2016 PROJECT: TRIBAL CAMPUS FITOUT

SCALE: 1:100 @A1 ADDRESS: 13-35 MACKEY ST, NORTH GEELONG. VIC

DRAWING No: A002 DWG TITLE: PROPOSED FLOOR PLAN



# Department Legend

Break Out Room

Meeting Room

Office

Polished Concrete

AREA ANALYSIS: TRIBAL CAMPUS MAIN FITOUT 112 WORK STATIONS 24 LAYOUT TABLES 10 OFFICES 1 RECEPTION TOTAL = 147 EMPLOYEES

2 BREAKOUT SPACES 9 MEETING ROOMS 10 OFFICES


AREA ANALYSIS: SECONDARY FITOUT (INDICATIVE ONLY) 52 WORKSTATIONS

2 OFFICES 1 RECEPTION TOTAL = 55 EMPLOYEES

2 BREAKOUT SPACES 2 MEETING ROOMS 2 OFFICES

# TRIBAL CAMPUS FLOOR PLAN - LAYOUT



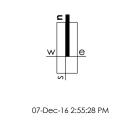




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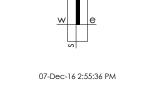
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**PROJECT No:** 16-023 **CLIENT:** TRIBAL CAMPUS DECEMBER 2016 PROJECT: TRIBAL CAMPUS FITOUT

@A1 ADDRESS: 13-35 MACKEY ST, NORTH GEELONG. VIC **DRAWING No:** A003 **DWG TITLE: FURNITURE LAYOUT PLAN** 



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**DRAWING No:** A004 **DWG TITLE: AMENITY DETAILS** 

REV: A

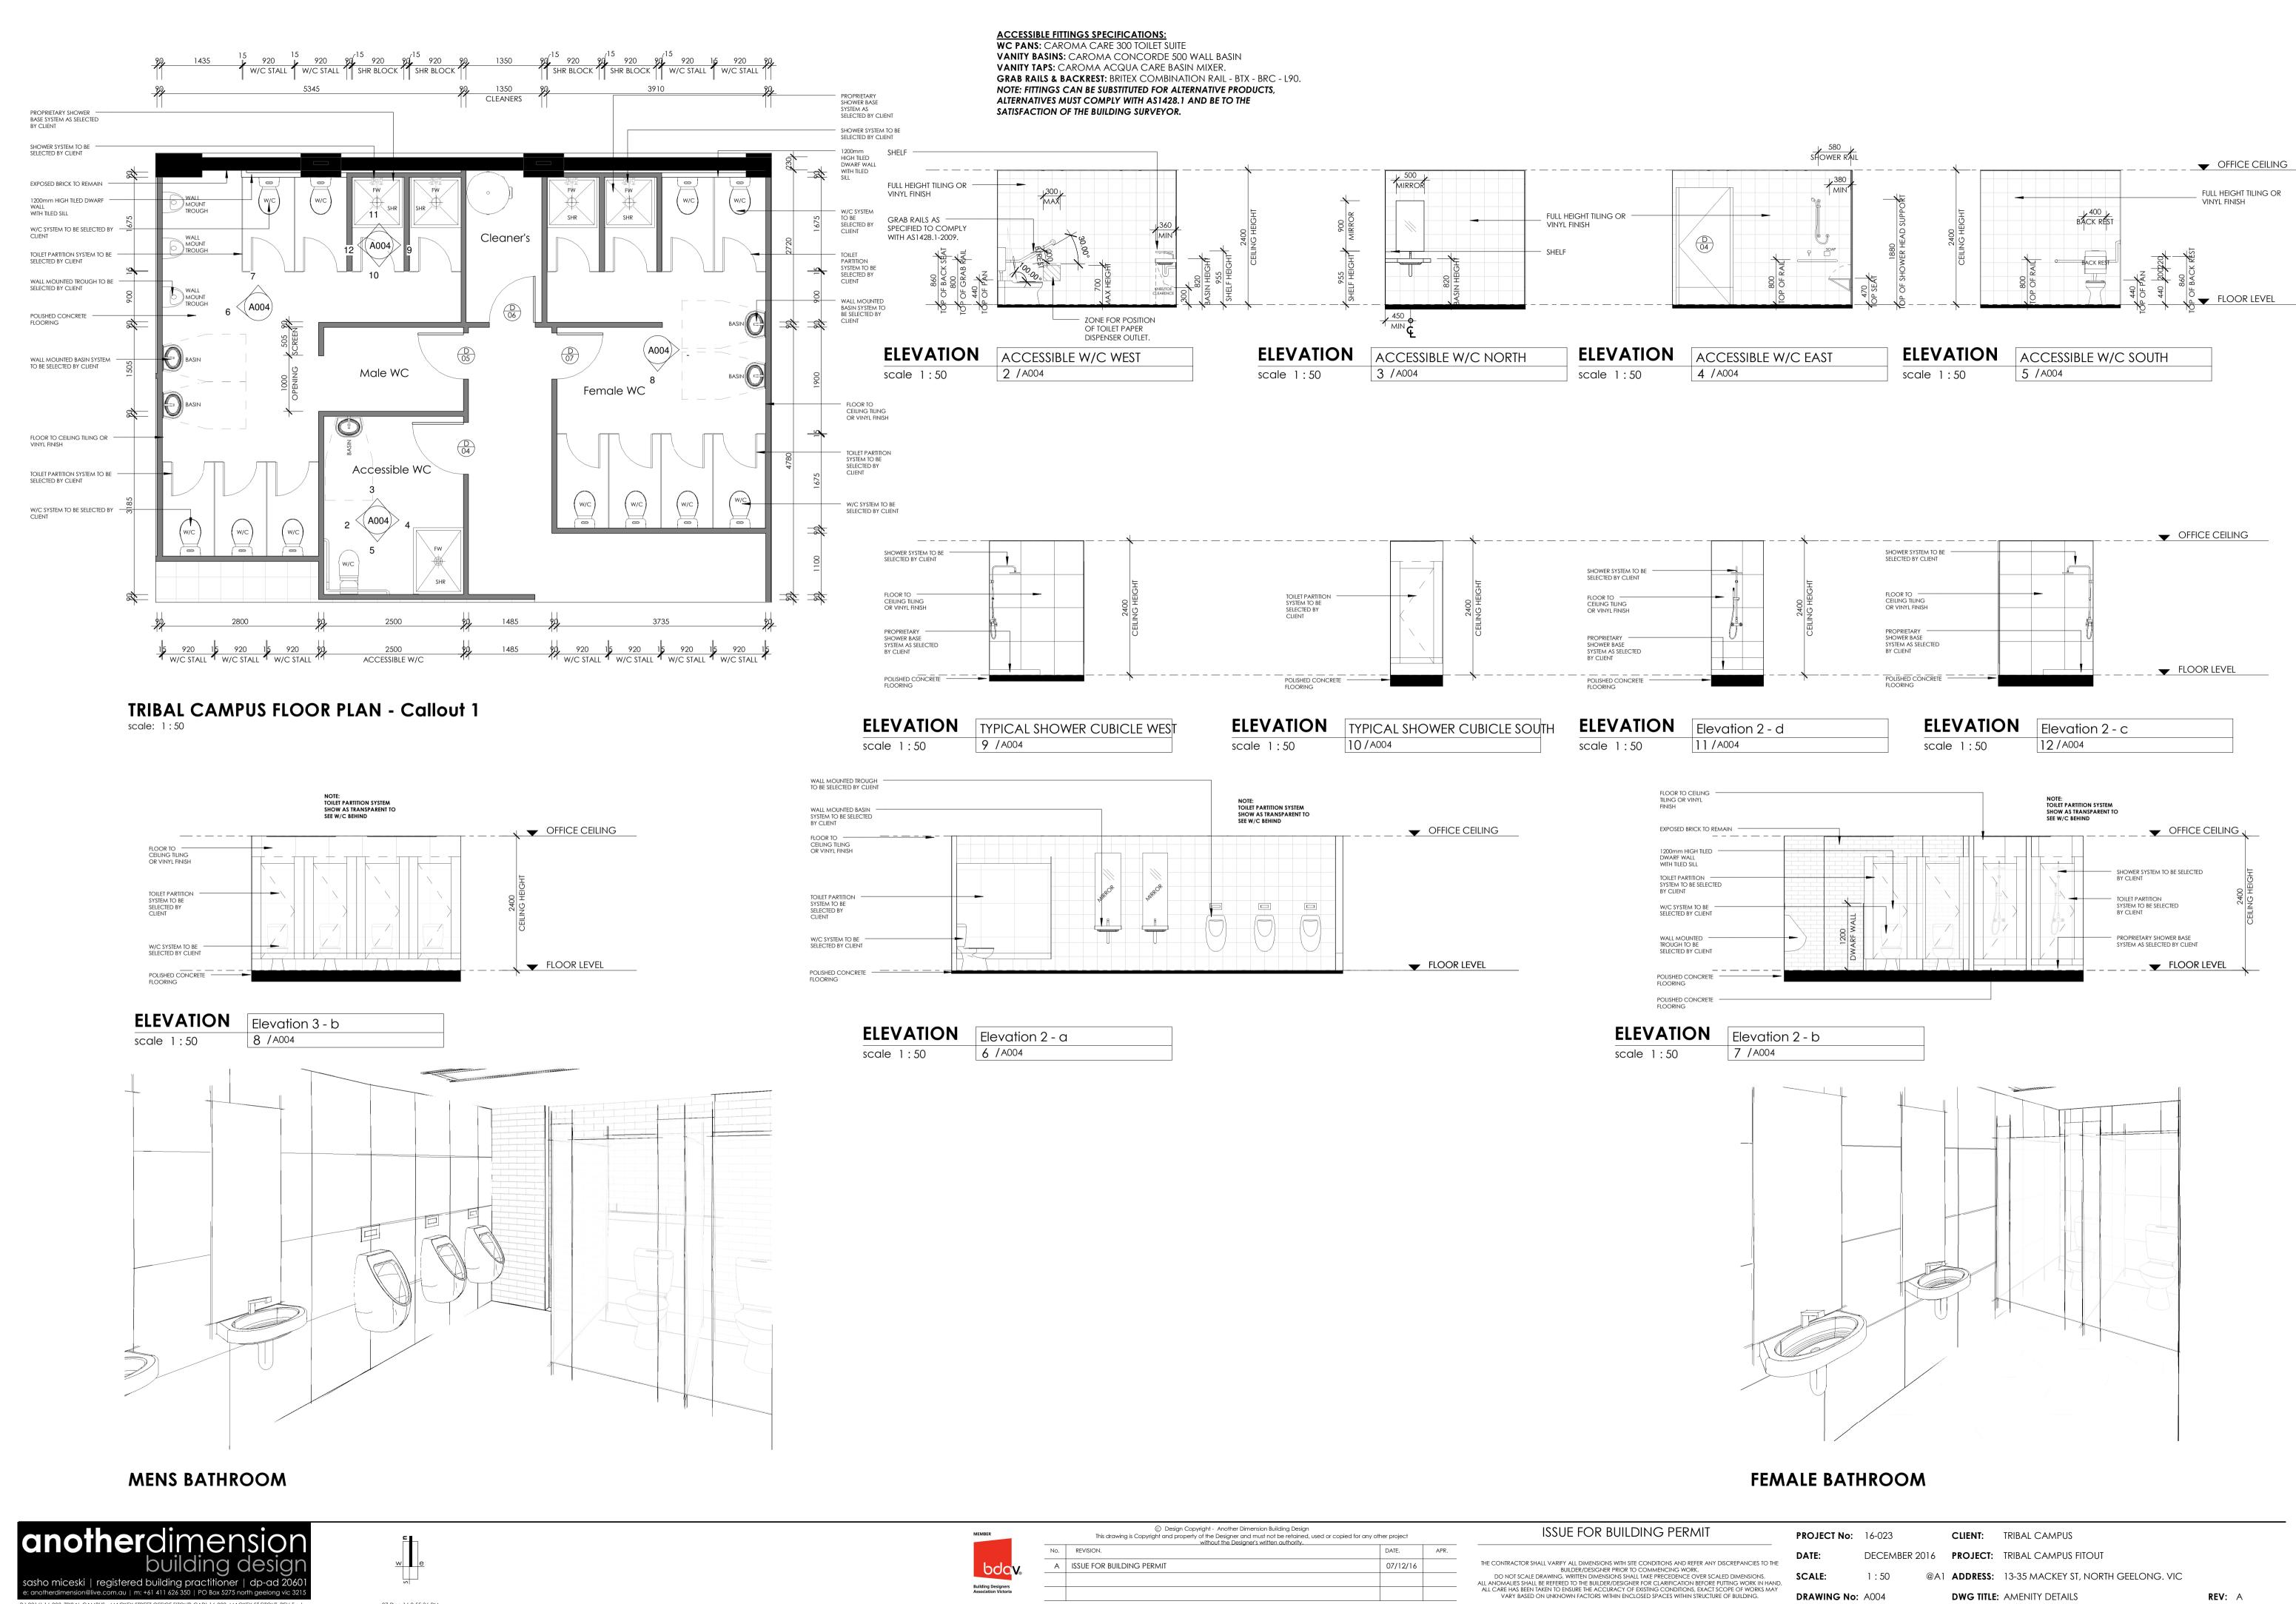

## **ELECTRICAL NOTES:**

HEIGHTS OF GPO'S AS FOLLOWS: GENERALLY - 1000mm ABOVE FLOOR ABOVE BENCH - 200mm ABOVE TOP OF BENCH LEVEL EXTERNAL - 600mm ABOVE GROUND/FLOOR LEVEL

GPOS & SWITCHES TO BE HPM STANDARD PLATES, MOUNTED ON HPM MOUNTING BLOCKS IN WAREHOUSE AREA AND WALL MOUNTED IN KITCHEN AREAS, ALTERNATIVE TYPES MAY BE USED WITH APPROVAL BY

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HEIGHTS OF ALL LIGHT SWITCHES TO BE 1100mm ABOVE FLOOR LEVEL.

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BUILDING SURVEYOR.

## **ELECTRICAL & LIGHTING LEGEND:**

- SB SWITCHBOARD EXISTING
- HB LED HIGHBAY LIGHT FITTING, SUNNY LIGHTING PRODUCT CODE: SHB130W/AR WW
- SMOKE DETECTORS HARD WIRED TO SWITCHBOARD WITH DEDICATED CIRCUIT & 9V BATTERY BACKUP.
- EXHAUST FAN BUILDER SELECTED. DUCTED TO EXHAUST FAIN - DUILDER SELECTED, DOMOBER SEXTERIOR, TO HAVE SELF CLOSING DAMPER. TO BE WIRED TO LIGHT SWITCH IN POWDER
- ROOMS & ENSUITES WITH NO WINDOWS. O BATTEN HOLDER OR RECESSED LED LIGHT
- FITTING TYPICAL 15W
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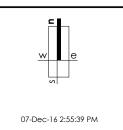
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- 从 GPO DOUBLE
- EMERGENCY EXIT SIGNAGE TO BE "CLEVERTRONICS CLEVERFIT" EXIT SIGNS FIXED ABOVE EXIT DOORWAYS IN ACCORDANCE WITH AS-2293.
  SUBSTITUTE FITTINGS MAY BE USED AT THE DISCRETION OF THE BUILDING SURVEYOR.

LED TROFFER FLUSH MOUNT LIGHTS

### <u>LIGHTING LOAD CALCULATIONS - SPECIFICATION</u> NCC 2015 Volume 1, Part J6 Artificial Lighting & Power INTERNAL LIGHTING - WEST 7 PROPOSED NEW FLOOR AREA $= 784m^{2}$ LIGHTING LOAD ALLOWANCE TOTAL LIGHTING LOADING ALLOWED = 17248W SUNNY LIGHTING SHB130W/AR WW 130W Supended LEB High Boy Light High efficiency COB LED Chip Aluminium head sink Aluminium or Polycarbonate reflector Remote constant current LED driver included Legal Suitable for Indoor use only Available fifting colour. Anodized Silver Colour Temp. 3000K (OR SIMILAR APPROVED) PROPOSED LIGHTING: LED RECESSED & LED HIGHBAY LIGHT FITTINGS LED RECESSED LIGHT FITTINGS X 49 @ 30W = 1470W LED HIGH BAY FITTINGS X 15 @ 130W = 1950W TOTAL LIGHTING PROPOSED = 3420W $= 4.36W/m^2$ LIGHTING LOAD W/pm<sup>2</sup> **EXTERNAL LIGHTING** NOTE: ALL ARTIFICIAL LIGHTING (IF INSTALLED) AROUND THE PERIMETER OF THE BUILDING MUST BE CONTROLLED BY A DAYLIGHT SENSOR & A MOTION DETECTOR IN ACCORDANCE WITH SPECIFICATION J6.

## REFLECTED CEILING PLAN scale: 1:100







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Building Designers Association Victoria				

ISSUE FOR BUILDING PERMIT

**PROJECT No:** 16-023 CLIENT: TRIBAL CAMPUS DECEMBER 2016 **PROJECT:** TRIBAL CAMPUS FITOUT THE CONTRACTOR SHALL VARIFY ALL DIMENSIONS WITH SITE CONDITIONS AND REFER ANY DISCREPANCIES TO THE BUILDER/DESIGNER PRIOR TO COMMENCING WORK.

DO NOT SCALE DRAWING. WRITTEN DIMENSIONS SHALL TAKE PRECEDENCE OVER SCALED DIMENSIONS, ALL ANOMALIES SHALL BE REFERED TO THE BUILDER/DESIGNER FOR CLARIFICATION BEFORE PUTTING WORK IN HAND, ALL CARE HAS BEEN TAKEN TO ENSURE THE ACCURACY OF EXISTING CONDITIONS, EXACT SCOPE OF WORKS MAY VARY BASED ON UNKNOWN FACTORS WITHIN ENCLOSED SPACES WITHIN STRUCTURE OF BUILDING.

@A1 ADDRESS: 13-35 MACKEY ST, NORTH GEELONG. VIC 1:100 **DRAWING No:** A005 **DWG TITLE:** REFLECTED CEILING PLAN