

LOT 3 DONINGTON DRIVE, MAUDSLAND QLD 4210

INFORMATION MEMORANDUM

PREPARED BY RAY WHITE SPECIAL PROJECTS QLD NOVEMBER 2019



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THE OPPORTUNITY

Ray White Special Projects (Queensland) are pleased to exclusively offer to the market the approved and 'shovel ready' residential development site located at Lot 3 Donington Drive, Maudsland Qld 4210.

Highlights include:

- Development Approval and OPW Approvals for 7 community title dwellings
- Land area: 2,572m^{2*}
- Located in the northern Gold Coast growth corridor directly opposite the Huntington Rise Estate
- Existing approval allows for attached and detached dwellings with generous open space areas and elevated views
- 5km* to the Westfield Helensvale Town Centre
- Well located to the M1 Pacific Motorway, local retail facilities, theme parks and to a range of primary and secondary schools

As the exclusive marketing agents we encourage your strong consideration of this outstanding asset and look forward to assisting you with your enquiries.



Dax Roep
Ray White Special Projects (QLD)

M 0421 230 354 E dax.roep@raywhite.com



Matthew Fritzsche Ray White Special Projects (QLD)

M 0410 435 891

E matthew.f@raywhite.com

^{*}Approximately

[^] Important: Prospective purchasers conduct due diligence investigations of the property strictly at their own expense and risk, and the vendor will have no liability in relation to such expenses. Consent by the vendor to the conduct by any potential purchaser of due diligence activities or investigation will not in any circumstance be construed as a representation that the vendor will be exercising, or refraining from exercising its rights to deal with the property, or any representation that the vendor intends to contract with that potential buyer, or at all.

PROPERTY HIGHLIGHTS



DEVELOPMENT APPROVAL

The site has Development Approval and OPW Approvals for 7 dwellings. There are very few opportunities in this market to purchase an approved development site, offering certainty and speed to market.



LOCATION

The site is strategically located at Maudsland, situated in the rapidly expanding Gold Coast to Brisbane growth corridor, comprising a range of primary and secondary schools, retail facilities and transport. The area is well known from the development of major residential estates including Stockland's Riverstone Crossing and Huntington Downs.



SERVICES

The site provides direct connectivity to essential services including power, water, telephone and sewer.



CONNECTIVITY

The site is within close proximity to transport nodes including, local bus, rail and major road infrastructure. The M1 Pacific Highway is easily accessable via a major interchange within 4km* which provides connectivity to major nearby localities including the Brisbane CBD, Logan and central Gold Coast. The G-Link light rail and heavy rail is also within 5km* adjoining Westfield Helensvale.

SALES SUMMARY

Address	Idress Lot 3 Donington Drive, Maudsland QLD 4210							
	The property is being offered for sale a	sking \$550,000 (inclusive of GST).						
	The seller retains the right (in their absolute discretion) to:							
	• Decline to consider and/or accept any offers lodged in response to this invitation;							
	 Negotiate directly with any party who has lodged an offer at any stage; 							
	 Accept or decline a non-conforming 	• Accept or decline a non-conforming offer at any stage of the sale process;						
	 Enter into any agreement for sale of the property on such terms as are acceptable to the sellers discretion; 							
	 Change this invitation; 	Change this invitation;						
	 Require additional information from a party who has lodged an offer; 							
	 Reject all or any offers at any time f 	or any reason; and						
	Withdraw the property from sale.							
Method of Sale	If an offer is to be submitted by hard copy it is to be enclosed within a sealed envelope marked clearly with:							
	Offer for Lot 3 Donington Drive, Maudsland							
	c/- Dax Roep Ray White Special Projects (QLD) Level 26, One One One Eagle Street 111 Eagle Street, Brisbane Qld 4000							
	If the offer is to be submitted electronically, details are as follows:							
	c/- Ray White Special Projects (QLD) Facsimile: (07) 3832 4777 E-mail: matthew.f@raywhite.com or dax.roep@raywhite.com							
	Sale Documents are available from the marketing agents upon request.							
Marketing Agents	Matthew Fritzsche Ray White Special Projects (Qld) M: 0410 435 891	Dax Roep Ray White Special Projects (Qld) M: 0421 230 354						
	E: matthew.f@raywhite.com	E: dax.roep@raywhite.com						

PROPERTY OVERVIEW

Address	Lot 3 Donington Drive, Maudsland QLD 4210
Real Property Details	Lot 3 on SP275769
Land Area	2,572m²
Local Authority	City of Gold Coast
Zoning	Emerging Community
Site Description	The site comprises an irregular shaped development parcel, located to the southern side of Donington Drive with additional frontages to Yallaroi Road and Gaven Arterial Road. The site is currently unimproved and rises up gradually from the southern to northern boundary. Elevated views are available.
Services and Amenities	All normal utilities including electricity, telephone, reticulated town water, stormwater drainage and sewerage services are available.
Roads and Access	The property currently features 3 street frontages however under the approval, access will be via Donington Drive to the north.
	The site received a Combined Development Approval on the 1 May 2018 under Application No. MCU201701129 for a Development Permit for a Material Change of Use (Impact Assessment) for Multiple dwellings (7 dwellings) and Reconfiguring a lot for Community Title Subdivision (1 into 4 lots).
Development Approval	The proposal comprises a 7 dwelling community title complex with access directly from Donington Drive to the north. Under the proposal, all of the dwellings will incorporate three bedrooms and two bathrooms, with either single or double garages.
	In addition, an Operational Works Approval for Earthworks and Retaining Walls, Vegetation Clearing and Infrastructure (Roadworks, Stormwater Drainage and Sewerage Reticulation) was received on 29 October 2019.
	Applications for Landscaping and Electrical OPWs have been submitted with Council and pending.

^{*}Approximately

TOWN PLANNING OVERVIEW

EMERGING COMMUNITY

The purpose of the Emerging Community zone code is to:

- 1. identify land that is suitable for urban purposes and protect land that may be suitable for urban development in the future.
- 2. manage the timely conversion of non-urban land to urban purposes.
- 3. prevent or discourage development that is likely to compromise appropriate longer term land use.



DEVELOPMENT OVERVIEW

APPROVED PLAN OF DEVELOPMENT

(SOURCE: DRYHURST STUART ARCHITECTS)



NOTE: this layout is for illustrative purposes only and is subject to detailed design, the normal planning and local authority building approvals and does not infer that such approval would be



DONINGTON DRIVE Site Plan



Date Scale The ownership of this drawing remains with DSa and may not be use, copied or 1:750@A3 JUL-2017 amended without the written permission of DSa.

HATIA PROPERTY CORPORATION Mortons Urban Solutions

PROPOSED RESIDENTIAL DEVELOPMENT - LOT 3 on SP275769 - DONINGTON DRIVE, MAUDSLAND

206.2 DA-1-10

LOCATION OVERVIEW

MAUDSLAND PROFILE

Maudsland is centrally located 40 minutes from the Brisbane CBD and 30 minutes to the Gold Coast beaches. Maudsland is tucked away at the foot of the Gold Coast hinterland and is in close proximity to forests and national parks. The locality is a rapidly developing residential area which has seen a significant population increase over the past ten years with the development of a number of large scale residential estates including Riverstone Crossing, Highland Reserve, Tuxedo Junction and Huntington Rise (directly opposite).

The central location allows residents to be close to a number of shopping centres, schools, bus transport and leisure amenities, as well as close proximity to the Pacific Motorway enabling easy access to both Brisbane and the Gold Coast. Additionally, the Helensvale railway station and G-Link light rail are within 5 kilometres.

Other notable features within a five kilometre radius include the Movie World and Wet n Wild theme parks, Paradise Country, Gold Coast Wake park, Westfield Helensvale and Helensvale Golf Club.



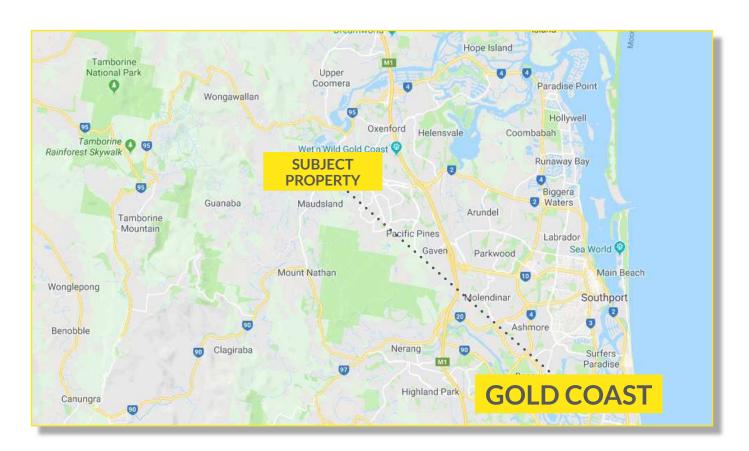


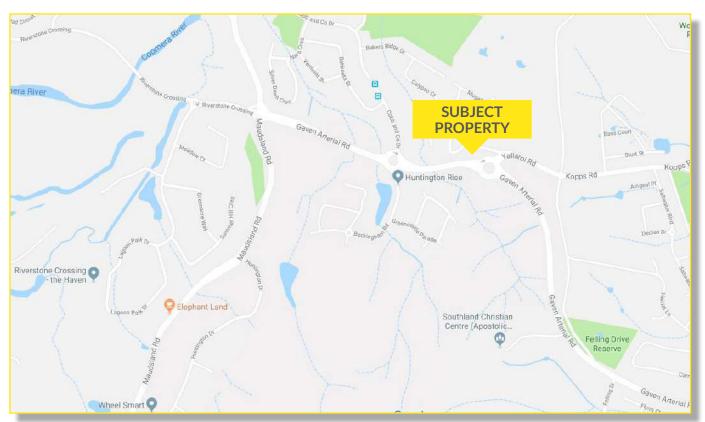







LOCATION MAP





*Outline and Locations indicative only

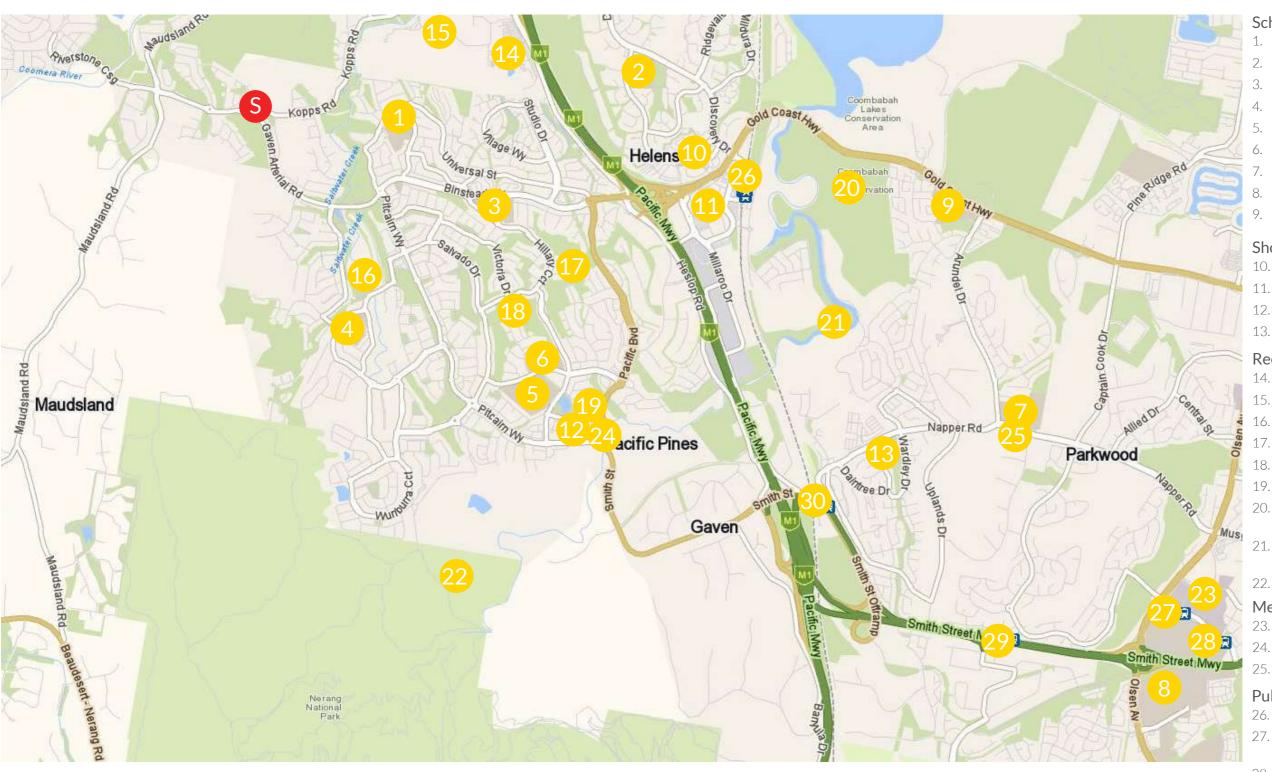AMENITIES MAP



Schools

- Gaven State School
- Helensvale State School
- . Jubilee State School
- 4. Park Lake State School
- 5. Pacific Pines State High School
- . Pacific Pines State School
- 7. Arundel State School
- 8. Griffith University Gold Coast
- 9. A.B. Paterson College

Shopping

- 10. Helensvale Plaza
- L1. Westfield Helensvale
- 12. Pacific Pines Town Centre
- 13. Arundel Plaza

Recreation and Parks

- 14. Wet n Wild Theme Park
- 15. Movie World Theme Park
- 16. Flooded Gum Park
- 17. Pacific Pines Parklands
- 18. Moorea Court Reserve
- 9. Central Park
- 20. Coombabah Lake Conservation Park
- Coombabah Lakelands Conservation Area
- 22. Nerang National Park

Medical

- B. Gold Coast University Hospital
- 24. Pacific Pines Medical Centre
- 25. Parkwood Medical Centre

Public Transport

- 26. Helensvale Railway Station
- 27. Gold Coast University Hospital Tram Station
- 28. Gold Coast University Hospital Tram Station (South)
- 29. Parkwood East Tram Station
- 30. Parkwood Tram Station



Subject Property

DISCLAIMER

The information contained in this Information Memorandum and any other verbal or written information given in respect of the property ("Information") is provided to the recipient ("you") on the following conditions:

- 1. Eagle Street (Brisbane) Pty Ltd ABN 68 164 201 629 trading as Ray White Commercial (Queensland) and or any of its officers, employees or consultants ("we, us") make no representation, warranty or guarantee, that the Information, whether or not in writing, is complete, accurate or balanced. Some information has been obtained from third parties and has not been independently verified. Accordingly, no warranty, representation or undertaking, whether express or implied, is made and no responsibility is accepted by us as to the accuracy of any part of this, or any further information supplied by or on our behalf, whether orally or in writing.
- 2. All visual images (including but not limited to plans, photographs, specifications, artist impressions) are indicative only and are subject to change. Any measurement noted is indicative and not to scale. All outlines on photographs are indicative only.
- 3. The Information does not constitute, and should not be considered as, a recommendation in relation to the purchase of the property or a solicitation or offer to sell the property or a contract of sale for the property.
- 4. You should satisfy yourself as to the accuracy and completeness of the Information through your own inspections, surveys, enquiries, and searches by your own independent consultants, and we recommend that you obtain independent legal, financial and taxation advice. This includes as to whether any listing price is inclusive or exclusive of GST.
- 5. We are not valuers and make no comment as to value. "Sold/leased" designations show only that stock is "currently not available" not that the property is contracted/settled. If you require a valuation we recommend that you obtain advice from a registered valuer.
- 6. The Information does not and will not form part of any contract of sale for the property. If an interested party makes an offer or signs a contract for the property, the only information, representations and warranties upon which you will be entitled to rely will be as expressly set out in such a contract.

- 7. Interested parties will be responsible for meeting their own costs of participating in the sale process for the property. We will not be liable to compensate any intending purchasers for any costs or expenses incurred in reviewing, investigating or analysing any Information.
- 8. We will not be liable to you (to the full extent permitted by law) for any liabilities, costs or expenses incurred in connection with the Information or subsequent sale of the property whatsoever, whether the loss or damage arises in connection with any negligence, default or lack of care on our part.
- 9. No person is authorised to give information other than the Information in this Information Memorandum or in another brochure or document authorised by us. Any statement or representation by an officer, agent, supplier, customer, relative or employee of the vendor will not be binding on the vendor or us.
- 10. To the extent that any of the above paragraphs may be construed as being a contravention of any law of the State or the Commonwealth, such paragraphs should be read down, severed or both as the case may require and the remaining paragraphs shall continue to have full force and effect.
- 11. You may not discuss the Information or the proposed sale of the property with the vendors or with any agent, friend, associate or relative of the vendor or any other person connected with the vendor without our prior written consent. We accept no responsibility or liability to any other party who might use or rely upon this report in whole or part of its contents.
- 12. The Information must not be reproduced, transmitted or otherwise made available to any other person without our prior written consent.

SOURCES OF INFORMATION

PAGE	CONTENT	SOURCE				
Page 04	Property Overview	RP Data				
Page 05	Town Planning Overview	Gold Coast City Council				
Page 06	Approved Plan of Development	Dryhurst Stuart Architects				
Page 08 Location Overview Wikipedia, Google Maps, & Gold Coast Cit		Wikipedia, Google Maps, & Gold Coast City Council				
Page 09	Location Map	Google				
Page 10	Amenities Map	Google				
Annexure A	Aerial Photography	Skyepics				
Annexure B Offers to Purchase Form		Ray White				
Annexure C	Title Search	Department of Natural Resources and Mines				
Annexure D	Survey Plan	Department of Natural Resources and Mines				
Annexure E	Smart Map	Department of Natural Resources and Mines				
Annexure F	Decision Notice	Gold Coast City Council				
Annexure G	Infrastructure Charges Notice	Gold Coast City Council				
Annexure H	Plans and Drawings	Dryhurst Stuart Architects				
Annexure I	Operational Works Approvals	Gold Coast City Council				

ANNEXURE A AERIAL PHOTOGRAPHY

SOURCE: SKYEPICS









ANNEXURE B OFFERS TO PURCHASE FORM

SOURCE: RAY WHITE

OFFERS TO PURCHASE FORM

Offers to Purchase (OTP) Form / Particulars

I / We register our Offer to Purchase to enter into negotiations to purchase the property located at Lot 3 Donington Drive, Maudsland Qld 4210. ("the Property").

Property Details					
Address	Lot 3 Doningto	on Drive,	Mauds	land Qld	14210
Real Property Description	Lot 3 on SP275	5769			
Local Authority	Gold Coast Cit	y Counci			
Land Area	2,572m ^{2*}				
Offer to Purchase					
Proposed Price:	\$		exclu	ding GS	Г
Proposed Deposit:	10% of the Purchase Pr	rice			
Proposed Settlement Date:					
Further Details / Information: (Finance, Conditions etc.)					
Details of Proposed Buyer					
Full Name(s):					
If Company	Name: ABN: Registered for GST:	Yes	or	No	(please circle one)
Contact Details	Address: Mobile: Email:				
FIRB approval require to purchase the Property:	Registered for GST: Buyers should consult	Yes their leg	or gal advi	No sers if ir	(please circle one) n doubt
Proposed Guarantors* (please complete if the proposed Buyer is a company or trustee of a trust):	Name: Address: Telephone: Email:				

^{*}Guarantors should be directors of a company Buyer or principal beneficiaries if trustee Buyer

RayWhi

Details of Proposed Buyer's Solicitor (if known)						
Fir	Firm: Name / Contact: Address:					
Na						
Ad						
Со	ontacts: Telephone:					
_	Email:					
Pro	oposed Buyer Acknowledgment					
	submitting an Offer to Purchase to buy the subject property ("OTP"), the Proposed Buyer agrees to the following nditions:					
1.	L. The Proposed Buyer agrees to and accepts all disclaimers, limitations and qualifications in any written or verbal brochure, advertisement, representation, search, advice or information issued by the Vendors or Ray White or anyone on behalf of either of them ("Marketing Material").					
2.	The Proposed Buyer acknowledges that the Proposed Buyer has to satisfy itself about the characteristics, value, potential and features of the subject property by relying only on the Buyer's own enquiries and investigations and not on any Marketing Material. Therefore, neither the Vendors nor Ray White (or their respective employees and agents) will be liable if any Marketing Material is incorrect, incomplete or misleading.					
3.	The Proposed Buyer accepts and agrees to the terms of the Disclaimer in the Information Memorandum containing this OTP form.					
4.	The Proposed Buyer agrees that the Vendors will not be obliged to sell the subject property in response to this or any particular OTP.					
5.	The Vendors may sell the subject property to any person they choose, as a result of the OTP process or otherwise, or not at all. The Proposed Buyer cannot assume or expect that:					
	• the Vendors will negotiate, or not negotiate, with the Proposed Buyer or any other respondent;					
	the Vendors will accept the highest purchase price offered;					
	 the Vendors will consider any particular feature of an OTP or other proposal to buy the subject property as determinative; or 					
	• the submission of the Proposed Buyer's OTP will lead to any particular outcome.					
6.	No claim can be made against the Vendors or Ray White in relation to any costs or expenses incurred by a respondent in evaluating the subject property or submitting an OTP.					
7.	This OTP constitutes an Offer to Purchase by the Proposed Buyer to negotiate for the possible sale and purchase of the subject property.					
Exe	ecution					
Sig	gned by the Proposed Buyer:					
Sig	gnature					
Ful	II Name:					

ANNEXURE C TITLE SEARCH

SOURCE: DEPARTMENT OF NATURAL RESOURCES AND MINES

CURRENT TITLE SEARCH NATURAL RESOURCES, MINES AND ENERGY, QUEENSLAND

Request No: 32584635

Search Date: 13/11/2019 12:30 Title Reference: 51082796
Date Created: 01/03/2017

Previous Title: 51074386

REGISTERED OWNER

Dealing No: 719506122 10/07/2019

TELLURIUM GG PTY LTD A.C.N. 631 467 082 TRUSTEE

UNDER INSTRUMENT 719506122

ESTATE AND LAND

Estate in Fee Simple

LOT 3 SURVEY PLAN 275769
Local Government: GOLD COAST

EASEMENTS, ENCUMBRANCES AND INTERESTS

- Rights and interests reserved to the Crown by Deed of Grant No. 10435002 (POR 47)
- 2. EASEMENT IN GROSS No 717830285 09/02/2017 at 13:54
 burdening the land
 COUNCIL OF THE CITY OF GOLD COAST
 over
 EASEMENTS A AND B ON SP275769
- 3. MORTGAGE No 719506127 10/07/2019 at 12:51 G V EDWARDS PTY LTD A.C.N. 052 481 866 TENANT IN COMMON 1/2 GORDON JAMES APPLETON MERRILL LOUISE APPLETON JOINT TENANTS INTER SE 1/2

ADMINISTRATIVE ADVICES - NIL UNREGISTERED DEALINGS - NIL

Caution - Charges do not necessarily appear in order of priority

** End of Current Title Search **

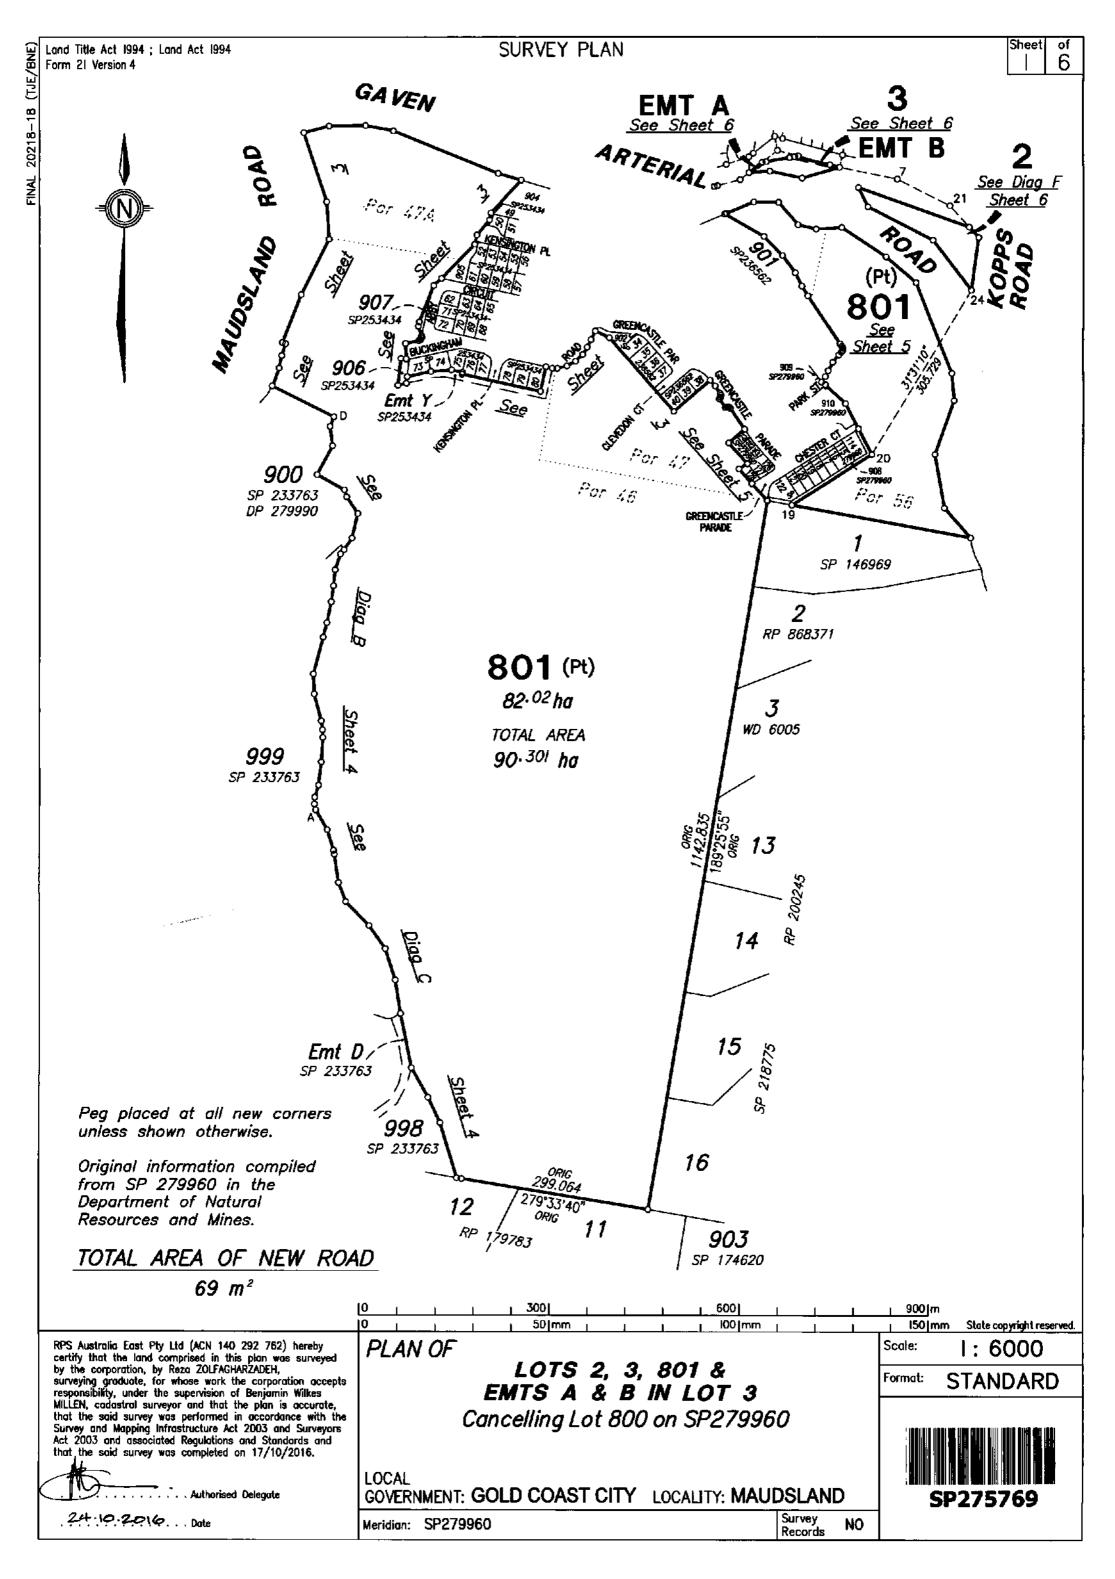
COPYRIGHT THE STATE OF QUEENSLAND (NATURAL RESOURCES, MINES AND ENERGY) [2019] Requested By: D-ENQ GLOBAL $\rm X$

Page 1/1

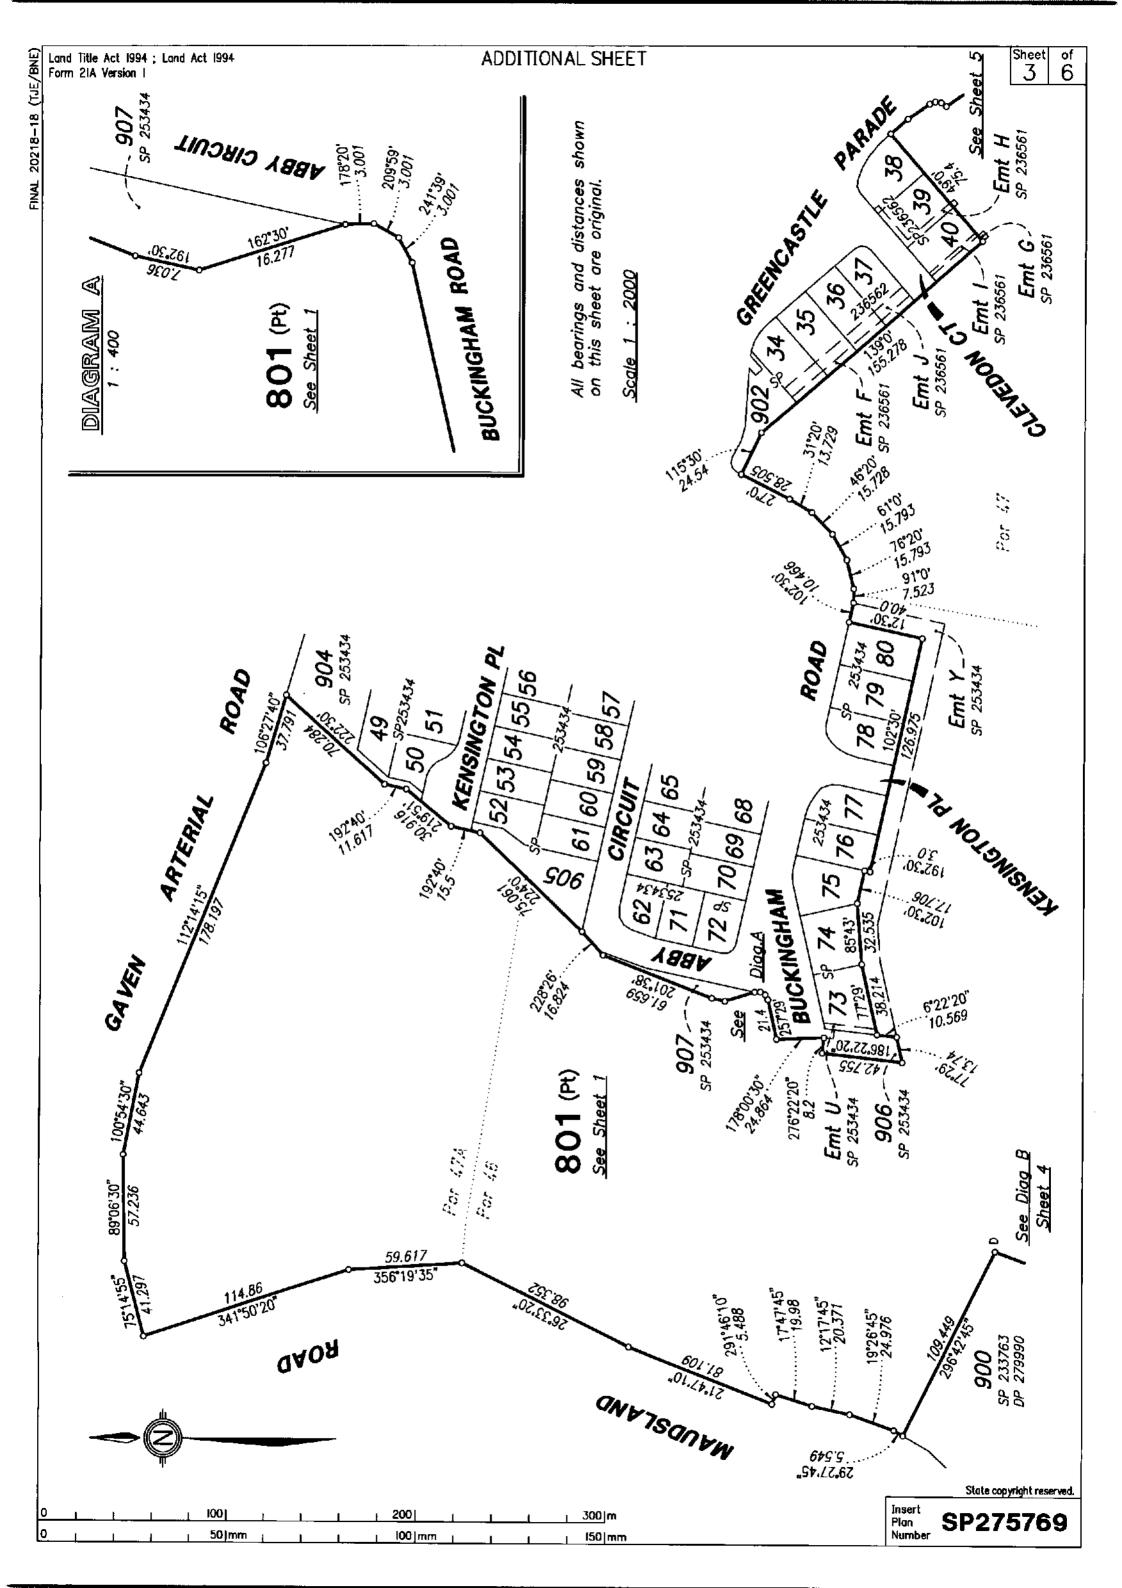
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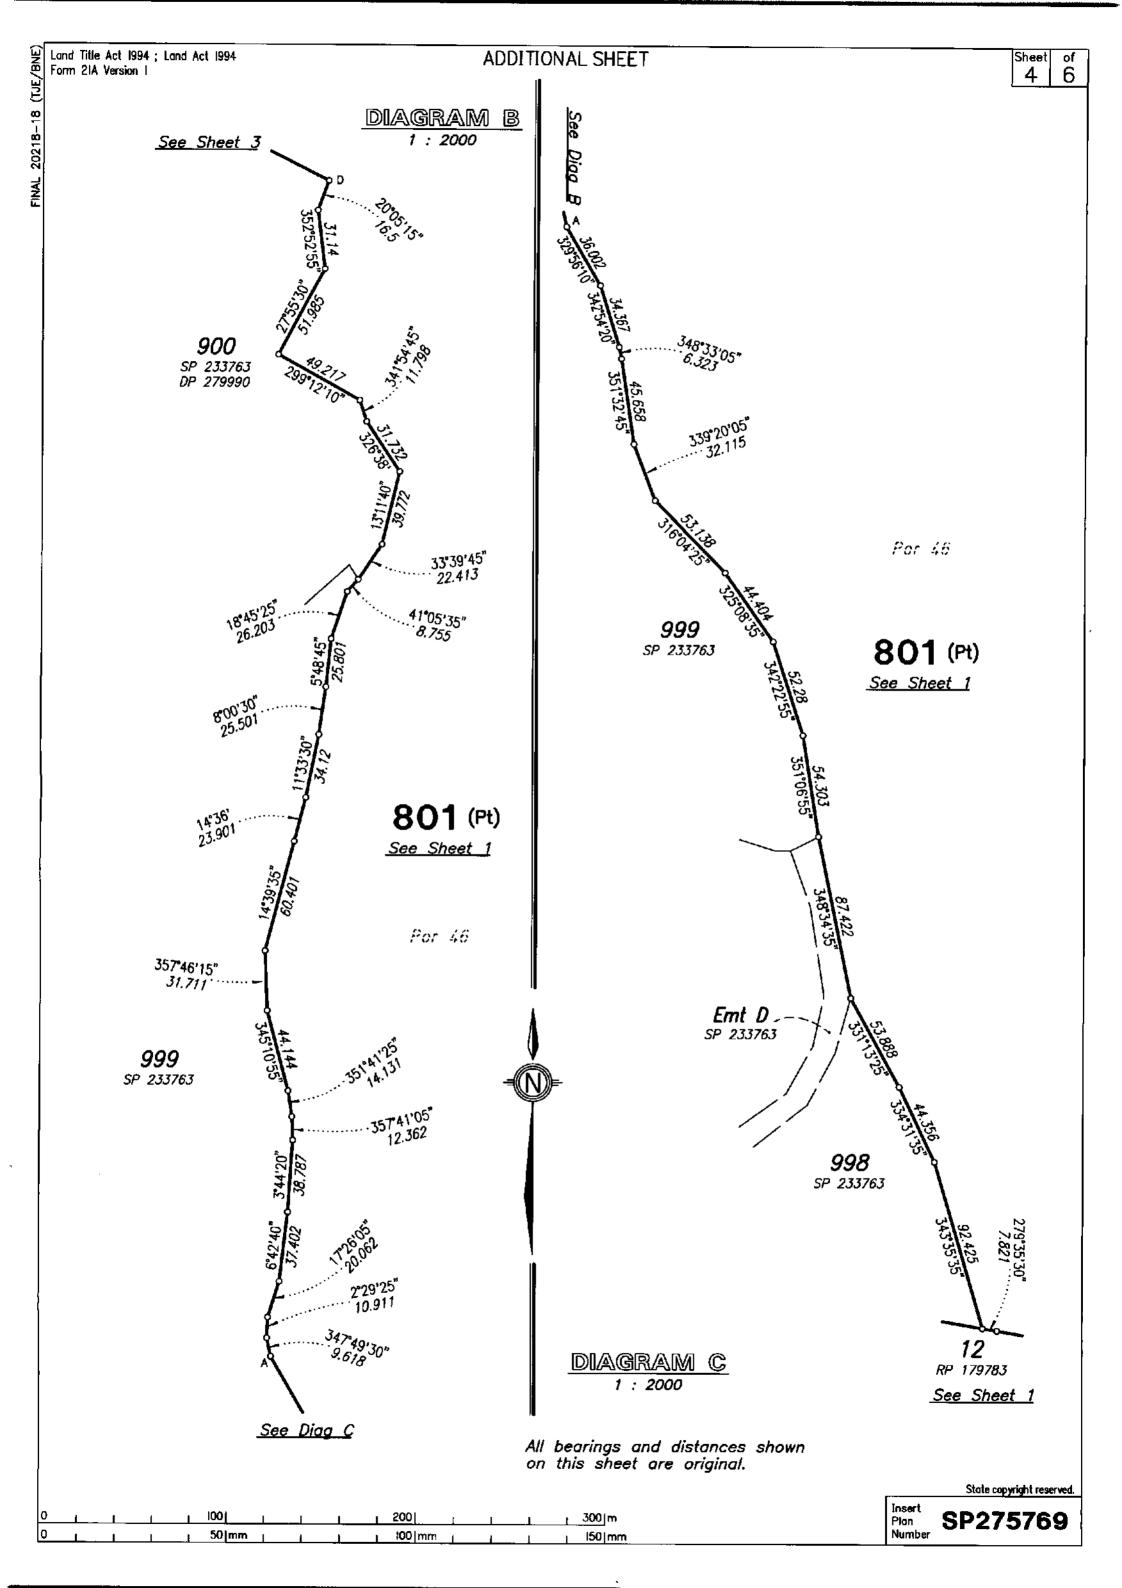
ANNEXURE D SURVEY PLAN

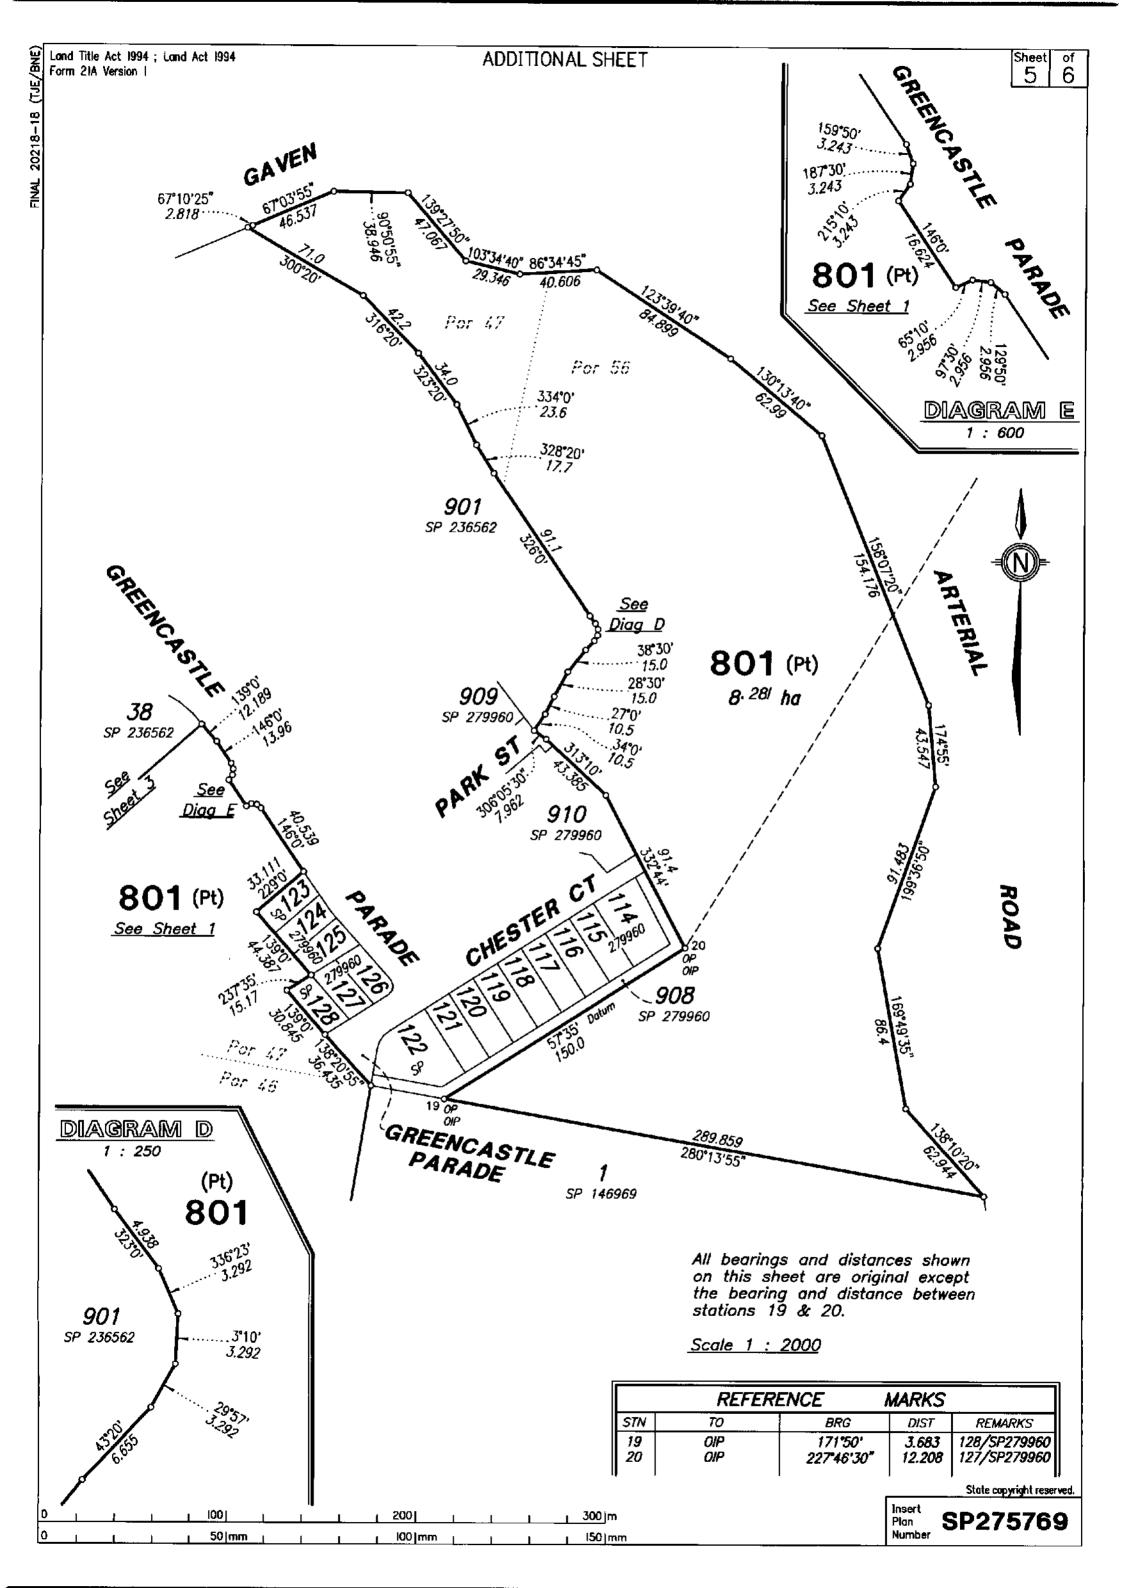
SOURCE: DEPARTMENT OF NATURAL RESOURCES AND MINES

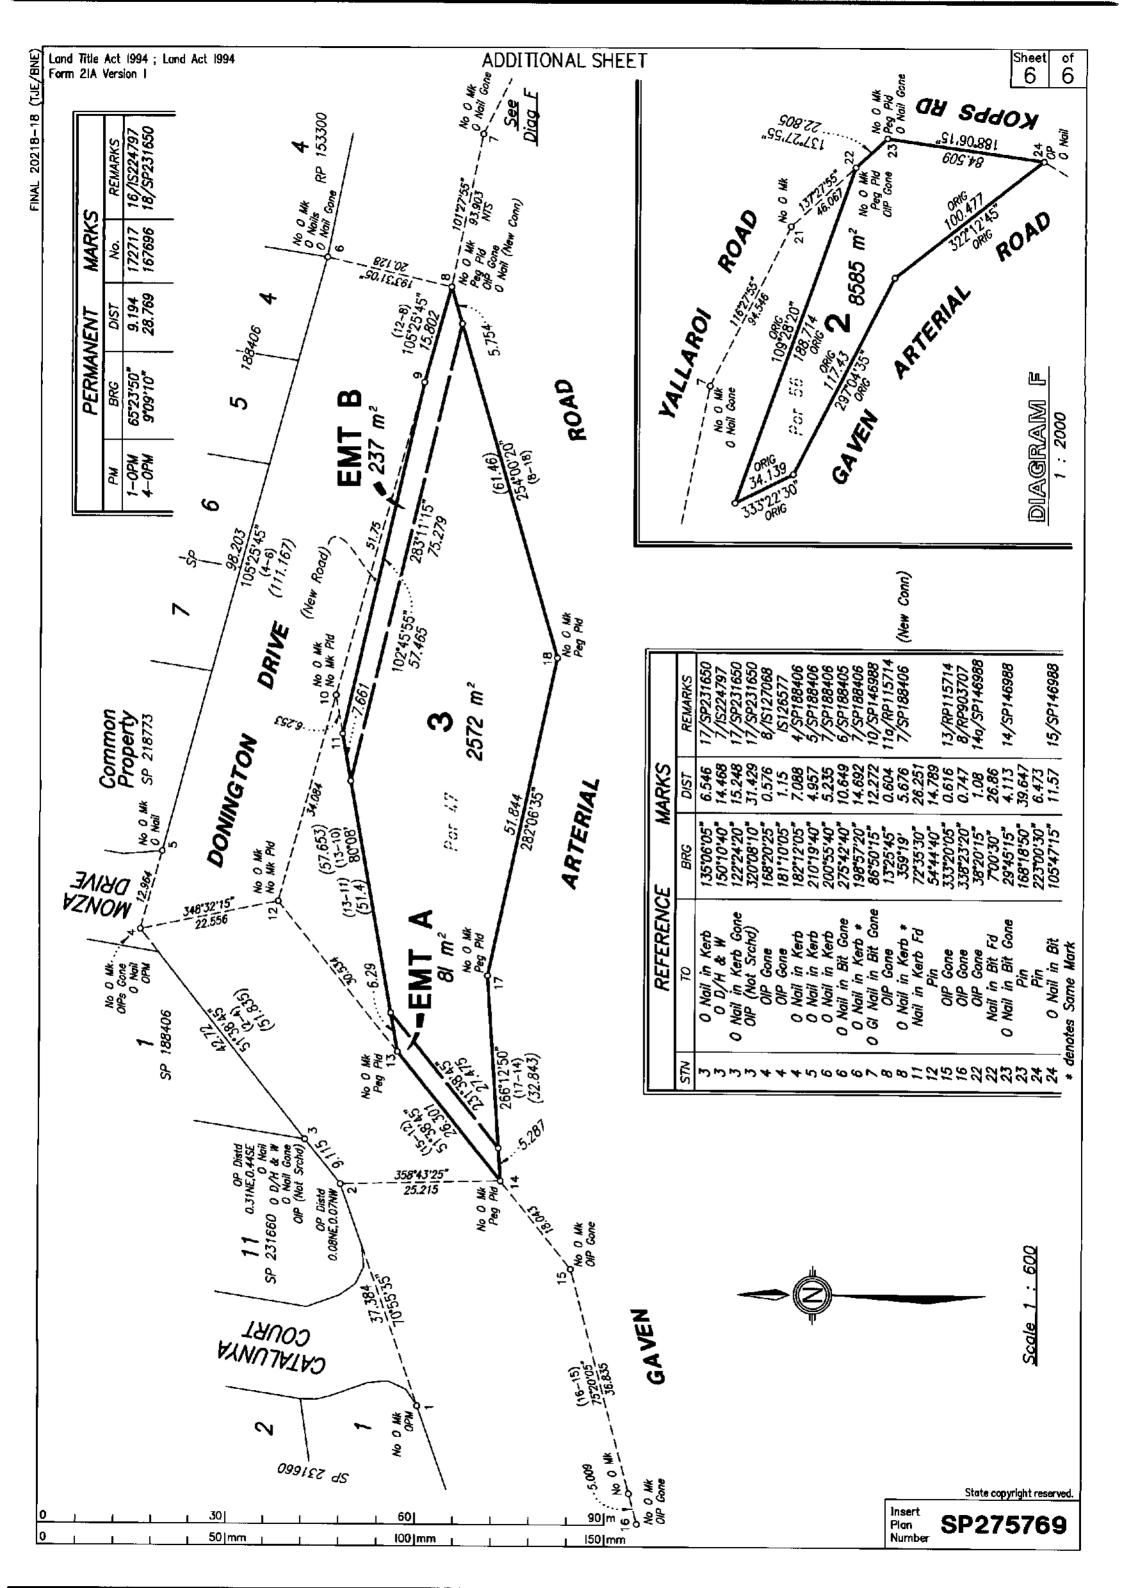


Land Title Act 1994; Land Act 1994 Form 218 Version I		WARNING: Folded or Mutilated Plans will not be accepted. Sheet 6 6 Plans may be rolled. Information may not be placed in the outer margins.							
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I. Certificate of Registered Owners or Lessees.	TV LTD	6. Title	Existing			Create			
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A.C.N. 103 517 586			Lot 800 o	n SP 279960	2, 3	, 3 & 801 New Road Easements A & B			
			I	ļ		į.	ı		
	***************************************		Ease	ment		Lots to be Enc	umbered]	
(Names in full)		71633		(Emt Y on SP2)5343A\	801		†	
*as Registered Owners of this land agree to this plan a	and dedicate the Public Use	71419		(Emt H on SP2	-				
Land as shown hereon in accordance with Section 50 c	of the Land Title Act 1994.	71419		(Emt G on SP2	•	801			
*as Lessees of this land agree to this plan.		,,,,,,		, 0 OII OI'2		1		1	
ag/									
Signature of *Registered Owners *Lessees	4	Мо	rtgage	Lots Fu	ılly Encum	bered Lots	Partially En	cumbered	
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						RP115714, RP7632		,,	
		The northern side of Donington Drive is fixed with reference to recent							
		surveys. There is a small amount of excess in line 5-6.							
		The southern side of Donington Drive is fixed by applying deed road width,							
			as per the original intent (RP115714).						
			Deed distances (vide RP159055) from station 12 used to fix stations 10 &						
		13.							
		Deed distances (vide SP146988) from stations 10 & 13 used to fix stations 8							
		& 14, respectively.							
*Rule out whichever is inapplicable			Boundaries 14-17-18-8 fixed by maintaining deed angles (including 13-14-17) and proportioning a small amount of excess in lines 14-17-17-18.						
11 11 11 11 11 11 11 11 11 11 11 11 11	-	13-14-17) and proportioning a small amount of excess in lines 14-17, 17-18 & 18-8.							
2. Planning Body Approval.				المستسلسم بيما الممد		d lines 0 7 04 00 0	2 24 5	value e	
	e City of Gold Coas:			sions (vide SP		id lines 8-7-21-22-2	3-24 NX80 (using	
hereby approves this plan in accordance with the:				······ (···					
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#		Lots				Survey Deposit			
Andrew Young				Orig		Lodgement \$			
Authorising Officer		7. Orig Gr	ant Alloco	ition :		, New Titles			
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	4. References : Dept File : PN35658つ10102		PS AUSTR VIZ-16		, בנם	IVIAL	•.		
CMS Number :	Local Govt :GC (C	Signed:	Ar .	` `. •		II. Insert			
Name:	Surveyor: 20218-18	Designati	·_/	adastral Surve		Plan SP	2757	69	
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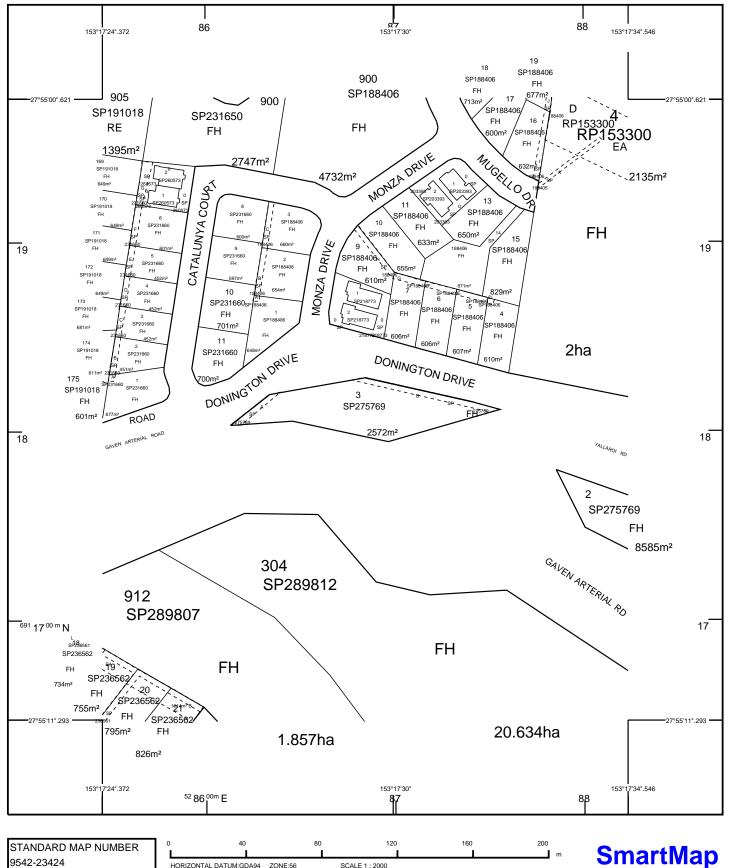






ANNEXURE E SMART MAP

SOURCE: DEPARTMENT OF NATURAL RESOURCES AND MINES





SUBJECT PARCEL DESCRIPTION

DCDB Lot/Plan 3/SP275769 Area/Volume 2572m² FREEHOLD GOLD COAST CITY Local Government MAUDSLAND Locality 63402/243

CLIENT SERVICE STANDARDS

PRINTED (dd/mm/yyyy) 19/06/2018

18/06/2018

Users of the information recorded in this document (the Information) accept all responsibility and risk associated with the use of the Information and should seek independent professional advice in relation to dealings with property.

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For further information on SmartMap products visit http://nrw.qld.gov.au/property/mapping/blinmap

An External Product of SmartMap Information Services

Based upon an extraction from the Digital Cadastral Data Base



Queensland Government

(c) The State of Queensland, (Department of Natural Resources and Mines) 2018.

ANNEXURE F DECISION NOTICE

SOURCE:

GOLD COAST CITY COUNCIL

Date: 30 October 2019
Contact: Nathan Seiler
Location: City Development
Telephone: 07 5582 8866

Your reference:

Our reference: OPW/2019/1241



Tellurium Gg Pty Ltd C/- Mortons Urban Solutions PO BOX 2484 SOUTHPORT QLD 4215

Dear Sir/Madam

Decision Notice

Property description Lot 3 SP275769

Property location Lot 3 Gaven Arterial Road, MAUDSLAND QLD 4210

Application details Operational Works

Please find enclosed the decision notice for the proposed development identified above.

For further information regarding the assessment of this application, access the Planning and Development page on City of Gold Coast's website <u>cityofgoldcoast.com.au</u> and reference application number OPW/2019/1241.

If you are unable to access the website, please email your query to mail@goldcoast.qld.gov.au and reference your application number.

Contacting us

Should you wish to clarify any issues contained in this letter, please do not hesitate to contact Planning Assessment on 07 5582 8866.

Yours sincerely

City Development Branch
Planning & Environment Directorate
For the Chief Executive Officer
Council of the City of Gold Coast

Our reference: PN349822/12/DA1 Your reference: MCU201701129

Decision notice —approval (with conditions)

(Given under section 63(2) of the *Planning Act 2016*)

Date of decision notice: 1 May 2018

Applicant details

Applicant name: Hatia Property Corporation Pty Ltd

Applicant contact details: Hatia Property Corporation Pty Ltd

C/- Mortons Urban Solutions

PO BOX 2484

SOUTHPORT QLD 4215

Application details

Application number: MCU 201701129

Approval sought: Combined Development Permit for Material change of use and

Reconfiguring a Lot

Details of proposed

development:

Material change of use (impact assessment) for Multiple dwellings

Reconfiguring a lot (impact assessment) for Community Title Subdivision

Location details

Street address: Gaven Arterial Road, Maudsland

Real property description: Lot 3 on SP275769

Decision

Date of decision: 1 May 2018

Decision details: Under Delegated Authority, the Manager of the City Development Branch

of Council has resolved to

Approve the development application in full with conditions

Referral agency(s) for the application

Not applicable – no part of the application required referral.

Details of the approval

Development permit Material change of use Multiple dwellings (seven (7) dwellings)

Development permit Reconfiguring a lot (1 into 4 lots and common property - Community Title

Subdivision)

Conditions

The conditions that have been imposed by Council, as Assessment manager, are enclosed.

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Further development permits

The following development permits are required to be obtained before the development can be carried out:

- Building works
- Operational works Vegetation clearing
- Operational works vehicle access works
- Operational works Landscaping works (public and private)
- Plumbing and drainage works

Notwithstanding the above, other approvals/development permits may be required.

Properly made submissions

There were no properly made submissions for this application.

Currency period for the approval (section 85 of the Planning Act 2016)

In accordance with section 85 of the *Planning Act 2016*, this approval has a currency period of six years from the date of this letter 2 May 2024.

Approved plans and drawings

Approved plans and drawings are attached and are identified in the conditions imposed by Council as the Assessment manager.

Appeal rights

Applicant	You have appeal rights in relation to this decision. An appeal may be made against, as applicable:
	the refusal of part of the development application; or
	a provision of the development approval; or
	 if a development permit was applied for, the decision to give a preliminary approval.
	An appeal must be started within 20 business days after this notice is given to you.
	An appeal may be made to the Planning and Environment Court or, for certain matters which are identified in section 1(2) of Schedule 1 of the <i>Planning Act 2016</i> , to a development tribunal.
	An appeal is started by lodging a notice of appeal with the registrar of the Planning and Environment Court or a development tribunal, as
	applicable. The notice of appeal must be in the approved form, succinctly state the grounds of the appeal and be accompanied by the required fee. An appellant to the Planning and Environment Court must give a copy of
	the notice of appeal, within 10 business days after the appeal is started, to the persons identified in section 230(3) of the <i>Planning Act 2016</i> . A person who is appealing to the Planning and Environment Court must
	comply with the rules of the court that apply to the appeal.
	An extract of Chapter 6, Part 1 and Schedule 1 of the <i>Planning Act 2016</i>
	is attached to this notice, which sets out further information about the appeal rights.

For further information please contact Thalia Allsop, Planner on p: 07 5582 8866 or via email mail@goldcoast.qld.gov.au who will be pleased to assist.

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AUTHORISED BY

Richard Webber

Supervising Planner

For the Chief Executive Officer

Council of the City of Gold Coast

Enc:

Conditions imposed by Council as Assessment manager Statement of reasons (given under section 63(4) of *Planning Act 2016*)

Attach:

Stamped approved plans and drawings Infrastructure charges notice for the approved development Appeal rights extracts

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MATERIAL CHANGE OF USE

General

1. Timing

- a All conditions of this development approval must be complied with at no cost to Council at all times unless otherwise stated in another condition.
- Where the timing in a condition is prior to commencement of the use and a Building Format Plan is lodged for approval, the timing in the condition changes from being prior to commencement of the use to being prior to the earlier of the commencement of the use and approval of the plan of subdivision. This timing requirement prevails despite any inconsistency with the timing requirement in another condition.

2. Approved drawings

Undertake and maintain the development generally in accordance with the following drawings:

Planning				
Drawing Title	Author	Date	Drawing No.	Ver
Donington Drive Site Plan	Dryhurst Stuart Architects	Jul- 2017	DA-1-10	В
Donington Drive Typology	Dryhurst Stuart Architects	Jul-2017	DA-1-11	В
Donington Drive Site Section	Dryhurst Stuart Architects	Jul-2017	DA-1-13	С
Donington Drive Residences: 2a,2b	Dryhurst Stuart Architects	Jul- 2017	DA-2-10	С
Donington Drive Residences: 2c, 2d & 4	Dryhurst Stuart Architects	Jul- 2017	DA-2-11	С
Donington Drive Residences: 6	Dryhurst Stuart Architects	Jul- 2017	DA-2-12	С
Donington Drive Residences: 8	Dryhurst Stuart Architects	Jul- 2017	DA-2-13	С
Donington Drive Residential Townhouse Type Plan (A1)	Dryhurst Stuart Architects	Jul- 2017	DA2-26	A
Donington Drive Residential Townhouse Type Plan (A3)	Dryhurst Stuart Architects	Jul- 2017	DA2-27	A
Donington Drive Residential Townhouse Type Plan (A3a)	Dryhurst Stuart Architects	Jul- 2017	DA2-27	А
Donington Drive Residential Townhouse Type Plan (C1)	Dryhurst Stuart Architects	Jul- 2017	DA2-29	A

The conditions of this approval are to be read in conjunction with the attached stamped approved drawings. Where a conflict occurs between the conditions of this approval and the stamped approved drawings, the conditions of this approval shall take precedence.

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3. Approved Plans

Undertake and maintain the development generally in accordance with the following plans:

Geotechnical Engineering						
Plan Title	Author	Date	Plan Reference No.	Ver		
Slope Stability Assessment for Residential Subdivision, Lot 3 on SP275769 Donington Drive, Maudsland	Morrison Geotechnic Pty Ltd	July 2017	Job No. GE17/142	-		

Health and Regulatory Services					
Plan Title	Author	Date	Plan Reference No.	Ver	
Proposed Residential Development Lot 2 Yallaroi Road and Lot 3 Donington Drive, Maudsland Road Traffic Noise Impact Report	CRG Acoustics P/L	14/7/17	17091 report rev.1	1	

Property

4. Private infrastructure

Ownership, operation and maintenance of the following private infrastructure is to vest at all times with the Body Corporate and/or legal authority:

Stormwater management devices and infrastructure monitored and managed in accordance with the SQID Maintenance Management Plan (MMP).

5. Restrictions regarding Council easements and infrastructure

- a No building work or deep landscaping is permitted over or within any Council public utility easement.
- b Ensure all proposed buildings, structures and footings are a minimum distance of 1.5 horizontal metres from Council infrastructure.
- c Ensure a minimum 2.4 metres unobstructed vertical clearance from the finished surface level above Council infrastructure.

Environmental and Landscaping

6. Vegetation clearing

Obtain an operational works approval for vegetation clearing in accordance with the Vegetation management code of the City Plan, prior to commencement of any works at no cost to Council:

and include in particular:

- i. The bushfire management plan.
- ii. The fauna management plan.
- iii. A vegetation management plan.
- iv. A sediment and erosion control and construction management plan.
- v. A letter from an EPA approved spotter catcher and any necessary fauna management plan or a QPWS endorsed fauna translocation management plan.

7. Landscaping works on private land

Obtain an operational works approval to landscape the site generally in accordance with the Statement of Landscape Intent listed below, prior to commencement of use at no cost to Council:

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Drawing Title	Author	Date	Drawing No.	Ver
Landscape concept plan	Andrew Gold Landscape Architecture	15 December 2017	17.097 Sheet 1	D
Timber fence detail	Andrew Gold Landscape Architecture	15 December 2017	17.096 Sheet 2	D
Proposed planting schedule	Andrew Gold Landscape Architecture	15 December 2017	17.096 Sheet 3	D

and include in particular:

- i. Unless otherwise specified within this condition, tree species must be a minimum bag size of 45L at the time of planting.
- ii. Tree species planted within the communal open space area must be a minimum bag size of 100L at the time of planting.
- iii. Palm species must be a minimum 3 metres in height at the time of planting.
- iv. Unless otherwise specified within this condition, shrub species must be a minimum 200mm pot size at the time of planting.
- v. Feature shrub species must be a minimum 300mm pot size at the time of planting.
- vi. A row of screening shrubs (minimum bag size of 45L at the time of planting) must be planted within the 600mm setback to the southern boundary adjacent to the dwellings.
- vii. A continuous row of screening shrubs must be incorporated along the northern frontage boundary adjacent to the dwellings.
- viii. A minimum of one (1) Syzygium 'Hinterland Gold' (minimum bag size 100L) must be planted within the northern frontage setback for each dwelling.
- ix. Screening shrubs are to be incorporated around the perimeter of the private courtyards.
- x. Location of existing and proposed street trees planting must be identified (to be approved as part of separate Operational works public landscaping application).
- xi. Tree species planted with root zones adjacent to structures must have root control barriers and/or structure strengthening systems installed. Full demonstration of these systems is required.
- xii. Include frontage fencing as shown on the approved referenced Statement of Landscape Intent.
- xiii. The locations and cross sections of all proposed bio-retention systems as required by the sites approved Stormwater Management Plan and identify:
 - A. Proposed filter media depths and surface treatments.
 - B. Planting densities and species are to be consistent with *City Plan Policy SC6.9 Land development guidelines*, section 6.9.3.
- b Construct and maintain the private landscaping identified above at no cost to Council at all times.

Transport

8. Off street vehicle and car parking facilities

Design and construct off street vehicle facilities at no cost to Council prior to the commencement of the use, generally in accordance with the Transport code of the City Plan and include in particular:

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- i. A minimum of 14 car parking spaces for residents, comprising:
 - 2 spaces for the dwelling on lot 1;
 - 2 spaces for the dwelling on lot 2;
 - 2 spaces for the dwelling on lot 3; and
 - 2 spaces for each of the multiple dwellings (8 spaces total) on lot 4.
- ii. All spaces are drained and sealed.
- b Maintain the off street vehicle and parking facilities at no cost to Council at all times.

Engineering

9. Telecommunications network

Design, construct and connect a telecommunications services network at no cost to Council and include in particular:

- a Provide underground telecommunications to the subject building/s within Lot 4, lead-in conduits and equipment space/s in a suitable location within the building/s, to suit the carrier of choice.
- b All new pit and pipe infrastructure required to be installed along public road(s), must be suitably sized to cater for future installation of fibre optic cables.
- c Meet the telecommunications industry standards (e.g. Telstra/NBN Co standards).

10. Rectification of Council's infrastructure

- a Rectify any damage caused to Council infrastructure (including kerb, channelling, service pits, footpaths and water and sewer reticulation networks) prior to commencement of the use at no cost to Council.
- b Construct and maintain the rectified Council infrastructure at no cost to Council prior to commencement of the use.

11. Detailed drawings of all vehicular crossings to be submitted

Detailed design drawing of the vehicular crossings must be submitted to the Council for approval by the Council prior to the construction of all the vehicular crossings. The vehicular crossings must comply with all Council's Standards and Drawings. The approved drawings will form part of this approval and a stamped copy will be returned to the applicant. The development must be carried out in accordance with the approved drawings.

12. Driveways and vehicular crossings

Obtain an operational works approval for the design and construction of the driveways and all vehicular crossings prior to commencement of the use at no cost to Council and include in particular:

- i. Construct and position to enable the maintenance of a public road and road verge, and not cause any obstruction to pedestrians or vehicular traffic.
- ii. Not cause damage to vehicles or road infrastructure.
- iii. Provide effective access between the road and the property.
- iv. Provide hydraulic capacity to allow stormwater flow towards the closest stormwater infrastructure.

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Stormwater Drainage

13. Overland flow paths and hydraulic alterations

- a The development must not obstruct any existing overland flow coming on to the site from external catchment located along the northern boundary of the site and must properly manage such flow to ensure no adverse impact externally.
- b The development must not:
 - i. Increase peak flow rates downstream from the site;
 - ii. Increase flood levels external to the site;
 - iii. Increase duration of inundation external to the site that could cause loss or damage.

Sewer and Water Works

14. Sewer reticulation

- a Design, construction and connect a sewer connection for the proposal to Council's sewer network at the existing maintenance hole located in the eastern corner of the site and the maintenance hole located near the intersection of Monza Drive and Yallaroi Road, prior commencement of the use at no cost to Council and include in particular:
 - Be in accordance with the SEQ Water Supply & Sewerage Design and Construction Code (SEQ WS&S D&C Code), Water and Sewerage Connections Policy.
 - The size of the sewer property service connection must be a minimum of 150 mm in accordance with Section 4.5.4 of the SEQ Water Supply & Sewerage Design & Construction Code (SEQ WS&S D&C Code).
 - iii Remove/seal/cap redundant sewer property services.

15. Water reticulation

- a Design, construction and connect a water connection for the proposal to the existing 150 mm potable water main crossing Yallaroi Road in the fronting verge of the site, prior to commencement of the use at no cost to Council and include in particular:
 - i Be in accordance with the SEQ Water Supply & Sewerage Design and Construction Code (SEQ WS&S D&C Code), and Water and Sewerage Connections Policy.
 - ii The property service, water meter box and water meter must be provided at the boundary of the development site.
 - iii Remove redundant water meters/connections.

16. Sub-metering

Provide individual sub-metering for each lot/unit including common property generally in accordance with the Metering Technical Specifications and the Water and Sewage Connections Policy.

17. Fire loading

Fire loading must not exceed 15 L/s for 2 hours.

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Construction Management

18. Certification of works

Provide Council with certificates prepared by qualified experts from the disciplines listed below, confirming as follows:

Subdivision Engineering					
Certified document	Certification date	Plan/ Drawing	Expert discipline	Requesting Council Section	
Contractual agreement (e.g. Agreement Advice or Completion Letter from Telstra. Alternatively, a copy of Master Development Agreement or Small Development Agreement from NBN Co).	Prior to commencement of the use	-	The authorised telecommuni cation carrier (e.g. Telstra, NBN Co)	Development Compliance	

The certification is to confirm:

Underground telecommunication infrastructure has been undertaken and installed in accordance with telecommunications industry standards (e.g. Telstra / NBN Co standards).

Health and Regulatory Services				
Certified document	Certification date	Plan/ Drawing	Expert discipline	Requesting Council Section
Acoustic compliance report	Prior to commencement of the use	Proposed Residential Development Lot 2 Yallaroi Road and Lot 3 Donington Drive, Maudsland Road Traffic Noise Impact Report prepared by CRG Acoustics P/L dated 14/7/17 ref. 17091 report rev.1	Acoustic Engineer	Health and Regulatory Services

The certification is to confirm:

The development has been designed in accordance with the established noise criteria and recommendations outlined in an approved Acoustic Report.

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Water and Waste				
Certified document	Certification date	Plan/ Drawing	Expert discipline	Requesting Council Section
An easement document and Survey Plans with the required easements dimensioned and shown centrally located over the proposed sewerage infrastructure located within the subject site	Prior to commencement of the use	Survey Plan	Registered surveyor	Compliance section

The certification is to confirm:

Easements are correctly located over the infrastructure and meet the requirements specified in the SEQ Water Supply and Sewerage Design and Construction Code for sewerage infrastructure.

19. Construction management plan

- a Prepare and submit for approval a Construction management plan generally in accordance with the Guidelines for Construction Management Plans prior to any works commencing.
- b The Construction management plan must be prepared by a suitably qualified professional and include in particular.
 - i Provide hours of construction.
 - ii Provide details on vehicle access (including responsibility for maintenance of the defined cartage route) during construction hours.
 - iii Provide details on traffic management (including loading, unloading and cartage routes).
 - iv Parking of vehicles (including on site employees and delivery vehicles).
 - v Maintenance of safe pedestrian movement across the site's frontage/s (including people with disabilities).
 - vi Provide details for the collection and control of Building waste and refuse disposal.
 - vii Details on the presentation of hoarding to the street.
 - viii Provide details for tree management.
 - ix Demonstrate how the general public will be protected from construction activities.
 - x Provide details on how the building site will be kept clean and tidy to maintain public safety and amenity.
- c Implement the Construction management plan during all construction works at no cost to Council.

Plumbing and Drainage Act 2002

20. Plumbing and drainage works

Obtain a compliance permit for all plumbing and drainage work prior to any compliance assessable work commencing.

Note:

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A compliance permit for plumbing and drainage works cannot approve the discharge of trade waste to Council's sewerage system. The generator of trade waste must complete an application for approval to discharge trade waste to Council's Sewerage System (available on Council's website).

Advice Notes

A. Further development permits/compliance permits

Further development permits and/or compliance permits from Council are required to facilitate the development of the approved works identified in this decision notice. These include:

Environmental Assessment

Operational works - vegetation clearing

City Assets

Operational works – vehicle access works

Gold Coast Water and Waste

Application to work on the City's Infrastructure

Landscape Assessment

- Operational works landscape works (private land)
- Operational works landscape works (public open space)

Plumbing and Drainage

Compliance permit for plumbing and drainage work

A copy of this decision notice and accompanying stamped drawings/plans must be submitted with any subsequent application identified above.

B. Compliance with conditions

Once this development approval takes effect, the conditions attach to the land and are applicable in perpetuity. It is a development offence to contravene a development approval, including any of its conditions.

C. Indigenous cultural heritage legislation and duty of care requirement

The Aboriginal Cultural Heritage Act 2003 ('ACHA') is administered by the Department of Aboriginal and Torres Strait Islander and Multicultural Affairs (DATSIMA). The ACHA establishes a duty of care to take all reasonable and practicable measures to ensure any activity does not harm Aboriginal cultural heritage. This duty of care:

- a Is not negated by the issuing of this development approval;
- b Applies on all land and water, including freehold land;
- c Lies with the person or entity conducting an activity; and
- d If breached, is subject to criminal offence penalties.

Those proposing an activity involving surface disturbance beyond that which has already occurred at the proposed site must observe this duty of care.

Details of how to fulfil this duty of care are outlined in the duty of care guidelines gazetted with the ACHA.

The applicant should contact DATSIMA's Cultural Heritage Coordination Unit on (07) 3405 3050 for further information on the responsibilities of developers under the ACHA.

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D. Applicant responsibilities

The applicant is responsible for securing all necessary approvals and tenure, providing statutory notifications and complying with all relevant laws.

Nothing in this decision notice alleviates the need for the applicant to comply with all relevant local, State and Commonwealth laws and to ensure appropriate tenure arrangements have been made where the use of/reliance upon land other than that owned by the applicant is involved. Without liming this obligation, the applicant is responsible for:

- a Obtaining all other/further necessary approvals, licences, permits, resource entitlements etc by whatever name called required by law before the development the subject of this approval can be lawfully commended and to carry out the activity for its duration;
- Providing any notifications required by law (by way of example only, to notify the administering authority pursuant to the *Environment Protection Act 1994* of environmental harm being caused/threatened by the activity, and upon becoming aware the premises is being used for a 'notifiable activity');
- Securing tenure/permission from the relevant owner to use private or public land not owned by the applicant (including for access required by conditions of approval);
- d Ensuring the correct siting of structures on the land. An identification survey demonstrating correct siting and setbacks of structures may be requested of the applicant to ensure compliance with this decision notice and applicable codes;
- e Providing Council with proof of payment of the Portable Long Service Leave building construction levy (or proof of appropriate exemption) where the value of the Operational Works exceed \$150,000. Acceptable proof of payment is a Q.Leave –Notification and Payment Form approved by the Authority. Proof of payment must be provided before Council can issue a development permit for the Operational works. This is a requirement of section 77(1) of the Building and Construction Industry (Portable Long Service Leave) Act 1991; and
- f Making payment of any outstanding Council rates and charges applicable to the development site prior to the lodgement of subdivision plans.
- Obtaining any necessary local government/state approvals where works require the installation of temporary ground anchoring into adjacent Road Reserves. Where ground anchoring is proposed into an adjacent private property, approval from the relevant property owners(s) is required

E. Weeds, pest animals and ants

Biosecurity Queensland of the Department of Agriculture and Fisheries leads the Government's efforts to prevent, respond to and recover from pests and diseases threatening agricultural prosperity, the environment, social amenity and human health.

All landscape materials, including but not limited to, soils, mulch, grass, gravel, potted or exground plants, pavers and timber used in landscape treatments must be free from weeds, pest animals and ants.

F. Fire ant control

Northern suburbs of the Gold Coast are within Fire Ant Biosecurity zone 2 and must remain vigilant for the presence of fire ants. Under the *Biosecurity Act 2014* individuals and organisations whose activities involve the movement or storage of fire ant carriers have a general biosecurity obligation to take all reasonable steps to ensure they do not spread fire ants. Movement of a fire ant carrier from within the fire ant biosecurity zone may need a biosecurity instrument permit. More information is available on the Department of Agriculture and Fisheries website www.daf.qld.gov.au/plants/weeds-pest-animals-ants/invasive-ants/fire-ants.

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G. Connections and disconnections

Any connection/disconnection to the existing water and sewerage networks will be at the applicant's cost. Prior to the connection/disconnection taking place, the applicant must obtain written approval from Water and Waste.

Refer to Water and Sewerage Connections Policy, available on Council's websitehttp://www.cityofgoldcoast.com.au

H. Connections to, alteration or realignment of Council infrastructure

Where development works require the connection to, alteration, removal or realignment of Council infrastructure or impact on other public utility infrastructure (e.g. telecommunications, electricity and gas), the applicant must obtain the necessary approvals from the relevant public utility authority prior to works commencing.

Connection to, alteration, removal or realignment of Council infrastructure includes (but is not limited to) fire hydrants, water service meters, sewer maintenance hole covers, stormwater drainage infrastructure, reinstatement of maintenance hole covers, stormwater drainage infrastructure, crossovers, footpaths, road pavement, kerb and channel, kerb ramps, medians, traffic islands, road furniture, signage and line-marking.

I. Stormwater

A property notification will be applied to the lot stating a stormwater management plan exists for the site and must be complied with at all times.

J. Bushfire management

A property notification will be applied to the lot/subsequent lots stating a bushfire management plan exists for the site and must be complied with at all times.

K. Water meter sizing

All water meters 50 mm in diameter or larger require an operation works approval. Refer to Water and Sewerage Connections Policy, available on Council's website: http://www.cityofgoldcoast.com.au

Property Notifications

A. Stormwater

There are development approval conditions applicable in relation to stormwater management on this lot/subsequent lots. All property owner(s) must ensure compliance with these conditions. Refer to Council of the City of Gold Coast's Decision Notice (MCU 201701129). A copy of Council's Decision Notice is available for viewing on Council's website www.goldcoastcity.com.au/pdonline

B. Bushfire management

There are development approval conditions applicable in relation to bushfire management on this lot/subsequent lots. All property owner(s) must ensure compliance with these conditions. Refer to Council of the City of Gold Coast's Decision Notice insert application number. A copy of Council's Decision Notice is available for viewing on Council's website www.goldcoastcity.com.au/pdonline

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RECONFIGURING A LOT

General

1. Timing

- a All conditions of this development approval must be complied with at no cost to Council at all times unless otherwise stated in another condition.
- Where the timing in a condition is prior to commencement of the use and a Building Format Plan is lodged for approval, the timing in the condition changes from being prior to commencement of the use to being prior to the earlier of the commencement of the use and approval of the plan of subdivision. This timing requirement prevails despite any inconsistency with the timing requirement in another condition.

2. Approved drawings

Undertake and maintain the development generally in accordance with the following drawings including as amended in red by the Council:

Planning					
Drawing Title	Author	Date	Drawing No.	Ver	
Donington Drive Proposed (Community Title) Subdivision Plan	Dryhurst Stuart Architects	Jul- 2017	DA-1-14	В	

The conditions of this approval are to be read in conjunction with the attached stamped approved drawings. Where a conflict occurs between the conditions of this approval and the stamped approved drawings, the conditions of this approval shall take precedence.

3. Approved Plans

Undertake and maintain the development generally in accordance with the following plans:

Hydraulics and Water Quality						
Plan Title	Author	Date	Plan Reference No.	Ver		
Donington Drive, Maudsland - Stormwater Quality and Quantity Management Plan	Storm Water Consulting	4 April 2018	Job No J5458	1.2		

Property

4. Private infrastructure

Ownership, operation and maintenance of the following private infrastructure is to vest at all times with the Body Corporate (CTS) and/or legal authority:

Stormwater management devices and infrastructure monitored and managed in accordance with the SQID Maintenance Management Plan (MMP).

5. Community Management Statement (CMS)

Proposed lots 1 - 4 and common property marked on the drawings listed below must be defined in the CMS as the scheme land:

Drawing Title	Author	Date	Drawing No.	Ver
Proposed (Community Title) Subdivision Plan	DSA	July 2017	DA-1-14	В

- b Undertake the above prior to a request is made to Council to approve the plan of subdivision.
- c Submit, immediately after its creation, the first CMS (signed by all relevant parties) to Council for notation and verification of the above.

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d Should a new/amended CMS be created, a copy of the new/amended CMS must be provided to Council within 5 business days of its creation.

6. Restrictions regarding Council easements and infrastructure

- a No building work or deep landscaping is permitted over or within any Council public utility easement.
- b Ensure all proposed buildings, structures and footings are a minimum distance of 1.5 horizontal metres from Council infrastructure.
- Ensure a minimum 2.4 metres unobstructed vertical clearance from the finished surface level above Council infrastructure.

Environmental and Landscaping

7. Landscaping works within public road reserve

a Obtain an operational works approval to landscape all public open space generally in accordance with the Statement of Landscape Intent listed below, prior to a request is made to Council to approve the plan of subdivision at no cost to Council:

Drawing Title	Author	Date	Drawing No.	Ver
Landscape Concept Plan	AGLA	15/12/2017	-	D

and include in particular:

- Ensure street trees are planted within the road reserve directly fronting the subject site along Donington Drive.
- ii. All street trees planted must be a minimum 100L bag size.
- iii. Ensure trees located within the public road reserve fronting the subject site on Gaven Arterial Road are retained and not disturbed or damaged during implementation of the approved works.
- iv. Trees must be a single-trunked canopy shade species able to attain a clear trunk height of 1800mm on maturity.
- v. Ensure all other existing vegetation is retained and not disturbed or damaged during implementation of the approved works. Should damage or removal occur, compensatory planting will be required at a 1:2 ratio.
- vi. All built structures and planting associated with an entry statement must be located within private property.
- vii. Provide annual maintenance costings and for all landscape items relevant to the development for the duration of the establishment and on maintenance periods.
- b Construct and maintain the public open space identified above until the asset is accepted "off maintenance" by the City in accordance with the procedures in City Planning Policy SC6.9 Land development guidelines, section 6.9.6.

8. Retaining structures (specific condition)

All parts of retaining structures (including footings) must be set back a minimum 600mm from street front property boundaries.

Engineering

9. Existing road

Obtain an operational works approval for the design and upgrade of the full frontage of the site to Donington Drive and Catalunya Court prior to a request is made to Council to approve the plan of subdivision at no cost to Council and include in particular:

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- i The existing edge restraints at the full frontage of the site to Donington Drive and Catalunya Court must be replaced with new barrier kerb and channels.
- The verge at the full frontage of the site to Donington Drive and Catalunya Court must have a 1 in 25 raising gradient.
- b Construct and maintain the roads identified above at no costs to Council until the asset is accepted "off maintenance" by the City in accordance with the procedures in City Planning Policy SC6.9 Land development guidelines, sections 6.9.6 and 6.9.7.

10. Footpaths

- a Obtain an operational works approval for the design and construction of a 1.5 metre wide footpath, prior to a request is made to Council to approve the plan of subdivision at no cost to Council and include in particular:
 - i A 1.5 metre wide footpath required along the full frontage of the site to Donington Drive and Catalunya Court (subdivision side only).
 - ii This new 1.5 metre wide footpath must be connected with the existing footpath adjacent to Lot 1 on SP231660.
- b Construct and maintain the footpaths identified above at no cost to Council until the asset is accepted "off maintenance" by the City in accordance with the procedures in City Planning Policy SC6.9 Land development guidelines, sections 6.9.6 and 6.9.7.

11. Electrical reticulation

Design, construct and connect an electrical reticulation system at no cost to Council and include in particular:

- a Provide underground electricity to all proposed lots.
- b No additional poles and pole-mounted transformers are to be erected within public roads.
- c Meet the requirements of the electricity supplier (e.g. Energex).

12. Telecommunications network

Design, construct and connect a telecommunications services network at no cost to Council and include in particular:

- a Provide underground telecommunications to all proposed lots and pit and pipe infrastructure along public roads.
- b All new pit and pipe infrastructure required to be installed along public road(s), must be suitably sized to cater for future installation of fibre optic cables.
- c Meet the telecommunications industry standards (e.g. Telstra/NBN Co standards).

13. Connection to Permanent survey marks

- a Connect all proposed lots to permanent survey marks (PSM's) in accordance with SC6.9 City Plan Policy Land Development Guidelines and Guidelines for Creation and Submission of ADAC.xml Files. All proposed lots must be connected to at least 2 permanent survey marks for inclusion in the City of Gold Coast Contributed Assets register.
- b New permanent survey marks must comply with the requirements of SC6.9 City Plan Policy Land Development Guidelines and include in particular:
 - i Be placed in locations to provide good coverage over the extent of the survey.
 - ii Be levelled on the Australian Height Datum and fixed with horizontal coordinates to the Map Grid of Australia (MGA 94) to a suitable Horizontal Positional Uncertainty (PU) < 30mm or better, Conventional 4TH order for vertical accuracy in accordance with Department of Natural Resources and Mines guidelines.
- c Connect lots to permanent survey marks prior to a request is made to Council to approve the plan of subdivision.

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14. Rectification of Council's infrastructure

- a Rectify any damage caused to Council infrastructure (including kerb, channelling, service pits, footpaths and water and sewer reticulation networks) prior to a request is made to Council to approve the plan of subdivision.
- b Construct and maintain the rectified Council infrastructure at no cost to Council prior to a request is made to Council to approve the plan of subdivision.

Stormwater Drainage

15. Overland flow paths and hydraulic alterations

- The development must not obstruct any existing overland flow coming on to the site from external catchment located along the northern boundary of the site and must properly manage such flow to ensure no adverse impact externally.
- b The development must not:
 - i. Increase peak flow rates downstream from the site;
 - ii. Increase flood levels external to the site;
 - iii. Increase duration of inundation external to the site that could cause loss or damage.

16. Bioretention basin maintenance management plan (specific condition)

- Prepare and implement a bioretention basin maintenance management plan (MMP) prior to the commencement of the use. The MMP must be prepared by a Registered Professional Engineer Queensland (RPEQ) specialising in stormwater management in accordance with City Plan Policy SC6.9 Land Development Guidelines and with reference to the Water by Design document Maintaining Vegetated Stormwater Assets, Version 1 February 2012.
- b The MMP must include, but not necessarily be limited to, the following key information:
 - i Design intent and description of the device(s).
 - ii The location and specific dimensions of the device(s).
 - iii Approved / designed water quality objectives.
 - iv Water quality monitoring procedures.
 - v Monitoring frequency.
 - vi Specifications and procedures for device(s) maintenance.
 - vii Plant and equipment access details for maintenance activities.
 - viii Maintenance activity schedule defining frequency, area (m2) per maintenance zone, hours, staff, plant and equipment, approximate costs per rotation, and per annum
 - ix Performance indicators / intervention levels / triggers for reactive maintenance.
 - x Any necessary preventative maintenance measures.
 - xi Acceptable solutions for specific items, i.e. acceptable plant species substitutions based on availability, hydraulic conductivity, water quality objectives, etc.
 - xii Approximate lifecycle maintenance costs.

Sewer and Water Works

17. Sewer reticulation

- Design, construction and connect a sewer connection for the proposal to Council's sewer network at the existing maintenance hole located in the eastern corner of the site and the maintenance hole located near the intersection of Monza Drive and Yallaroi Road, prior to a request is made to Council to approve the plan of subdivision at no cost to Council and include in particular:
 - i Be in accordance with the SEQ Water Supply & Sewerage Design and Construction Code (SEQ WS&S D&C Code), Water and Sewerage Connections

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Policy.

- ii The size of the sewer property service connection must be a minimum of 150 mm in accordance with Section 4.5.4 of the SEQ Water Supply & Sewerage Design & Construction Code (SEQ WS&S D&C Code).
- iii Remove/seal/cap redundant sewer property services.

18. Water reticulation

- a Design, construction and connect a water connection for the proposal to the existing 150 mm potable water main crossing Yallaroi Road in the fronting verge of the site, prior to a request is made to Council to approve the plan of subdivision at no cost to Council and include in particular:
 - i Be in accordance with the SEQ Water Supply & Sewerage Design and Construction Code (SEQ WS&S D&C Code), and Water and Sewerage Connections Policy.
 - ii The property service, water meter box and water meter must be provided at the boundary of the development site.
 - iii Remove redundant water meters/connections.

19. Sub-metering

Provide individual sub-metering for each lot/unit including common property generally in accordance with the Metering Technical Specifications and the Water and Sewage Connections Policy.

20. Fire loading

Fire loading must not exceed 15 L/s for 2 hours.

Construction Management

21. Certification of works

Provide Council with certificates prepared by qualified experts from the disciplines listed below, confirming as follows:

Hydraulics and Water Quality				
Certified document	Certification date	Plan/ Drawing	Expert discipline	Requesting Council Section
Bioretention basin maintenance management plan (MMP)	Prior to the commencement of use of the premises or lodgement of plan sealing application, whichever occurs first		Registered Professional Engineer Queensland (RPEQ)	Development Compliance

The certification / evidence is to confirm:

i. Bioretention basin maintenance management plan (MMP) has been prepared in accordance with City Plan Policy – Land Development Guidelines and with reference to the Water by Design document "Maintaining Vegetated Stormwater Assets" and handed over to the Body Corporate (CTS) of the development for future maintenance purpose.

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Hydraulics and W	ater Quality			
Certified document	Certification date	Plan/ Drawing	Expert discipline	Requesting Council Section
Post construction certification	Prior to the commencement of use of the premises or lodgement of plan sealing application, whichever occurs first	Stormwater Management Plan (Storm Water Consulting; 4 April 2018)	Registered Professional Engineer Queensland (RPEQ)	Development Compliance

The certification is to confirm:

All stormwater devices (quantity and quality) shown in the approved stormwater management plan, document and associated design drawings have been installed on-site in accordance with Council's approved stormwater management plan and document mentioned above and are functioning as designed.

Subdivision Engin	eering			
Certified document	Certification date	Plan/ Drawing	Expert discipline	Requesting Council Section
Certificate for electricity supply	Prior to a request is made to Council to approve the plan of subdivision	-	An authorised supplier (e.g. Energex)	Contributed Assets

The certification is to confirm:

Underground electricity supply is available to all proposed lots.

Subdivision Engin	eering			
Certified document	Certification date	Plan/ Drawing	Expert discipline	Requesting Council Section
Contractual agreement (e.g. Agreement Advice or Completion Letter from Telstra. Alternatively, a copy of Master Development Agreement or Small Development Agreement from NBN Co).	Prior to a request is made to Council to approve the plan of subdivision	-	The authorised telecommuni cation carrier (e.g. Telstra, NBN Co)	Contributed Assets

The certification is to confirm:

Underground telecommunication infrastructure has been undertaken and installed in accordance with telecommunications industry standards (e.g. Telstra / NBN Co standards).

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Subdivision Engin	eering			
Certified document	Certification date	Plan/ Drawing	Expert discipline	Requesting Council Section
Written confirmation for Permanent Survey Marks works	Prior to a request is made to Council to approve the plan of subdivision	-	Registered Cadastral Surveyor	Contributed Assets

The certification is to confirm:

That all lots are connected to permanent survey marks in accordance with the requirements contained within the permanent survey marks condition.

Water and Waste				
Certified document	Certification date	Plan/ Drawing	Expert discipline	Requesting Council Section
An easement document and Survey Plans with the required easements dimensioned and shown centrally located over the proposed sewerage infrastructure located within the subject site	Prior to a request is made to Council to approve the plan of subdivision	Survey Plan	Registered surveyor	Compliance section

The certification is to confirm:

Easements are correctly located over the infrastructure and meet the requirements specified in the SEQ Water Supply and Sewerage Design and Construction Code for sewerage infrastructure.

22. Erosion and sediment control

- a Undertake works generally in accordance with the Healthy waters code of the City Plan; and include in particular:
 - i. Sediment control structures e.g.: a sediment fence must be placed at the base of all materials on site to mitigate sediment run-off.
 - ii. A perimeter bund and/or diversion drain is constructed around the disturbed areas to prevent any outside clean stormwater from mixing with polluted / contaminated stormwater.
 - iii. All polluted/contaminated water from the site, including dewatering discharge, is treated to achieve the water quality objectives in Table 8.2.1 of the Queensland Water Quality Guidelines (DERM September 2009) prior to discharging from the site.
 - iv. Inspections for erosion and sediment control measures occur in accordance with the compliance procedures in City Planning Policy SC6.9 Land development guidelines, section 6.9.3.6.1.2 Compliance.

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Advice Notes

A. Development infrastructure

Development infrastructure required to be provided in implementing this development approval is non-trunk development infrastructure unless otherwise stated in a condition of the approval.

B. Further development permits/compliance permits

Further development permits and/or compliance permits from Council are required to facilitate the development of the approved works identified in this decision notice. These include:

Open Space Assessment

Operational works - landscape works

Water and Waste

Operational works - infrastructure

A copy of this decision notice and accompanying stamped drawings/plans must be submitted with any subsequent application identified above.

C. Compliance with conditions

Once this development approval takes effect, the conditions attach to the land and are applicable in perpetuity. It is a development offence to contravene a development approval, including any of its conditions.

D. Connections and disconnections

Any connection/disconnection to the existing water and sewerage networks will be at the applicant's cost. Prior to the connection/disconnection taking place, the applicant must obtain written approval from Water and Waste.

Refer to Water and Sewerage Connections Policy, available on Council's websitehttp://www.cityofgoldcoast.com.au

E. Indigenous cultural heritage legislation and duty of care requirement

The Aboriginal Cultural Heritage Act 2003 ('ACHA') is administered by the Department of Aboriginal and Torres Strait Islander and Multicultural Affairs (DATSIMA). The ACHA establishes a duty of care to take all reasonable and practicable measures to ensure any activity does not harm Aboriginal cultural heritage. This duty of care:

- a Is not negated by the issuing of this development approval;
- b Applies on all land and water, including freehold land;
- c Lies with the person or entity conducting an activity; and
- d If breached, is subject to criminal offence penalties.

Those proposing an activity involving surface disturbance beyond that which has already occurred at the proposed site must observe this duty of care.

Details of how to fulfil this duty of care are outlined in the duty of care guidelines gazetted with the ACHA.

The applicant should contact DATSIMA's Cultural Heritage Coordination Unit on (07) 3405 3050 for further information on the responsibilities of developers under the ACHA.

F. Applicant responsibilities

The applicant is responsible for securing all necessary approvals and tenure, providing statutory notifications and complying with all relevant laws.

Nothing in this decision notice alleviates the need for the applicant to comply with all relevant local, State and Commonwealth laws and to ensure appropriate tenure arrangements have been made where the use of/reliance upon land other than that owned by the applicant is involved. Without liming this obligation, the applicant is responsible for:

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- a Obtaining all other/further necessary approvals, licences, permits, resource entitlements etc by whatever name called required by law before the development the subject of this approval can be lawfully commended and to carry out the activity for its duration;
- b Providing any notifications required by law (by way of example only, to notify the administering authority pursuant to the *Environment Protection Act 1994* of environmental harm being caused/threatened by the activity, and upon becoming aware the premises is being used for a 'notifiable activity');
- c Securing tenure/permission from the relevant owner to use private or public land not owned by the applicant (including for access required by conditions of approval);
- d Ensuring the correct siting of structures on the land. An identification survey demonstrating correct siting and setbacks of structures may be requested of the applicant to ensure compliance with this decision notice and applicable codes;
- e Providing Council with proof of payment of the Portable Long Service Leave building construction levy (or proof of appropriate exemption) where the value of the Operational Works exceed \$150,000. Acceptable proof of payment is a Q.Leave –Notification and Payment Form approved by the Authority. Proof of payment must be provided before Council can issue a development permit for the Operational works. This is a requirement of section 77(1) of the Building and Construction Industry (Portable Long Service Leave) Act 1991; and
- f Making payment of any outstanding Council rates and charges applicable to the development site prior to the lodgement of subdivision plans.
- Obtaining any necessary local government/state approvals where works require the installation of temporary ground anchoring into adjacent Road Reserves. Where ground anchoring is proposed into an adjacent private property, approval from the relevant property owners(s) is required

G. Weeds, pest animals and ants

Biosecurity Queensland of the Department of Agriculture and Fisheries leads the Government's efforts to prevent, respond to and recover from pests and diseases threatening agricultural prosperity, the environment, social amenity and human health.

All landscape materials, including but not limited to, soils, mulch, grass, gravel, potted or exground plants, pavers and timber used in landscape treatments must be free from weeds, pest animals and ants.

H. Fire ant control

Northern suburbs of the Gold Coast are within Fire Ant Biosecurity zone 2 and must remain vigilant for the presence of fire ants. Under the *Biosecurity Act 2014* individuals and organisations whose activities involve the movement or storage of fire ant carriers have a general biosecurity obligation to take all reasonable steps to ensure they do not spread fire ants. Movement of a fire ant carrier from within the fire ant biosecurity zone may need a biosecurity instrument permit. More information is available on the Department of Agriculture and Fisheries website www.daf.qld.gov.au/plants/weeds-pest-animals-ants/invasive-ants/fire-ants.

I. Connections to, alteration or realignment of Council infrastructure

Where development works require the connection to, alteration, removal or realignment of Council infrastructure or impact on other public utility infrastructure (e.g. telecommunications, electricity and gas), the applicant must obtain the necessary approvals from the relevant public utility authority prior to works commencing.

Connection to, alteration, removal or realignment of Council infrastructure includes (but is not limited to) fire hydrants, water service meters, sewer maintenance hole covers, stormwater drainage infrastructure, reinstatement of maintenance hole covers, stormwater drainage infrastructure, crossovers, footpaths, road pavement, kerb and channel, kerb ramps, medians, traffic islands, road furniture, signage and line-marking.

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J. Stormwater

A property notification will be applied to the lot stating a stormwater management plan exists for the site and must be complied with at all times.

K. Water meter sizing

All water meters 50 mm in diameter or larger require an operation works approval.

Refer to Water and Sewerage Connections Policy, available on Council's website: http://www.cityofgoldcoast.com.au

L. Bushfire management

A property notification will be applied to the lot/subsequent lots stating a bushfire management plan exists for the site and must be complied with at all times.

Property Notifications

A. Stormwater

There are development approval conditions applicable in relation to stormwater management on this lot/subsequent lots. All property owner(s) must ensure compliance with these conditions. Refer to Council of the City of Gold Coast's Decision Notice (MCU 201701129). A copy of Council's Decision Notice is available for viewing on Council's website www.goldcoastcity.com.au/pdonline

B. Bushfire management

There are development approval conditions applicable in relation to bushfire management on this lot/subsequent lots. All property owner(s) must ensure compliance with these conditions. Refer to Council of the City of Gold Coast's Decision Notice insert application number. A copy of Council's Decision Notice is available for viewing on Council's website www.goldcoastcity.com.au/pdonline

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Statement of reasons (given under section 63(4) of the *Planning Act 2016*)

Details of proposed development

The proposed development is for Combined Development Permit for a Material change of use for Multiple dwellings (seven (7) dwellings) and Reconfiguring a lot (1 into 4 lot and common property Community Title Subdivision).

Assessment benchmarks

The following assessment benchmarks applied to the proposed development:

- Emerging communities zone code
- Bushfire hazard overlay code
- Environmental significance overlay code
- · Landslide hazard overlay code
- Driveways and vehicular crossings code
- Fire services in development accessed by common private title code
- General development provisions code
- Healthy waters code
- Landscape work code
- Solid waste management code
- Transport code
- Vegetation management code

Matters raised in submissions

No submissions received.

Reasons for decision

Following an assessment of the development application against all of the assessment benchmarks listed above, it was determined:

- A low-rise, low-intensity development is achieved;
- The development integrates into the surrounding residential development due to the combined detached and attached dwelling types, building and lot design, orientation and access to the existing low order residential streets and ample private open space provided.

Compliance with assessment benchmarks

The proposed development did not comply with some of the assessment benchmarks listed above; however, despite this it was still approved for the reasons listed below.

Assessment benchmark	Reasons for the approval despite non-compliance with benchmark
Environmental significance overlay code – Priorities Species PO14	Due to the site's location, bound by roads on all sides, movement of koalas through the site is not encouraged.
Multiple accommodation code – Communal open space PO10	The development is designed to provide three (3) detached dwelling houses located on their own lot in combination with four (4) attached dwelling

68723337 Page 24 of 25

units located on the forth lot.

- Each dwelling is provided with ample private open space, between 79m² and 229m², (average of 146m² per dwelling),
- Private open space exceeds the required combined private and communal open space requirements per dwelling.
- The development complies with the overall outcomes of the Multiple dwelling code.

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07 5582 8866

Telephone:
Your reference:

Our reference: PN349822/12/DA1

MCU201701129

GOLDCOAST.

Hatia Property Corporation Pty Ltd C/- Mortons Urban Solutions PO BOX 2484 SOUTHPORT QLD 4215

Dear Sir/Madam

DECISION NOTICE

Application details: DEVELOPMENT PERMIT FOR COMBINEDAPPLICATION (IMPACT

ASSESSMENT) FOR MATERIAL CHANGE OF USE FOR MULTIPLE DWELLINGS AND RECONFIGURING A LOT (1 INTO 4 LOT COMMUNITY

TITLE SUBDIVISION)

Property description: Lot 3 on SP275769

Location details: Gaven Arterial Road, Maudsland

Please find enclosed the decision notice for the proposed development identified above. For further information regarding the assessment of this application, access the Planning and Development page on City of Gold Coast's website cityofgoldcoast.com.au and reference application number MCU201701129.

If you are unable to access the website, please email your query to mail@goldcoast.qld.gov.au and reference your application number.

Contacting us

Should you wish to clarify any issues contained in this letter, please do not hesitate to contact Planning Assessment on 07 5582 8866.

Yours sincerely

City Development Branch Economy, Planning & Environment Directorate City of Gold Coast

TA:JM

5 x attachments

ANNEXURE G INFRASTRUCTURE CHARGES NOTICE

SOURCE: GOLD COAST CITY COUNCIL



Infrastructure Charge Notice

To: HATIA PROPERTY CORPORATION PTY LTD

C/- MORTONS URBAN SOLUTIONS

PO BOX 2484

SOUTHPORT QLD 4215

Cc: HATIA PROPERTY CORPORATION PTY LTD

PO BOX 2084

RUNCORN QLD 4113

Land to which charges apply

The land to which the charges in this notice apply is.

Property description LOT3 SP275769

Property address GAVEN ARTERIAL ROAD MAUDSLAND

Total levied charge payable

\$ 170,015.40

+ADJUSTMENTS

Due date for payment

Total payable prior to the earliest of the following events: when the change happens or final plumbing inspection being undertaken or issue of a certificate of classification or final inspection certificate for building work being issued.

Payment details

Payment of the charges must be made in accordance with the "How to pay methods" section of this notice.

Adjustments to charge

The levied charge will automatically increase by the lesser of the following:

- (a) The difference between the levied charge and the maximum adopted charge the local government could have levied for the development when the charge is paid; and
- (b) The increase worked out using the PPI, adjusted according to the 3-yearly PPI average, for the period starting on the day the levied charge is levied and ending on the day the charge is paid.

'3-yearly PPI average' and 'PPI' have the meanings given in the *Planning Act* 2016.

As the charge amount stated above is current at the date the notice was generated, the total charges due at the date of payment may be greater.

Offsets and/or Refunds

Offsets (if applicable) will be provided consistent with the provisions of the Planning Act 2016 and Council's Charges Resolution. If applicable, details of the offset are provided on this Infrastructure Charge Notice.

Failure to pay charge

A levied charge is, for the purposes of recovery, taken to be rates of the local government that levied it.

Document: #69465899 Page 1 of 6



Authority for charge	The charges in this notice are payable in accordance with the <i>Planning Act 2016</i> .
GST	GST does not apply to payments or contributions made by developers to Government which relate to, or relates to, an application for the provision, retention, or amendment of a permission, exemption, authority or licence (however described) under the <i>Planning Act 2016</i> .
Enquiries	Enquiries regarding this Infrastructure Charge Notice should be directed to the Developer Contribution Group on Ph: (07) 5582 8300, during office hours, 9.00am to 5.00pm, Monday to Friday or e-mail dcg@goldcoast.qld.gov.au.

Document: #69465899 Page 2 of 6



Infrastructure Charge Notice

Tuesday, 01 May 2018

Application PN349822/12/DA1

Site address GAVEN ARTERIAL ROAD, MAUDSLAND

Application number & code 201701129 MCU

Application description MULTIPLE DWELLINGS X 4 AND DWELLING HOUSE X 3

Officer name Lauren Balfe

Charge calculation

Charges Resolution No.1	of 2017			
	Qty		Rate	Gross Charge Amount
Dwelling House 3+ Bedroom	3 Dwellings	@	\$ 28,335.90	\$ 85,007.70
Multiple Dwelling 3+ Bedroom	4 Dwellings	@	\$ 28,335.90	\$ 113,343.60
				\$ 198,351.30
Net Charge Summary				
Gross Charge Amount	Appl	ied Credit Amount	Ne	Charge Amount
\$ 198 351 30		\$ 28 335 90		\$ 170 015 40

Applied credit details

Credit applied for one existing lot.

Office Use Only	
\$ 94,358.58	OTHINF
\$ 57,125.16	SEWINF
\$ 18,531.66	WTRINF
\$ 170,015.40	

Document: #69465899 Page 3 of 6



DECISION NOTICE

DECISION TO GIVE AN INFRASTRUCTURE CHARGES NOTICE

Pursuant to section 119 of the *Planning Act 2016*, on the 1st of May 2018, the City decided to give this infrastructure charges notice. The date the development application was approved is set out on the first page of the decision notice approving the development application.

Appeal rights

You have appeal rights in relation to this notice. An appeal may be made against an infrastructure charges notice on 1 or more of the following grounds:

- (a) the notice involved an error relating to:
 - (i) the application of the relevant adopted charge; or

Examples of errors in applying an adopted charge:

- the incorrect application of gross floor area for a non-residential development
- applying an incorrect 'use category', under a regulation, to the development
 - (ii) the working out of extra demand, for section 120 of the Planning Act 2016; or
 - (iii) an offset or refund; or
- (b) there was no decision about an offset or refund; or
- (c) if the infrastructure charges notice states a refund will be given the timing for giving the refund; or
- (d) for an appeal to the Planning and Environment Court the amount of the charge is so unreasonable that no reasonable relevant local government could have imposed the amount.

To remove any doubt, the *Planning Act 2016* declares that an appeal against an infrastructure charges notice must not be about:

- (a) the adopted charge itself; or
- (b) for a decision about an offset or refund:
 - (i) the establishment cost of trunk infrastructure identified in a local government infrastructure plan; or
 - (ii) the cost of infrastructure decided using the method included in the local government's charges resolution.

An appeal must be started within 20 business days after the infrastructure charges notice is given to you.

An appeal may be made to the Planning and Environment Court or to a development tribunal.

An appeal is started by lodging a notice of appeal with the registrar of the Planning and Environment Court or a development tribunal, as applicable. The notice of appeal must be in the approved form, succinctly state the grounds of the appeal and be accompanied by the required

Document: #69465899 Page 4 of 6



fee.

An appellant to the Planning and Environment Court must give a copy of the notice of appeal, within 10 business days after the appeal is started, to the persons identified in section 230(3) of the *Planning Act 2016.* A person who is appealing to the Planning and Environment Court must comply with the rules of the court that apply to the appeal.

Chapter 6, Part 1 and Schedule 1 of the *Planning Act 2016* sets out further information about appeal rights.

Document: #69465899 Page 5 of 6



How to pay methods



Pay by mail

Ordinary mail

Simply enclose this Notice and your cheque or money order made payable to Gold Coast City Council in an envelope and post it to this address:

Council of the City of Gold Coast PO Box 5042 GCMC QLD 9729



Customer Service Centre in person

Pay at any Customer Service Centre with cash, cheque, or debit card (no surcharge), MasterCard or Visa (maximum \$50,000 using credit card)
Payment by credit card will incur a surcharge.

Customer Service Centres

Coolangatta

Monday to Friday 8.15am to 4.30pm

Broadbeach 61 Sunshine Boulevard, Mermaid

Waters

Bundall 8 Karp Court, Bundall

Burleigh Heads Park Avenue, Burleigh Heads

Coolangatta

Helensvale Cnr Lindfield Road and Sir John

Overall Drive, Helensvale

The Strand, Marina Parade,

Nerang 833 Southport Nerang Road,

Nerang

Palm Beach 26 11th Avenue, Palm Beach

Southport 47 Nerang Street, Southport

Upper Coomera Cnr Abraham Road and Reserve

Road, Upper Coomera

How to contact us



07 5582 8866 or 1300 69 4222

(7am to 6pm, Monday to Friday), or from outside of Australia call +61 7 5582 8866



Visit us at any Customer Service Centre Open hours; cityofgoldcoast.com.au



Council of the City of Gold Coast PO Box 5042, GOLD COAST MC QLD 9729

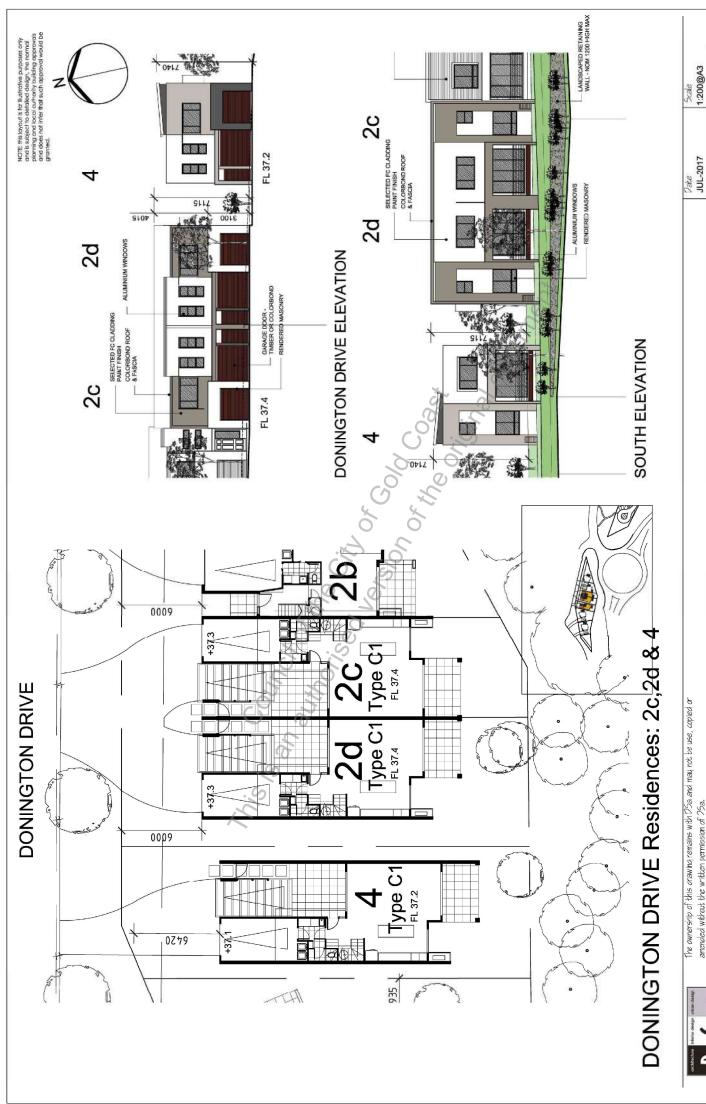


goldcoast.qld.gov.au

Document: #69465899 Page 6 of 6

ANNEXURE H PLANS AND DRAWINGS

SOURCE: DRYHURST STUART ARCHITECTS




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HATIA PROPERTY CORPORATION

PROPOSED RESIDENTIAL DEVELOPMENT - LOT 3 on SP275769 - DONINGTON DRIVE, MAUDSLAND

155UC 206.2 DA-2-11

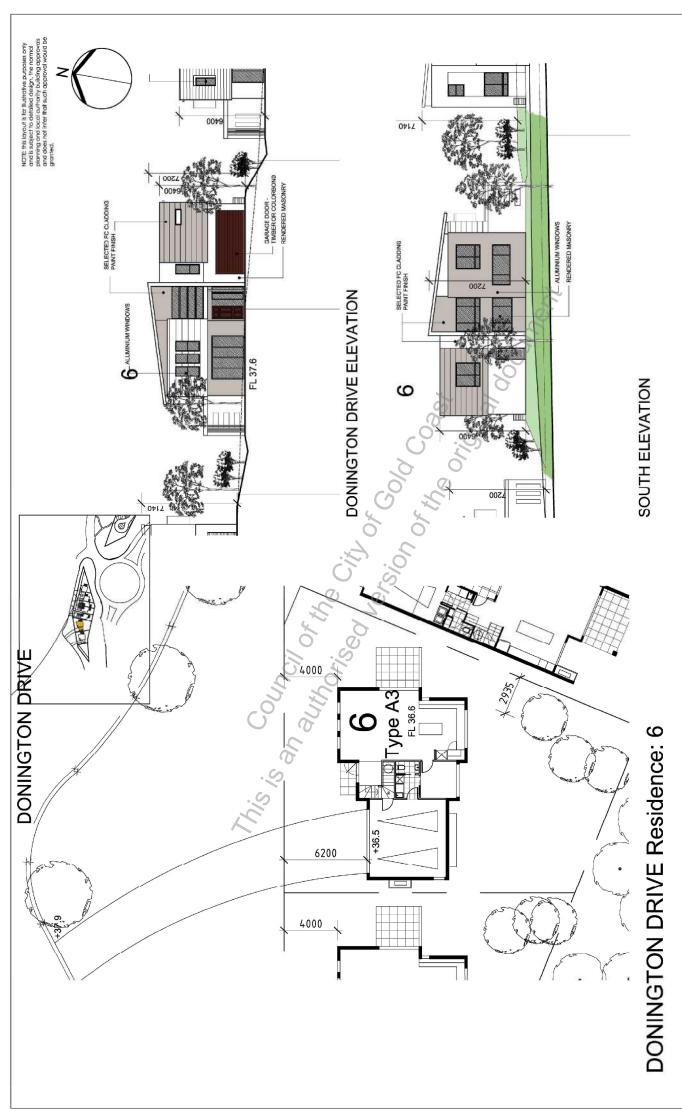Mortons Urban Solutions



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HATIA PROPERTY CORPORATION

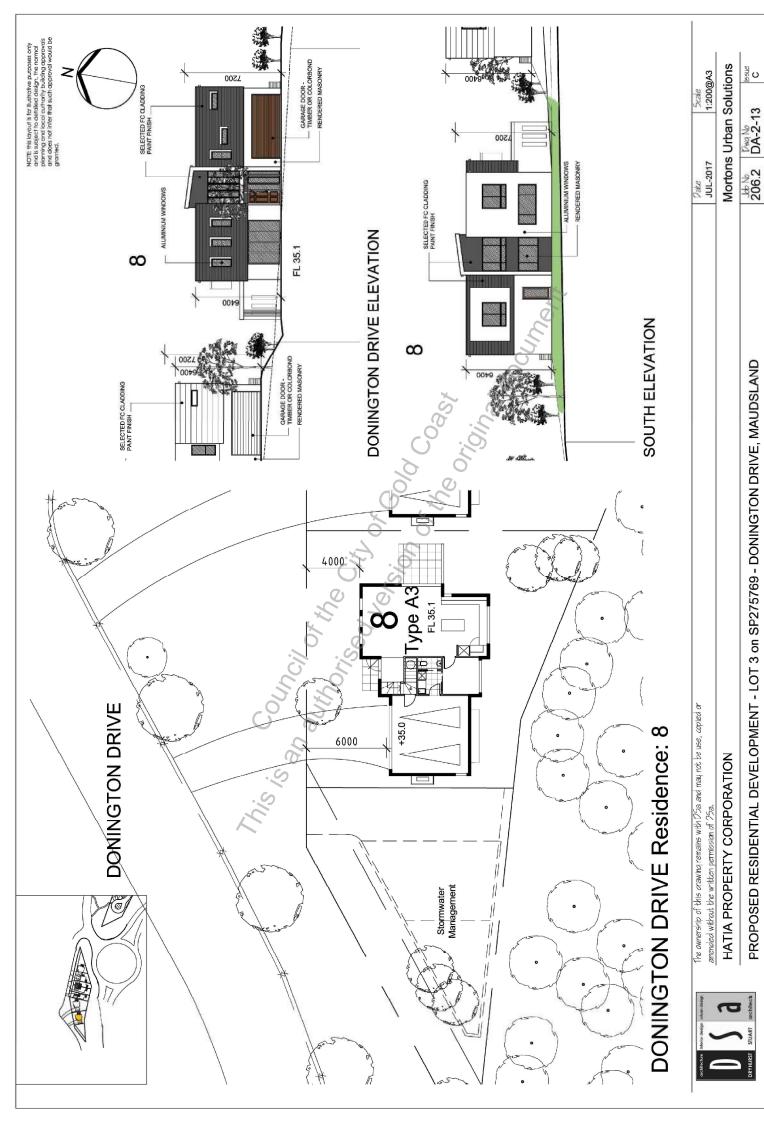
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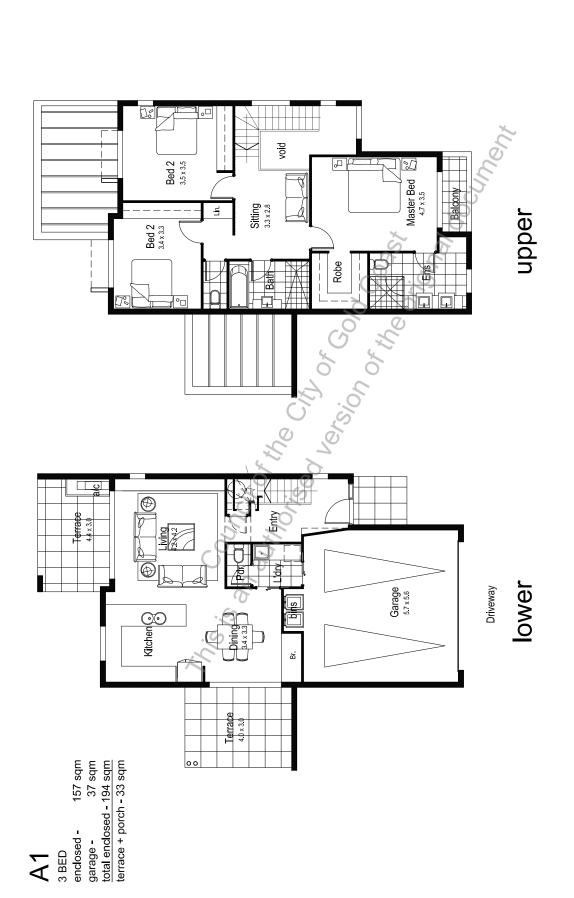
Mortons Urban Solutions

Date JUL-2017

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206.2 DA-2-12





DONINGTON DRIVE RESIDENTIAL Townhouse Type Plan



The ownership of this drawing remains with DSa and may not be use, copied or amended without the written permission of DSa.

HATIA PROPERTY CORPORATION


PROPOSED RESIDENTIAL DEVELOPMENT - LOT 3 on SP275769 - DONINGTON DRIVE, MAUDSLAND

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206.2 206.2

| *Date* | JUL-2017



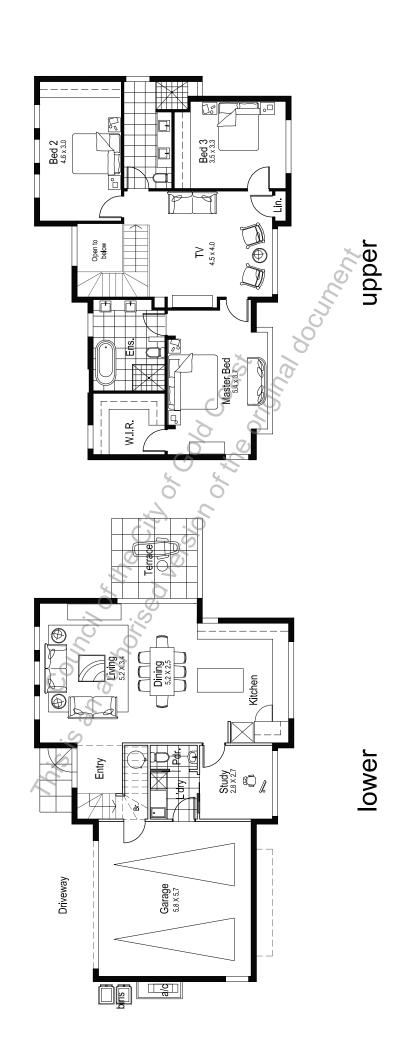3 BED + STUDY
enclosed - 185 sqm
garage - 37 sqm
total enclosed - 222 sqm
terrace + porch - 13 sqm



DONINGTON DRIVE RESIDENTIAL Townhouse Type Plan



The ownership of this drawing remains with DSa and may not be use, copied or samended without the written permission of DSa.

HATIA PROPERTY CORPORATION


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Mortons Urban Solutions

| *Date* | JUL-2017 206.2 DA2-27

A3a

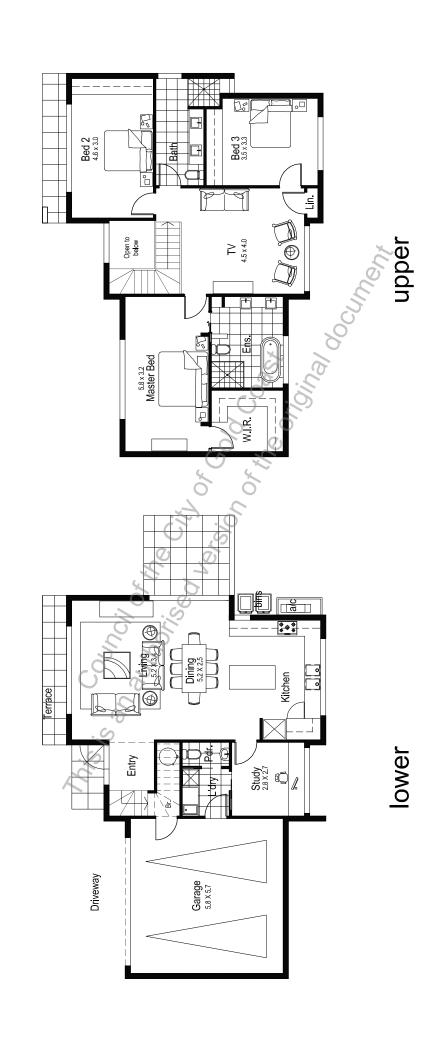3 BED + STUDY
enclosed - 185 sqm
garage - 37 sqm
total enclosed - 222 sqm
terrace + porch - 18 sqm



DONINGTON DRIVE RESIDENTIAL Townhouse Type Plan



The ownership of this drawing remains with ${\cal D}$ Sa and may not be use, copied or amended without the written permission of ${\cal D}$ Sa,

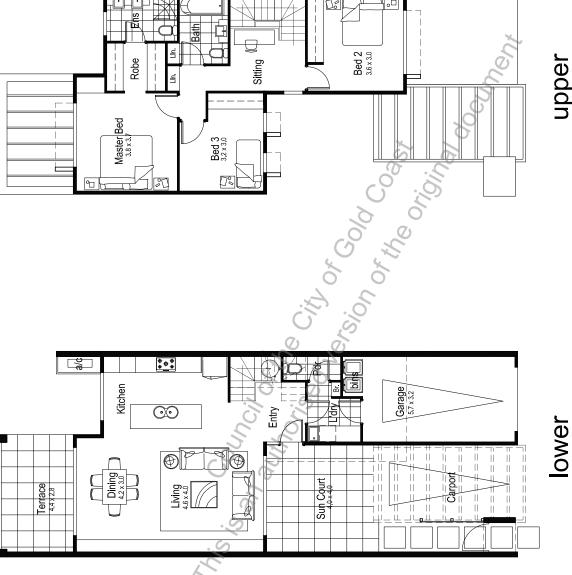
HATIA PROPERTY CORPORATION

PROPOSED RESIDENTIAL DEVELOPMENT - LOT 3 on SP275769 - DONINGTON DRIVE, MAUDSLAND

<u>8</u> ₹
DA2-27
Job No 206.2

Mortons Urban Solutions

Date JUL-2017



garage - 21 sqm total enclosed - 156 sqm

16sqm

carport

terrace + porch 25sqm

133 sqm

3 BED - courtyard enclosed - upper

DONINGTON DRIVE RESIDENTIAL Townhouse Type Plan



The ownership of this drawing remains with D5a and may not be use, copied or

HATIA PROPERTY CORPORATION

PROPOSED RESIDENTIAL DEVELOPMENT - LOT 3 on SP275769 - DONINGTON DRIVE, MAUDSLAND

Mortons Urban Solutions

Date JUL-2017

206.2 DA2-29



View 1 - from Donington Drive looking south



View 2 - from Donington Drive looking south



88 89 89

View 3 - from Gaven Arterial Island looking north-west

DONINGTON DRIVE Perspective Views



The ownership of this arawing remains with 195a and may not be use, copied or amended without the written permission of 195a.

HATIA PROPERTY CORPORATION

PROPOSED RESIDENTIAL DEVELOPMENT - LOT 3 on SP275769 - DONINGTON DRIVE, MAUDSLAND

Mortons Urban Solutions

Date NOV-2017 206.2 DA-3-05



Colour scheme

Resene Rice Cake G94-010-092

Resene Half Baltic Sea N46-002-264

Resene Eighth Friar Grey N80-008-082

Resene Awash B69-031-226

Resene Half Cobblestone G64-009-099

Stained Timber Resene Desperado O42-074-043

Residential Development

DEVELOPMENT APPLICATION Oo Donington Drive, Maudsland

Hatia Property Corporation

View from Donington Drive



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HATIA PROPERTY CORPORATION

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39 - DONINGTON DRIVE, MAUDSLAND

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Date JUL-2017

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NOTE: this layout is for flustrative purposes only and is subject to detailed design, the named purposes one of order or authority building approvate and aces not infer that such approval would be granted.



DONINGTON DRIVE Site Plan



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Mortons Urban Solutions

Date JUL-2017 Senc

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Beds

TYPE

Development Summary

DONINGTON DRIVE Typology

Density: 27.2 units/Ha or 367 sqm/unit

Site Cover: 904 sqm (35.1%)

Site Area: 2572 sqm

courtyard Total Yield

5

A3/A3a

A1




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HATIA PROPERTY CORPORATION

PROPOSED RESIDENTIAL DEVELOPMENT - LOT 3 on SP275769 - DONINGTON DRIVE, MAUDSLAND

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Date JUL-2017



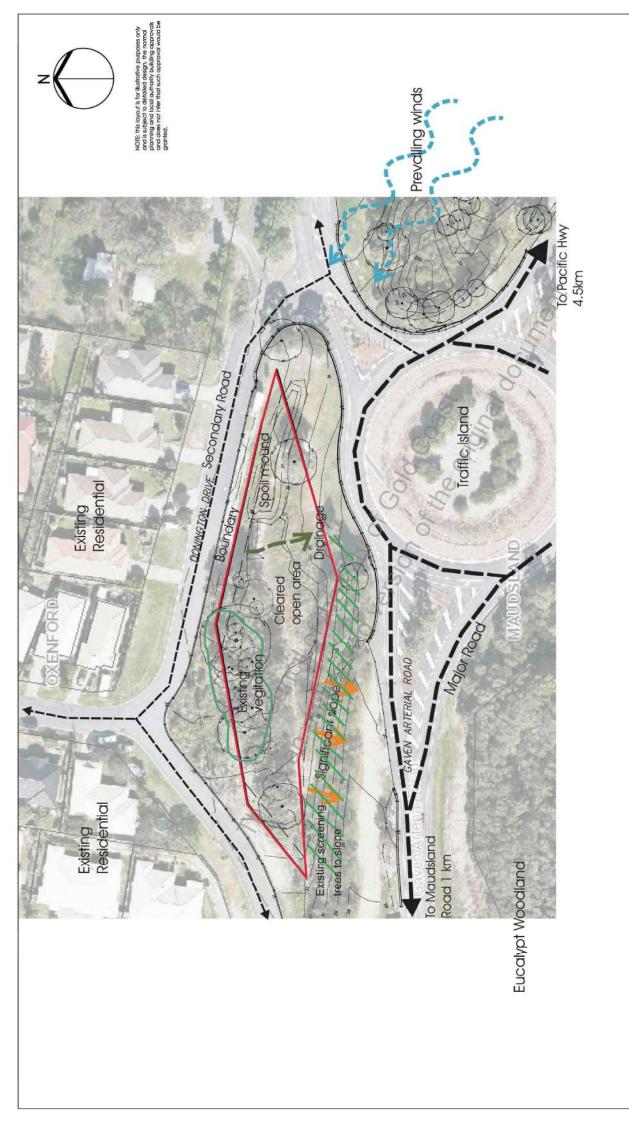DONINGTON DRIVE Site Analysis



The ownership of this drawing remains with DSa and may not be use, capied or amended without the written permission of DSa.


HATIA PROPERTY CORPORATION

PROPOSED RESIDENTIAL DEVELOPMENT - LOT 3 on SP275769 - DONINGTON DRIVE, MAUDSLAND

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Date JUL-2017

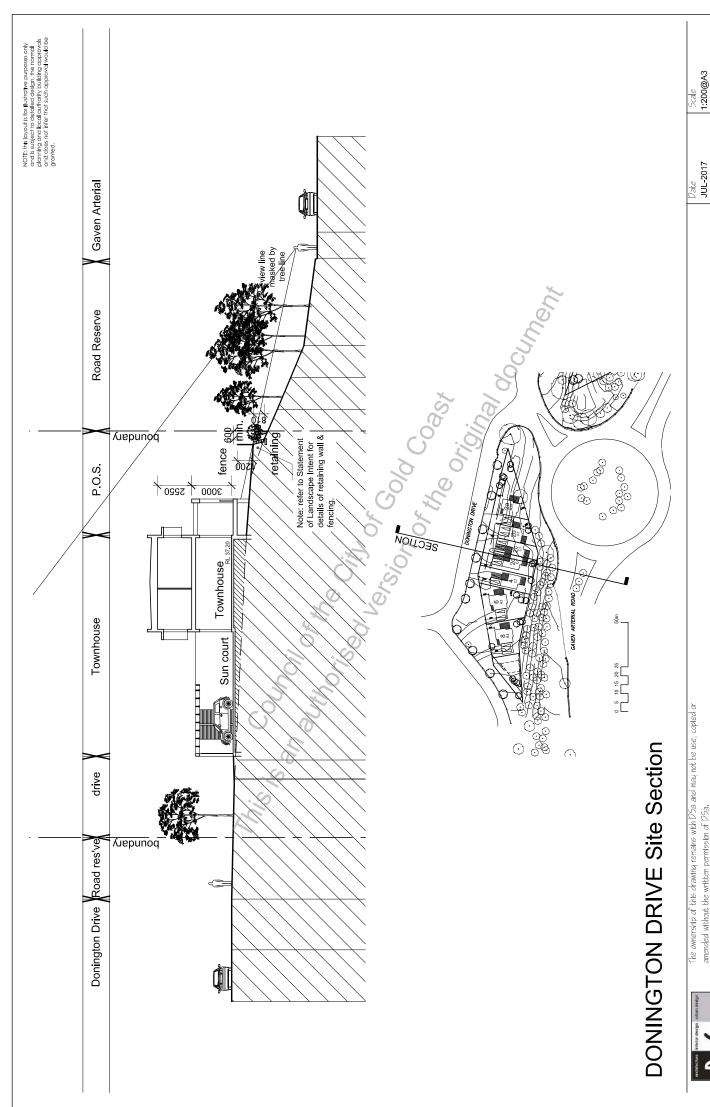Mortons Urban Solutions 206.2 DA-1-12



amended without the written permission of DSa,

HATIA PROPERTY CORPORATION

PROPOSED RESIDENTIAL DEVELOPMENT - LOT 3 on SP275769 - DONINGTON DRIVE, MAUDSLAND

206.2 DA-1-13

Mortons Urban Solutions



DONINGTON DRIVE Open Space



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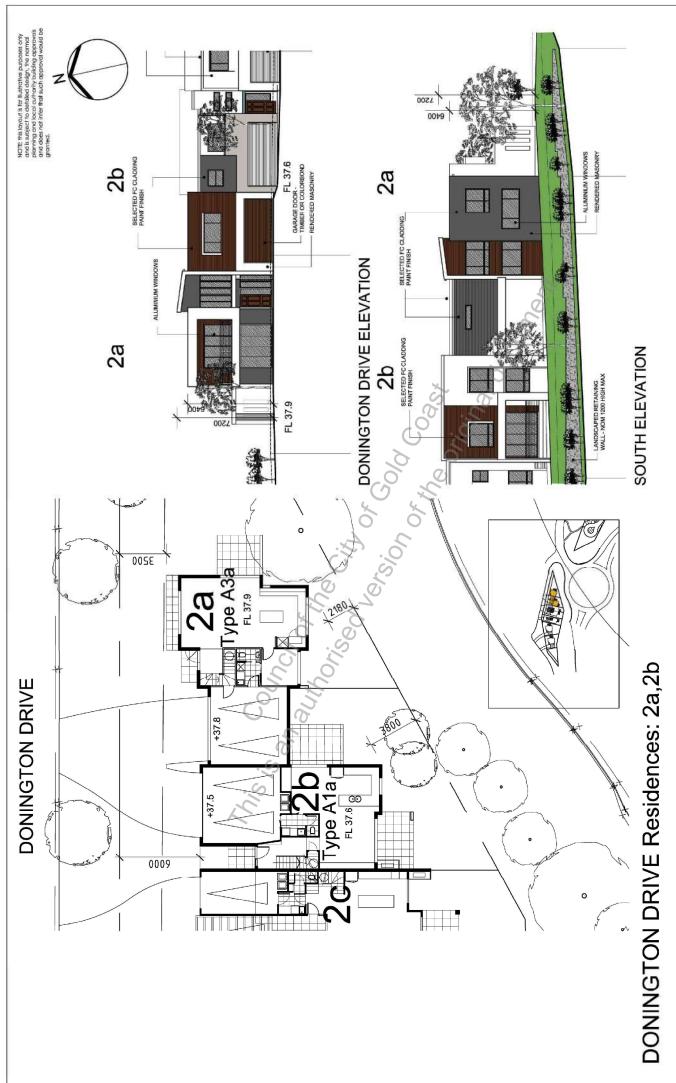
HATIA PROPERTY CORPORATION

PROPOSED RESIDENTIAL DEVELOPMENT - LOT 3 on SP275769 - DONINGTON DRIVE, MAUDSLAND

206.2 DA-1-16

Mortons Urban Solutions

Date JUL-2017 16 A



The ownership of this crawing remains with DSa and may not be use, copied or

HATIA PROPERTY CORPORATION

PROPOSED RESIDENTIAL DEVELOPMENT - LOT 3 on SP275769 - DONINGTON DRIVE, MAUDSLAND

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Mortons Urban Solutions

Date JUL-2017

ANNEXURE I OPERATIONAL WORKS APPROVALS

SOURCE: GOLD COAST CITY COUNCIL



Form 17 – Permit for plumbing, drainage and onsite sewerage work Please use BLOCK LETTERS and complete all details in full.

GENERAL NOTES: This form is to be used for the purpose of sections 48(a) and 54(a) of the Plumbing and Drainage Regulation 2019 (PDR).				
1. Description of land The description must identify all land the subject of the application. The lot and plan details (e.g. SP/RP) are shown on title documents or a rates notice.	Street address (include number, street, suburb/local Lot 3 Gaven Arterial Road, Maudsland Qld 4210 Lot and plan: Lot 3 SP275769 Shop/tenancy number Storey/level (if applicable) (if applicable)			
2. Owner details	Owner's name Tellurium Gg Pty Ltd Postal address: UNIT 6 / 10 Thomas St, NOOSAVILLE QLD 456 Email address christophert@urbansolutions.net.au	Phone number: 6		
3. Applicant details The applicant need not be the owner of the land.	Company name in full: Tellurium Gg Pty Ltd Phone number Email address of applicant: christophert@urbansolutions.net.au Note: If lodging this application, the applicant is responsib	Contact person: Mobile: Meter ensuring the information provided is		
4. Certification	correct and that they are authorised to manage the application on the owner's behalf. This form certifies that the relevant local government or public-sector entity has made the following decision in relation to the application for a permit as described above. Tick the relevant boxes: Application refused Permit approved — with conditions Permit approved — to amend an existing permit Permit approved — to extend the term of an existing permit Permit number Date of issue Date of expiry Issued by (insert local government name/public sector entity) City of Gold Coast			
5. Attachments Local government or public sector entity may attach additional documentation to this form.	Conditions of permit Approved plans and specifications Details of any alternative/performance solution Information notice Provide further comments (if applicable):			

Date: 10 October 2019
Contact: Aaron Johnson
Location: City Development
Telephone: 07 5667 5977
Our reference: PCS/2019/2926



Tellurium Gg Pty Ltd C/- Mortons - Urban Solutions PO BOX 2484 SOUTHPORT QLD 4215

Dear Sir/Madam

Information Notice - Permit on Conditions

(given under section 46(a) of the Plumbing and Drainage Regulation 2019)

Description of work: 02 building with separate dwelling units

Permit number: PCS/2019/2926
Property description Lot 3 SP275769

Property location Lot 3 Gaven Arterial Road, Maudsland Qld 4210

Your request for the compliance assessment of a plan for permit work (that is plumbing and drainage work) under section 42 of the *Plumbing and Drainage Regulation 2019* was decided on 10 October 2019 by City of Gold Coast (City) resulting in the issue of a permit subject to the following conditions:

Conditions

 The plumbing and drainage must be carried out in accordance with the stamped approved plans/drawings listed below, which have been returned to the applicant with this permit. Until Council has completed a final inspection of the plumbing and drainage work, a copy of this permit and full size colour copy of the original Council stamped approved hydraulic plumbing and drainage plans must remain on site.

Plan No.	Rev.	Title	Date	Hydraulic Consultant
36901	Е	000	06/08/19	Morton urban solutions
36901	С	080	06/08/19	Morton urban solutions
36901	С	090	06/08/19	Morton urban solutions
36901	D	500	06/08/19	Morton urban solutions
36901	D	530	06/08/19	Morton urban solutions
36901	Е	700	06/08/19	Morton urban solutions
36901	С	701	06/08/19	Morton urban solutions
36901	В	710	06/08/19	Morton urban solutions

Advice notes

All development permits and/or approvals to ensure compliance with any relevant laws must be obtained prior to the commencement of work. For example, this permit does not authorise the following work:

- Connections to sewerage and water infrastructure.
- The design, certification and performance of any fire system associated with the property.
- Permit to discharge trade waste.

This permit ends two (2) years from the date of this letter. However, an eligible person may apply to extend the term of the permit, under section 43(2)(a).

The inspection of all plumbing and drainage work is required during construction prior to certain milestones. A plumbing and drainage pre-start inspection is required prior to the commencement of work.

Under the Landslide Hazard Overlay Code of the City Plan any proposed on-site effluent disposal within any area identified on the Landslide hazard overlay map, must comply with the Self-assessable acceptable outcome SO1 of the Landslide Hazard Overlay Code.

A copy of this compliance permit has been provided to the owner of the premises to which the permit relates.

Should you wish to clarify any issues contained in the above letter, please do not hesitate to contact Aaron Johnson on 07 5667 5977.

Yours faithfully

Aaron Johnson

Plumbing and Drainage Inspector For the Chief Executive Officer Council of the City of Gold Coast

INFORMATION NOTICE

(Given under section 50 (1)(a) of the Plumbing and Drainage Regulation 2019)

The decision

On 10-Oct-2019, a compliance permit was issued, subject to conditions.

Reasons for the decision

The reasons for issuing this compliance permit subject to conditions are:

In accordance with the Plumbing and Drainage Act, the Council may ask the person who made the request to assess the compliance assessable work to supply a plan of the assessed work. The council requires a copy of the permit and full size colour copy of the original stamped approved hydraulic plumbing and drainage plans on site to ensure the work on site, corresponds with the approved plans approved under the permit. The work which has been identified on the plan is then marked off at time of inspection. At time of final inspection the marked up plan is compared to the as constructed plan.

Rights of appeal

The person to whom the notice is given may appeal against the decision to a development tribunal under the *Planning Act 2016* (Qld) within 20 business days.

An appeal is started by lodging a notice of appeal with the registrar of a development tribunal. The notice of appeal must be in the approved form, succinctly state the grounds of the appeal and be accompanied by the required fee.

Chapter 6, Part 1 and Schedule 1 of the *Planning Act 2016* sets out further information about appeal rights.

PLUMBERS COPY TO REMAIN ONSITE

PLUMBING & DRAINAGE ADVISORY NOTE

This approval is granted only for the Plumbing and Drainage hydraulic design pursuant to the Plumbing and Drainage Act 2018. This approval is not to be taken as approval by Council or any other development and does not alleviate the need to comply with all development requirements of Council's Planning Scheme and any relevant Local Laws and Policies.

PLUMBING & DRAINAGE ADVISORY NOTE

The Private Certifier is to assess matters relating to Council's Planning Scheme Policies, Local Laws and Building Certification functions to ensure compliance with the above.

Council of the City of Gold Coast Plumbing & Drainage Services

- Council approved hydraulic plans to be kept on
- As constructed plans are required prior to final increasion.
- inspection
 3. Approval subject to Council's conditions of
- approval subject to council's conditions of approval requirements.The Plumbing & Drainage design is provisional
- only and may be amended by the site inspectors approved

PCS/2019/2926

9 October 2019

DONINGTON DRIVE RESIDENTIAL

PLUMBING & DRAINAGE OVERALL No. 36901-P&D

	S	SCHEDULE	OF	DRAWINGS	
NUMBER	REV. NO.	TITLE			
GENERAL	<u>'</u>				
36901-P&D-000	E	COVER SHEET			
EARTHWORKS: FINAL	SURFACE & SEC	DIMENT AND EROSION CONTRO	L		
36901-P&D-080	С	PLAN SHEET 01			
EARTHWORKS: COMB	INED SERVICES				
36901-P&D-090	С	PLAN SHEET 01			
SEWER: SEWER RET	CULATION				
36901-P&D-500	D	PLAN SHEET 01			
SEWER: PROFILES					
36901-P&D-530	D	PROFILES SHEET 01			
DRAINAGE: STORMW.	ATER				
36901-P&D-600	D	PLAN SHEET 01			
DRAINAGE: PROFILES	, ,				
36901-P&D-620	D	PROFILES SHEET 01			
DRAINAGE: STRUCTU					
36901-P&D-640	С	DETAILS SHEET 01			
DRAINAGE: CATCHME					
36901-P&D-670	С	PLAN SHEET 01			
DRAINAGE: CALCULA					
36901-P&D-680	В	MINOR & MAJOR SHEET 01			
WATER: WATER RET					
36901-P&D-700	E	PLAN SHEET 01			
36901-P&D-701	С	DETAIL SHEET 01			
36901-P&D-710	В	DETAIL SHEET 02			

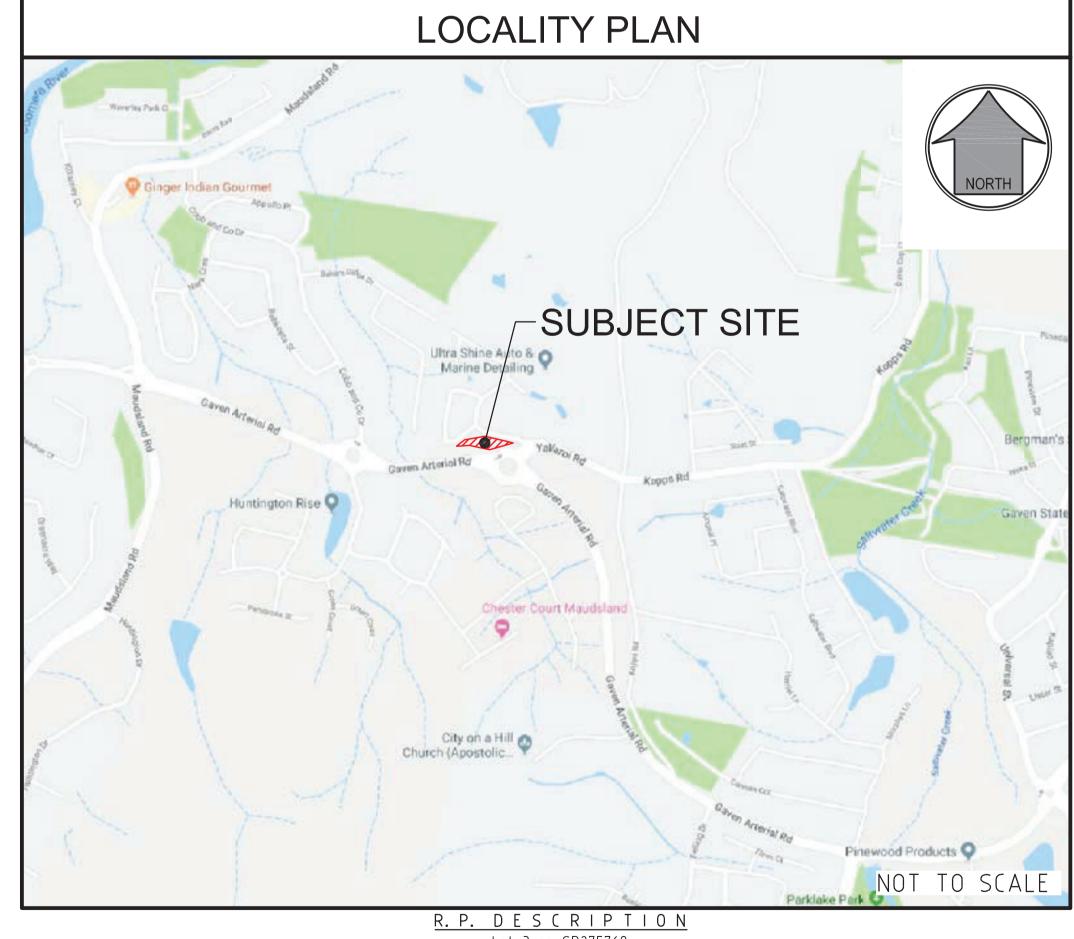




TELLURIUM GG
Pty Ltd

SUB-CONSULTANTS





Lot 3 on SP275769

DONINGTON DRIVE

LOCALITY OF OXENFORD

LOCAL AUTHORITY - CITY OF GOLD COAST

a. ENVIRONMENTAL PROTECTION ACT WITH SPECIFIC REFERENCE TO PARTS S440G & S319 b. STATE PLANNING POLICY

PRESCRIBED WATER CONTAMINANTS (AS DEFINED IN THE ENVIRONMENTAL PROTECTION ACT 1994) MUST NOT BE RELEASED FROM THE SITE OR TO WATERS WITHIN THE SITE, OR BE LIKELY TO BE RELEASED SHOULD RAINFALL OCCUR, UNLESS ALL REASONABLE & PRACTICABLE MEASURES ARE TAKEN TO PREVENT OR MINIMISE THE RELEASE & CONCENTRATION OF CONTAMINATION. THE ESC PLAN MUST BE DESIGNED. IMPLEMENTED & MAINTAINED IN ACCORDANCE WITH "BEST PRACTICE EROSION & SEDIMENT CONTROL" PUBLISHED BY THE INTERNATIONAL EROSION CONTROL ASSOCIATION (AUSTRALASIAN CHAPTER) (IECA 2008).

2. TO COMPLY WITH THE REQUIREMENTS OF THE EP ACT & BEST PRACTICE DESIGN, THE SEDIMENT BASINS ON THE SITE MUST BE DESIGNED & IMPLEMENTED TO ACHIEVE THE FOLLOWING: SEDIMENT BASINS ARE TO BE DESIGNED. IMPLEMENTED & MAINTAINED TO A STANDARD WHICH WOULD ACHIEVE AT LEAST 80% OF THE AVERAGE ANNUAL RUNOFF VOLUME OF THE CONTRIBUTING CATCHMENT TREATED (I.E. 80% HYDROLOGIC EFFECTIVENESS) TO 50MG/L TSS OR LESS & PH IN THE RANGE 6.5-8.5

THIS WILL REQUIRE THE INSTALLATION & OPERATION OF A HIGH-EFFICIENCY SEDIMENT BASIN(S) DESIGNED IN ACCORDANCE WITH THE SPECIFICATIONS CONTAINED IN THE "BEST PRACTICE EROSION & SEDIMENT CONTROL - APPENDIX B SEDIMENT BASIN DESIGN & OPERATION" PUBLISHED BY THE INTERNATIONAL EROSION CONTROL ASSOCIATION (AUSTRALASIAN CHAPTER) (IECA, 2016, DRAFT)

- 3. THE EROSION & SEDIMENT CONTROL PLAN MUST BE PREPARED & CERTIFIED BY A CERTIFIED PROFESSIONAL IN EROSION & SEDIMENT CONTROL & FOLLOW THE REQUIREMENTS OUTLINED IN IECA'S BEST PRACTICE EROSION & SEDIMENT CONTROL DOCUMENT & THE QUEENSLAND URBAN
- 4. PRIOR TO THE COMMENCEMENT OF WORKS ONSITE THE CONTRACTOR MUST MAKE THEMSELVES AWARE OF ALL PREVIOUS GEOTECHNICAL REPORTS & DETERMINE THE DISPERSIVE CHARACTERISTICS OF THE SOIL (INCLUDING PERFORMING ANY SOIL TESTS IF REQUIRED). THE RESULTS OF THIS REVIEW & ANY TESTS MUST BE INCLUDED IN THE CONTRACTOR'S EROSION & SEDIMENT CONTROL PLAN. A COPY OF ALL TEST RESULTS MUST BE PROVIDED TO THE SUPERINTENDENT.
- 5. THE CONTRACTOR SHALL TAKE ALL NECESSARY PRECAUTIONS TO CONTROL EROSION & DOWNSTREAM SEDIMENTATION DURING ALL STAGES OF CONSTRUCTION (INCLUDING THE MAINTENANCE PERIOD). NOTWITHSTANDING THE CONTROL MEASURES OR FINISHED EARTHWORKS DESIGN SHOWN ON THESE DRAWINGS, THE CONTRACTOR IS RESPONSIBLE FOR IMPLEMENTING ADDITIONAL OR ALTERNATIVE EROSION & SEDIMENT CONTROL MEASURES TO MINIMISE SEDIMENT ACROSS OR LEAVING THE SITE.
- 6. AT ALL TIMES THE CONTRACTOR SHALL MONITOR THE PREVAILING WEATHER CONDITIONS (INCLUDING WEEKENDS & PUBLIC HOLIDAYS) & AT ALL TIMES REMAINS RESPONSIBLE TO:
 - a) CLEAN & REPAIR CONTROL DEVICES WHENEVER THE ACCUMULATED SEDIMENT REDUCES THEIR CAPACITY BY 50%.
- b) MAINTAIN POSITIVE GRADES OF ALL PERIMETER BANKS & SWALES TO AN OUTLET. c) PROTECT ANY DOWNSTREAM CONSTRUCTION.
- d) CONTROLLING DUST.
- e) MEASURES HAVE BEEN INSTALLED IN ACCORDANCE WITH DETAILS OUTLINED IN THEIR EROSION & SEDIMENT CONTROL PLAN & AS DIRECTED BY THE SUPERINTENDENT.
- 7. THE CONTRACTOR'S PLAN SHALL ALLOW FOR SUITABLE ACCESS TO ALLOW MAINTENANCE OF ALL SEDIMENT CONTROL DEVICES. NO ADDITIONAL VEGETATION CLEARING IS PERMITTED FOR GAINING ACCESS UNLESS APPROVED BY THE SUPERINTENDENT.
- 8. THE CONTRACTOR MAY REQUEST APPROVAL FROM THE SUPERINTENDENT TO REUSE THE STOCKPILED MULCH FOR STABILISING BATTERS ONLY IN LOCATIONS WHERE THE APPROVED LANDSCAPE OPW DESIGN REQUIRES MULCH ULTIMATELY.
- 9. CONSTRUCTION STOCKPILING
 - a) TOPSOIL SHALL BE STRIPPED & STOCKPILED IN LOCATIONS NOMINATED ON THE CONSTRUCTION DRAWINGS OR IN LOCATIONS AGREED WITH THE SUPERINTENDENT
 - b) ADDITIONAL VEGETATION CLEARING IS NOT PERMITTED TO FACILITATE THE STOCKPILING OF
- MATERIALS UNLESS SHOWN ON THE APPROVED VEGETATION MANAGEMENT PLAN. c) ANY STOCKPILE SITE MUST BE CLEAR OF ADJACENT PROPERTY BOUNDARIES SO AS NOT TO CAUSE A NUISANCE TO ADJOINING PROPERTIES.
- d) NO STOCKPILES ARE TO BE LOCATED WITHIN THE TREE PROTECTION ZONE OF VEGETATION.
- e) A TEMPORARY SILT FENCE IS TO BE ERECTED APPROXIMATELY 5m FROM TOE OF BATTER ON LOW SIDE OF STOCKPILING.
- 10. NOTWITHSTANDING THE DETAILS SHOWN IN THE CONTRACTOR'S EROSION & SEDIMENT CONTROL PLAN, DURING CONSTRUCTION THE CONTRACTOR MUST:
- a) SIZE ALL TEMPORARY SEDIMENT BASINS APPROPRIATELY TO TREAT THE UPSTREAM CATCHMENT. NOTE THAT THE PERMANENT BIO BASINS SHOWN ON THESE DRAWINGS ARE SIZED FOR THE ULTIMATE CATCHMENT NOT FOR THE CONSTRUCTION PHASE.
- b) PLACE A ROCK BUND AROUND ALL HEADWALLS DURING CONSTRUCTION.
- c) PROVIDE KERB INLET PROTECTION TO ALL GULLIES. c) PLACE A MINIMUM 1.0m WIDE TURF STRIP BEHIND ALL KERBS & IN A HERRINGBONE LAYOUT
- WITHIN THE ROAD VERGE. d) MAINTENANCE (INCLUDING FLOCCULATION IF REQUIRED & PUMP OUT) OF ALL CONSTRUCTION SEDIMENT BASINS (WHETHER EXISTING OR NEW).
- e) CLEAN OUT OF ALL GROSS POLLUTANT TRAPS, SEDIMENT FOREBAYS & ALL OTHER
- PERMANENT SEDIMENT CONTROL DEVICES AT BOTH ON & OFF MAINTENANCE.
- 11. CONTRACTOR TO CONFIRM THE EXTENTS OF REQUIRED GRASSING TREATMENTS WITH THE SUPERINTENDENT AT LEAST 7 DAYS PRIOR TO FINAL TRIMMING.
- 12. THE CONTRACTOR IS RESPONSIBLE FOR ENSURING THAT GRASSING STRIKE RATES ARE ACHIEVED AT THE ON & OFF MAINTENANCE INSPECTIONS IN ACCORDANCE WITH COUNCIL REQUIREMENTS. THIS INCLUDES THE SUPPLY & INSTALLATION OF ANY REQUIRED CHEMICAL/FERTILISER AMELIORATION TO ACHIEVE THE SPECIFIED GRASS STRIKE RATES.
- 13. GEOFABRIC LINING OF CHANNELS & CHECK DAMS MAY BE REQUIRED SUBJECT TO THE SITE CONDITIONS.
- 14. BATTERS WITHIN PUBLIC OPEN SPACE TO BE VEGETATED IN ACCORDANCE WITH APPROVED OPEN SPACE MANAGEMENT PLAN & LANDSCAPING OPW. CONTRACT DOCUMENTATION WILL SPECIFY WHETHER THIS IS THE CIVIL CONTRACTOR OR THE LANDSCAPE CONTRACTOR'S RESPONSIBILITY TO SUPPLY & INSTALL. THE CIVIL CONTRACTOR IS RESPONSIBLE FOR PROVIDING SUITABLE ACCESS FOR THE LANDSCAPE CONTRACTOR TO PERFORM THEIR WORKS.
- 15. MAINTENANCE PERIOD (PRE TO POST CONSTRUCTION)
- a) ALL PROTECTION MEASURES ARE TO BE INSPECTED & MAINTAINED REGULARLY
- b) REPAIRS ARE TO BE EFFECTED IMMEDIATELY.
- c) SILT AFTER RAIN IS TO BE CLEANED FROM STREETS & ALLOTMENTS IMMEDIATELY & CORRECTIVE ACTION TAKEN TO AVOID A RE-OCCURRENCE.
- d) AT OFF-MAINTENANCE & ONLY WHEN DIRECTED BY COUNCIL, REMOVE & DISPOSE OFFSITE ALL TEMPORARY EROSION & SEDIMENT CONTROL DEVICES.

NOTE:

SEDIMENT AND EROSION CONTROL MEASURES SHOWN RELATE TO THE FINISHED SURFACE ONLY AND ARE CONCEPTUAL ONLY. THE CONTRACTOR IS TO PREPARE A SITE SPECIFIC CONSTRUCTION AND MAINTENANCE PHASE SEDIMENT AND EROSION CONTROL PLAN.

PLUMBERS COPY TO REMAIN ONSITE

This approval is granted only for the Plumbin the Plumbing and Drainage Act 2018. of Council's Planning

Scheme and any relevant Local Laws and

The Private Certifier is to assess matters relating to Council's Planning Scheme Policies, Local Laws and Building Certification functions to ensure compliance with the above.

Council of the City of Gold Coast Plumbing & Drainage Services

- Council approved hydraulic plans to be kept on
- 2. As constructed plans are required prior to final
- Approval subject to Council's conditions of
- approval requirements.
 The Plumbing & Drainage design is provisional only and may be amended by the site inspectors

AD

9 October 2019

PCS/2019/2926

DONINGTON DRIVE

AB

LEGEND

— **SW**— — — EXISTING STORMWATER

- 1.0 — EXISTING CONTOURS

SITE BOUNDARY

-SW------ PROPOSED STORMWATER

— 1.0 — DESIGN CONTOURS

- EXISTING PROPERTY LINE

- EXISTING KERB (INVERT)

PROPOSED PROPERTY LINE

MANHOLE KERB INLET (ON GRADE) PIT KERB INLET (SAG) PIT T HEADWALL

SCOUR PROTECTION

TEMPORARY SEDIMENT BASIN STORMWATER INLET FILTER VEHICLE SHAKEDOWN
(AT ALL SITE ENTRANCES MIN.)

PROVIDE SEDIMENT AND EROSION CONTROL MEASURES IN ACCORDANCE WITH THE INTERNATIONAL EROSION CONTROL ASSOCIATION BPESC DOCUMENT.

SHEET LAYOUT

36901-P&D-080 (ABOVE)

PROVIDE VEHICLE SHAKEDOWN AT

BPESC DOCUMENT.

ALL SITE ENTRANCES. REFER IECA'S

SP188406

36901-P&D-080 (BELOW)

DIAL BEFORE YOU DIG

DONINGTON DRIVE RESIDENTIAL

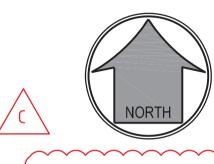
PROJECT NAME

PLUMBING & DRAINAGE

RP DESCRIPTION Lot 3 on SP275769 DONINGTON DRIVE LOCALITY OF OXENFORD LOCAL AUTHORITY - CITY OF GOLD COAST

CLIENT

TELLURIUM GG Pty Ltd



0 2.5 5 7.5 10 12.5m Scale 1:250 - A1 (1.500 - A3)

DATE **TENDER** OUNCIL 26-08-19 CONSTRUCTION 08-10-19 SCALE BAR AMENDED TO SHOW ORIGINAL A1 & A3 SCAL 13-09-19 SCALE BAR AMENDED TO SHOW ONLY A3 SCALE 26-08-19 COUNCIL ISSUE AMENDMENT

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COPYRIGHT IS VESTED IN MORTONS URBAN SOLUTIONS AND



DRAWING TITLE

FINAL SURFACE AND SEDIMENT AND EROSION PLAN SHEET 01



Civil Engineering **Project Coordination** Postal Address MUS Ptv Ltd T/As:

Mortons-Urban Solutions ABN: 39 116 375 065 mortons@urbansolutions.net.au www.urbansolutions.net.au

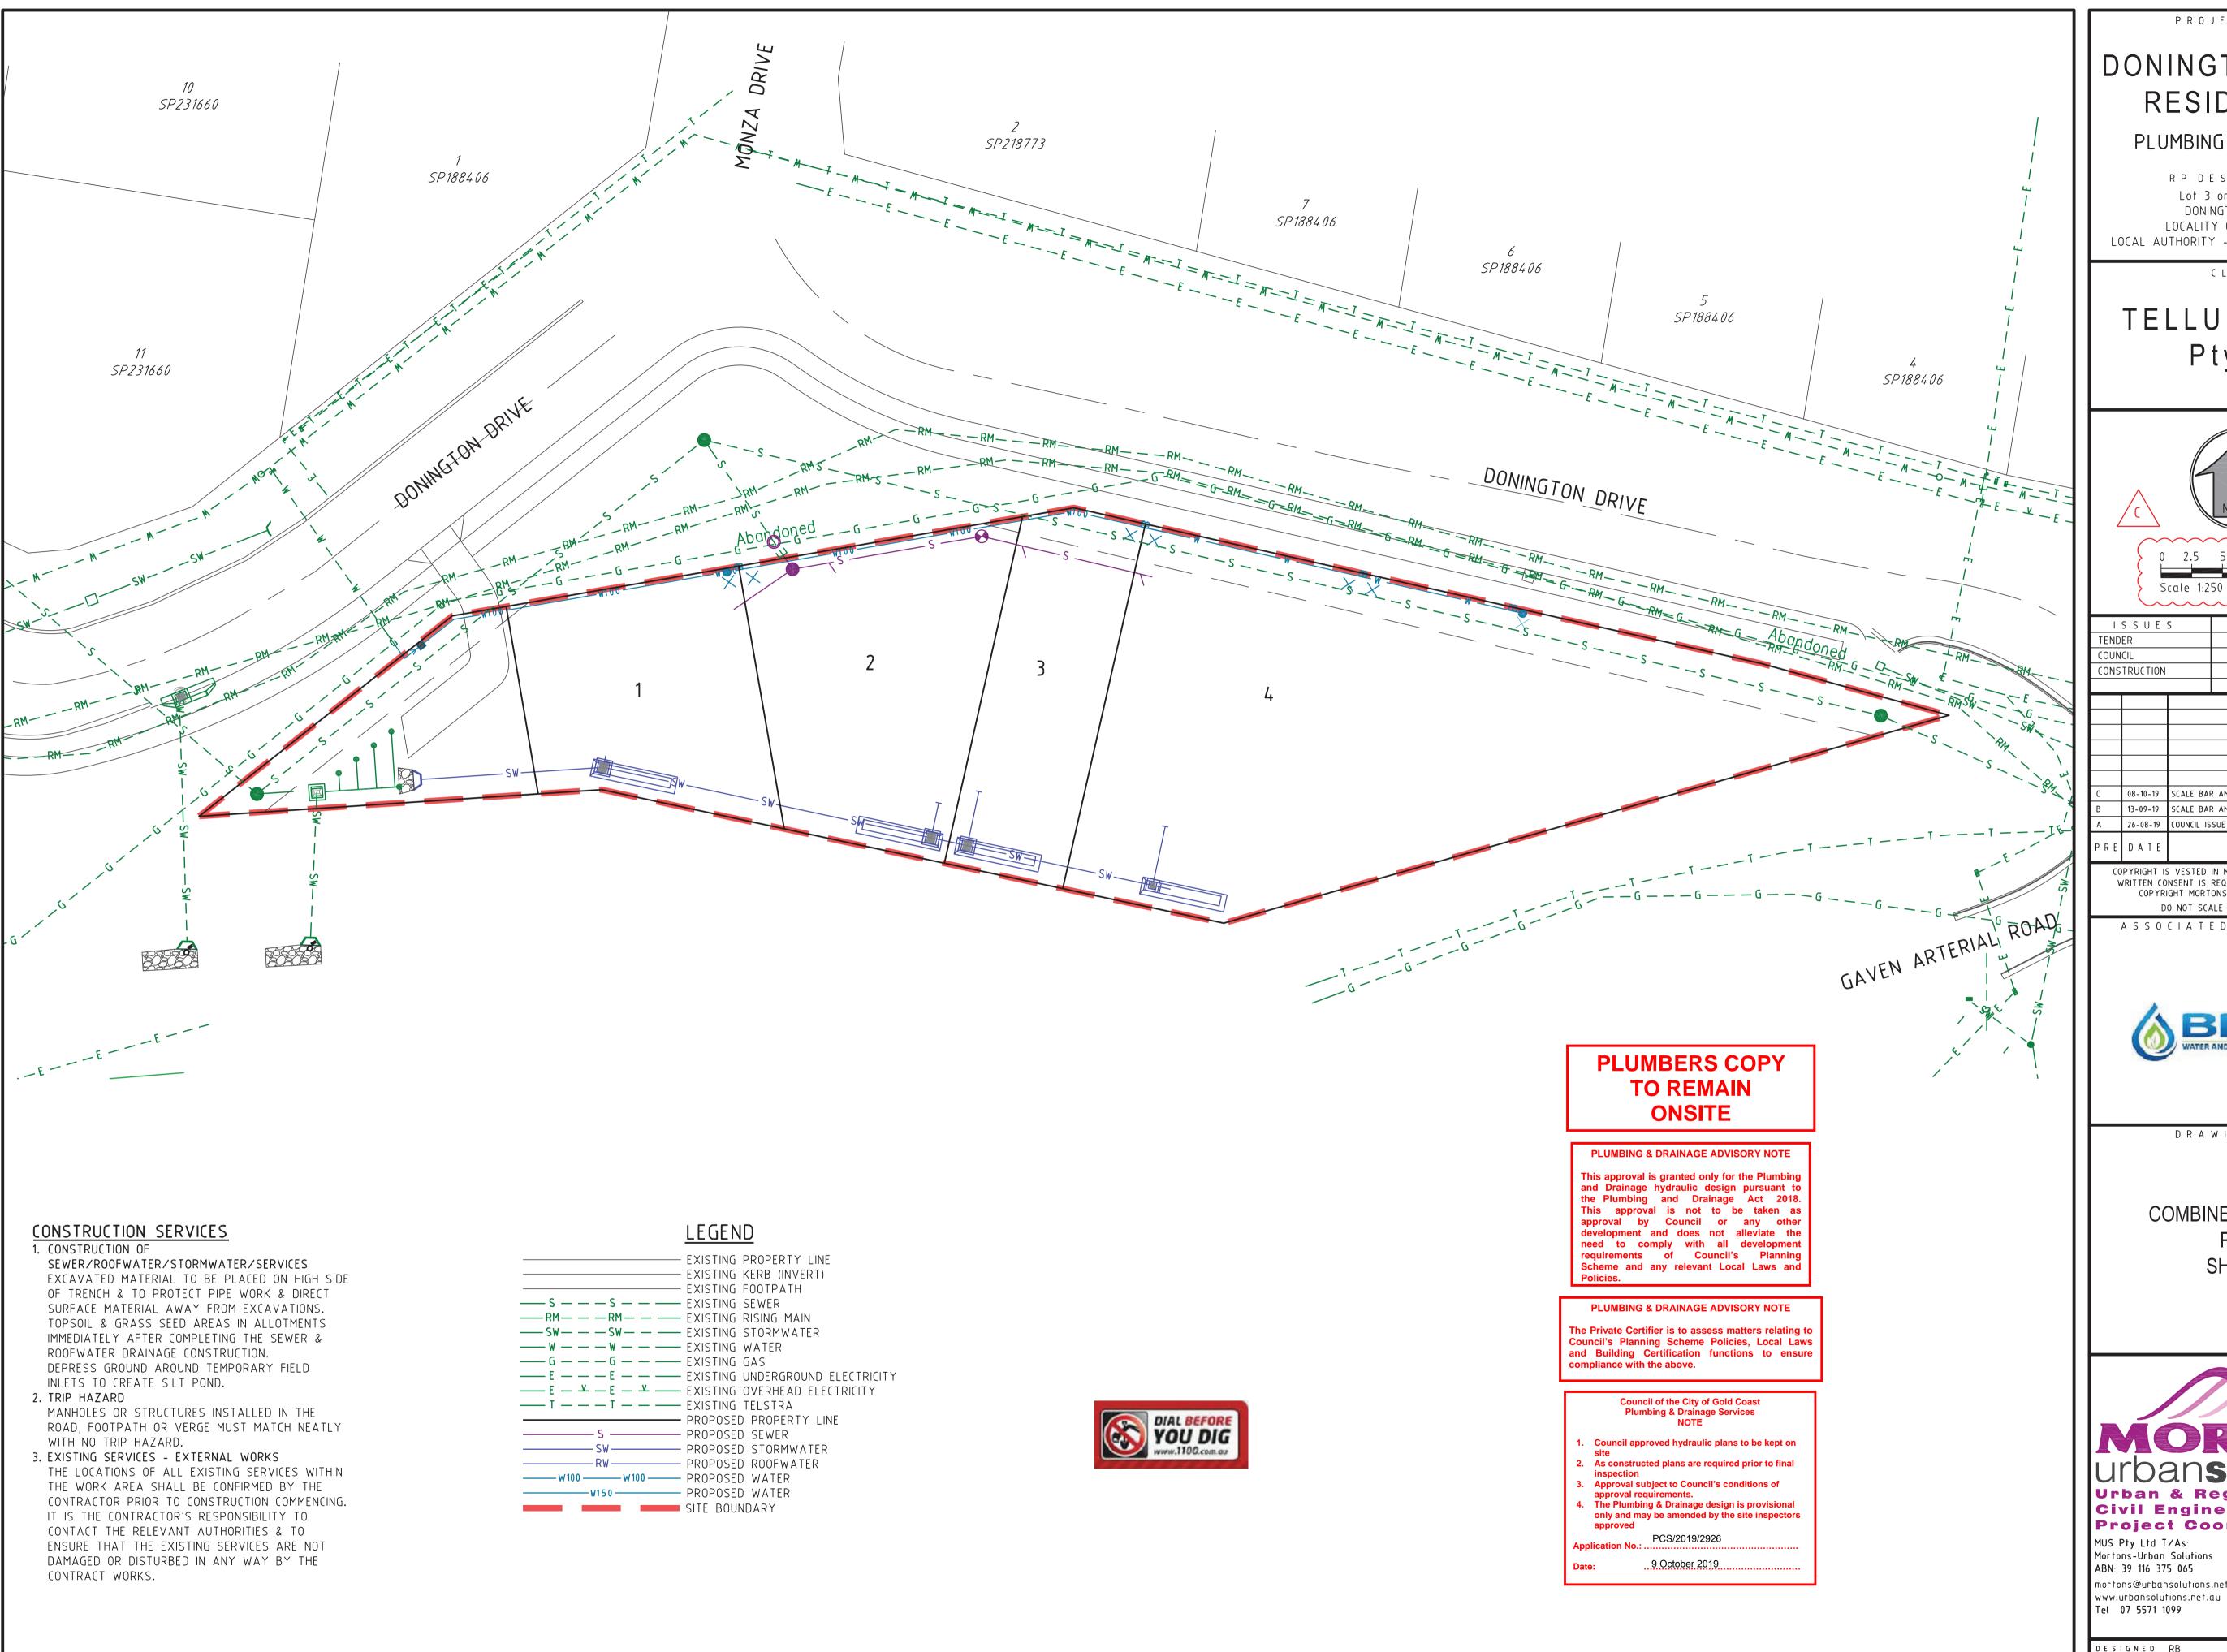
PO Box 2484 Southport QLD 4219 Gold Coast Office

Suite 9, 19 Short S Tel 07 5571 1099 Southport QLD 4215 DRAWN DESIGNED RB

APPROVED M.K. mortes RPEQ **4706** DATE 06-08-19 DRAWING NUMBER

36901-P&D-080

AMEND.




DONINGTON DRIVE RESIDENTIAL

PLUMBING & DRAINAGE

RP DESCRIPTION Lot 3 on SP275769 DONINGTON DRIVE LOCALITY OF OXENFORD LOCAL AUTHORITY - CITY OF GOLD COAST

CLIENT

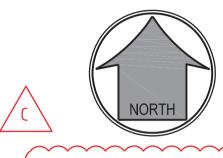TELLURIUM GG Pty Ltd



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C	08-10-19	SCALE BAR	AMENDED	TO	SHOW	ORIGIN	IAL	Α1	& A3	SCAL
В	13-09-19	SCALE BAR	AMENDED	TO	SHOW	ONLY	Α3	SC	ALE	
Α	26-08-19	COUNCIL ISS	UE							
PRE	DATE		A I	M E	N D M	I E N	T			

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DRAWING TITLE

COMBINED SERVICES PLAN SHEET 01



Project Coordination Postal Address

MUS Pty Ltd T/As: Mortons-Urban Solutions ABN: 39 116 375 065 mortons@urbansolutions.net.au

PO Box 2484 Southport QLD 4215

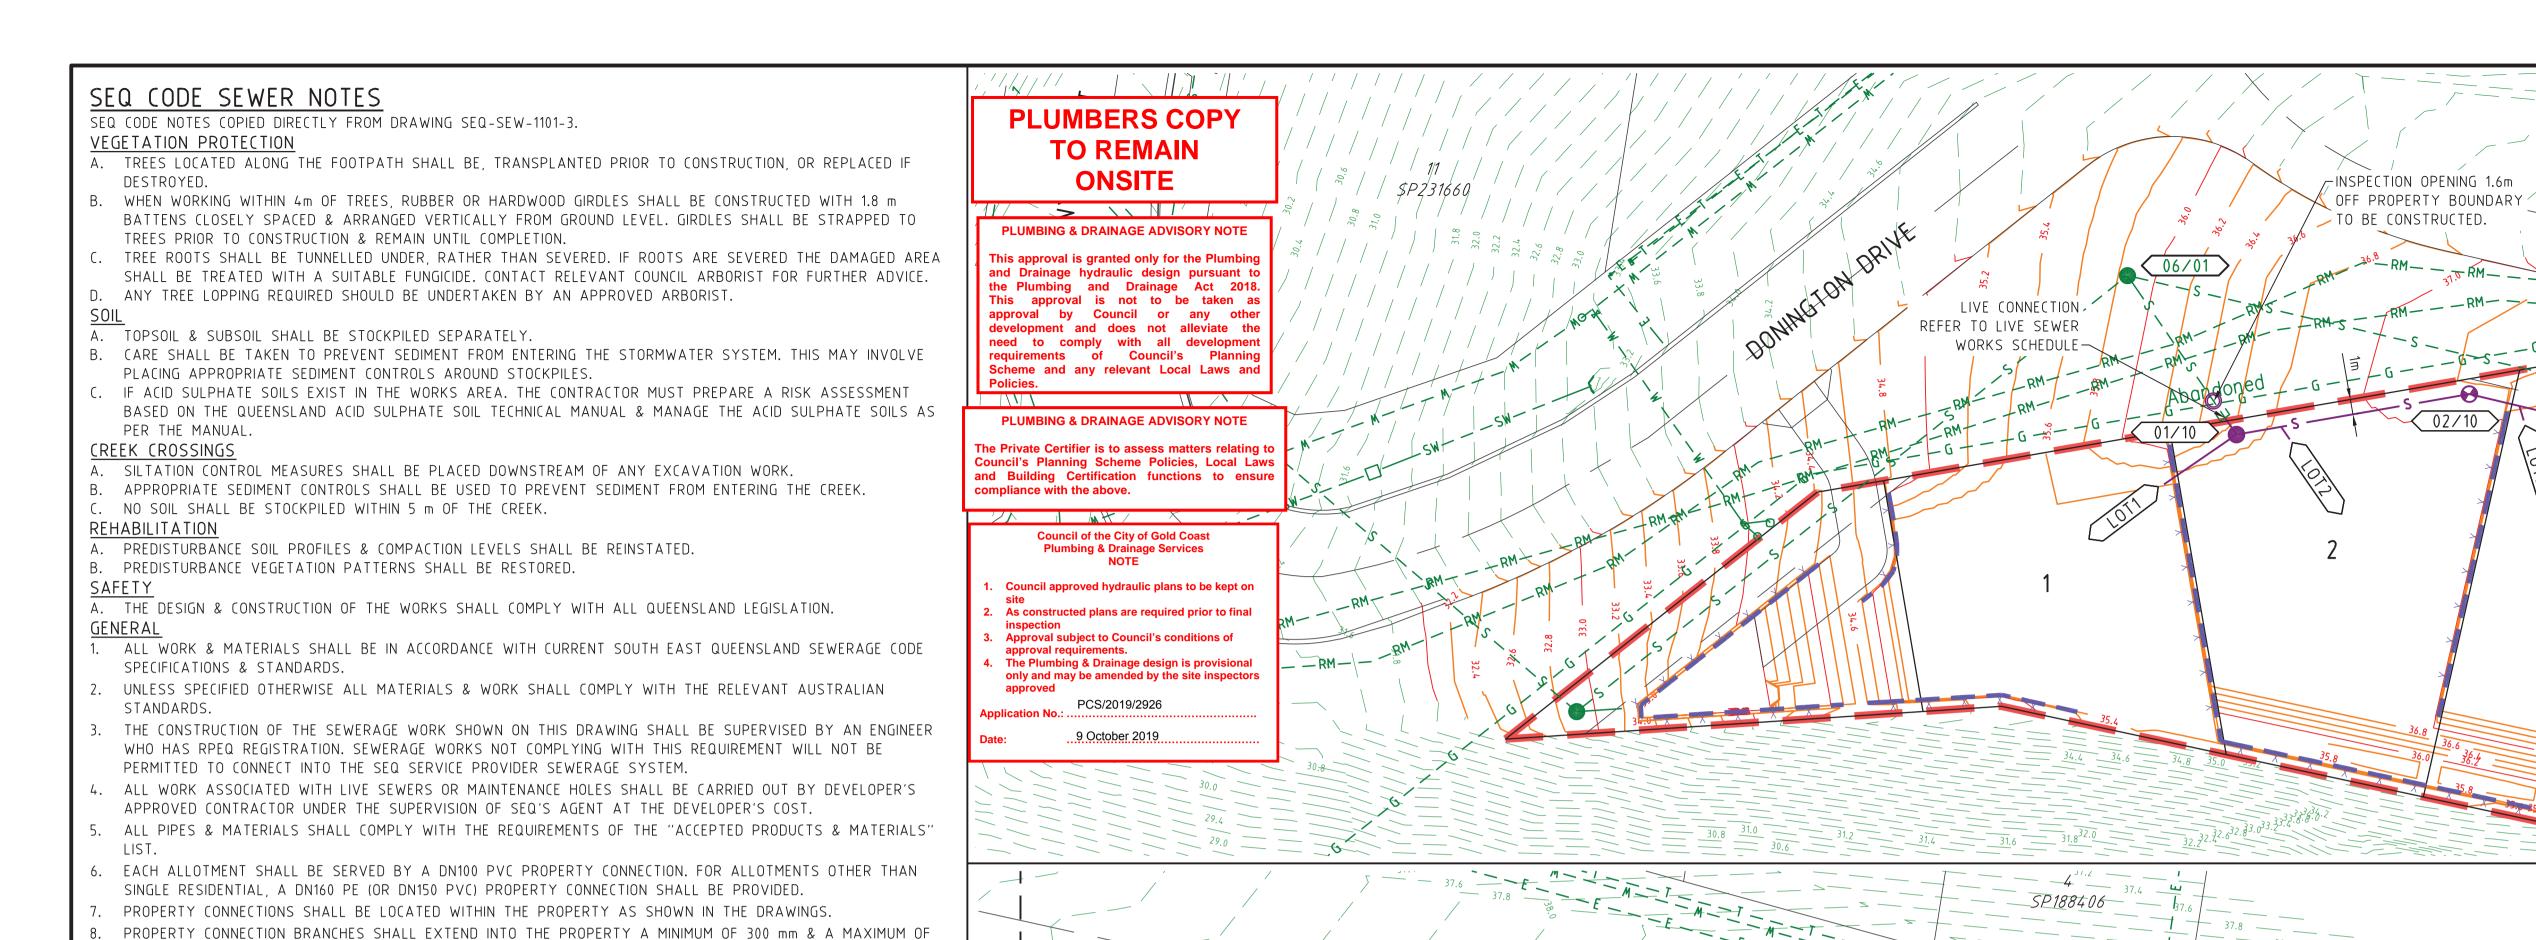
AMEND.

Gold Coast Office Suite 9, 19 Short S Southport QLD 4215

DESIGNED RB DRAWN EP APPROVEDALK Morto RPEQ 4706 DATE 06-08-19

DRAWING NUMBER

36901-P&D-090



03/10

750 mm. UNITYWATER REQUIRES MINIMUM EXTENSION OF 500 mm INTO PROPERTY 9. WHERE PIPES ARE LAID IN FILL, THE FILLING SHALL BE CARRIED OUT IN LAYERS NOT EXCEEDING 300 mm (LOOSE) IN DEPTH & SHALL BE COMPACTED UNTIL THE COMPACTION IS NOT LESS THAN 95% OF THE MATERIALS MAXIMUM COMPACTION WHEN TESTED IN ACCORDANCE WITH A.S. 1289 (MODIFIED COMPACTION). TESTING SHALL BE CARRIED OUT AFTER EACH ALTERNATE LAYER. IN ALL SUCH CASES APPROVAL OF CONSTRUCTED SEWERS WILL NOT BE ISSUED BY THE SEQ SERVICE PROVIDER UNLESS CERTIFICATES ARE PRODUCED CERTIFYING THAT THE REQUIRED COMPACTION HAS BEEN ACHIEVED. 10. WHERE SEWERS HAVE A GRADE OF 1 IN 20 OR STEEPER BULKHEADS SHALL BE CONSTRUCTED IN ACCORDANCE WITH THE SEQ SEWER CODE. 11. THE CONTRACTOR SHALL VERIFY THE LOCATION & DEPTH OF EXISTING SERVICES WITH RELEVANT AUTHORITIES BEFORE COMMENCING WORKS. 12. SEWERS SHALL BE DISUSED /ABANDONED IN ACCORDANCE WITH PROCEDURES SET OUT IN THE SEQ SEWER CODE.

13. BENCH MARK & LEVELS TO AHD. 14. THE EXISTING DWELLING ON LOT 3. REFER SEQ-SEW-1100, SERVED BY A SEPTIC SYSTEM, SHALL BE CONNECTED TO THE NEW SEWER BY A LICENCED PLUMBER IN ACCORDANCE WITH THE RELEVANT STATUTORY & COUNCIL REQUIREMENTS. THE SEPTIC SYSTEM, INCLUDING TRENCHES, SHALL BE REMOVED AT THE DEVELOPER'S COST. ALL FIXTURES SHALL BE UPGRADED IF REQUIRED BY PLUMBING CODE. STANDARD NOTE NOT APPLICABLE &

THEREFORE DELETED.

15. EXISTING ALLOTMENTS REQUIRING A PROPERTY CONNECTION FROM EXISTING SEWERS SHALL BE PROVIDED BY THE SEQ SERVICE PROVIDER AT THE DEVELOPERS COST.

PROJECT SPECIFIC SEWER NOTES

a. ALL SEWER MAINS TO BE AS PER SEWER PIPE SPECIFICATIONS TABLE.

b. NOTWITHSTANDING THE STANDARD SEQ NOTES ABOVE, ALL MATERIALS & WORKS MUST BE IN ACCORDANCE

WITH THE SERVICE PROVIDER'S APPROVAL CONDITIONS & THE SEQ WS&S D&C CODE.

c. THE CONTRACTOR IS TO INCLUDE ROCK EXCAVATION AS PART OF THEIR SEWER RATES UNLESS SCHEDULED

OTHERWISE WITHIN THE CONTRACT.

d. THE CONTRACTOR TO PROVIDE CALCAREOUS CONCRETE WHERE SPECIFIED IN THE SEQ CODE BY THE RELEVANT AUTHORITY. e. WATER & ELECTRICAL CROSSING LOCATIONS ARE INDICATIVE ONLY. REFER TO PLANS TO DETERMINE PRECISE

CROSSING LOCATIONS. WHERE SERVICE INDICATES CLASH WITH SEWER, SEWER TO TAKE PRECEDENCE, SERVICE TO BE CONSTRUCTED OVER OR UNDER SEWER ACCORDING TO SUPERINTENDENT'S INSTRUCTION

ALL BENDS TO BE LONG RADIUS BEND TO MEET MANUFACTURER'S MINIMUM RADIUS REQUIREMENTS U.N.O. CONTRACTOR TO VERIFY DOWNSTREAM EXISTING PIPE LEVELS PRIOR TO COMMENCEMENT OF WORKS ON-SITE.

PROPERTY CONNECTIONS HAVE BEEN DESIGNED TO CONTROL THE REQUIRED SERVICE AREA OF EACH LOT AT A

GRADE OF 1:60 & A MAXIMUM DEPTH OF PROPERTY CONNECTION AT 1.5m. UNLESS OTHERWISE STATED. i. CONTRACTOR TO PAY ALL FEES & CHARGES ASSOCIATED WITH CONNECTIONS.

SEWER PIPE SPECIFICATIONS LIVE CONNECTIONS BY CONTRACTOR 1. THE CONTRACTOR MAY MAKE THE LIVE SEWER & WATER CONNECTIONS UNDER THE WATER AUTHORITY'S SUPERVISION.

2. IF THE CONTRACTOR WISHES TO MAKE THE CONNECTION THEY MUST INDICATE AT TIME OF TENDER & INSERT A LUMP SUM TO COMPLETE THE WORKS. 3. IF THE CONTRACTOR IS TO MAKE THE LIVE CONNECTIONS ALL REQUIREMENTS OF THE WATER AUTHORITY MUST BE ADHERED TO.

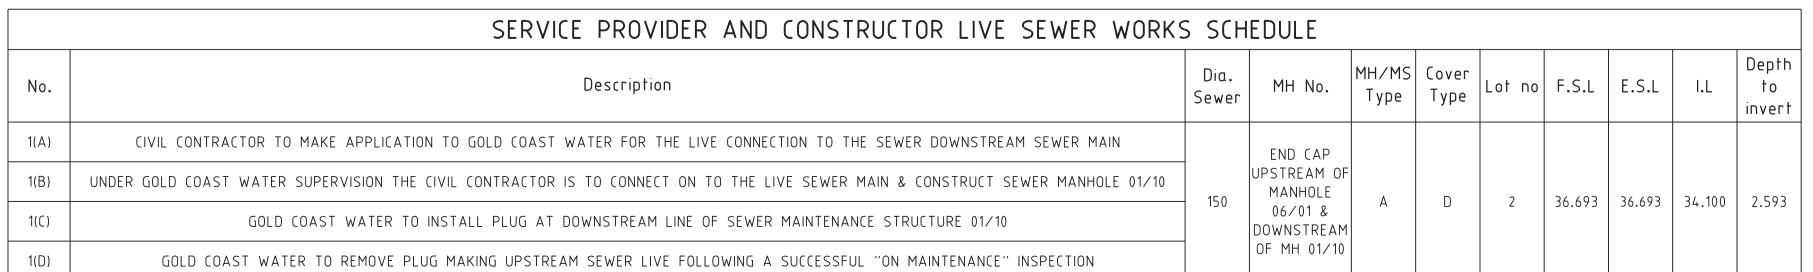
4. THESE REQUIREMENTS ARE NOT LIMITED TO BUT MAY INCLUDE

a. CURRENT FEES PER CONNECTION TO BE PAID BY THE CONTRACTOR. b. CARRY OUT ALL TESTING AS REQUIRED.

c. SUPPLY ALL DETAILS OF CONNECTION. d. SUPPLY ALL HEALTH & SAFETY INFORMATION. SEWER MAIN LOCATION PIPE MATERIAL SPECIFICATION GRAVITY VERGE PVC-U SN8 PVC-U SN8 GRAVITY ROAD CROSSING PVC-U SN6 HOUSE CONNECTIONS

ALL ENVIRONMENT PROTECTION MEASURES SHALL BE IMPLEMENTED PRIOR TO ANY CONSTRUCTION WORK, INCLUDING CLEARING, COMMENCING





PROJECT NAME

DONINGTON DRIVE RESIDENTIAL

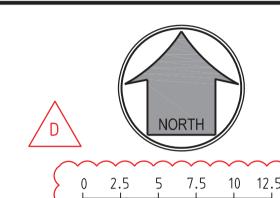
PLUMBING & DRAINAGE

RP DESCRIPTION Lot 3 on SP275769 DONINGTON DRIVE LOCALITY OF OXENFORD LOCAL AUTHORITY - CITY OF GOLD COAST

CLIENT

(02/10

TELLURIUM GG Pty Ltd



(50 - A1 (1.500 - A 3	
ISSUES	DATE	
ENDER		
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TEND	ER	
COUN	CIL	26-08-19
CONS	TRUCTION	
D	08-10-19	SCALE BAR AMENDED TO SHOW ORIGINAL A1 & A3 SCALE
C	02-10-19	SEWER OPENING AND NOTE ADDED
В	13-09-19	SCALE BAR AMENDED TO SHOW ONLY A3 SCALE
Α	26-08-19	COUNCIL ISSUE
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ASSOCIATED CONSULTANTS



DRAWING TITLE

SEWER RETICULATION PLAN SHEET 01



MUS Pty Ltd T/As: Mortons-Urban Solutions ABN: 39 116 375 065

mortons@urbansolutions.net.au www.urbansolutions.net.au Tel 07 5571 1099

PO Box 2484 Southport QLD 4219 Gold Coast Office Suite 9, 19 Short S

Postal Address

Southport QLD 4215 DESIGNED RB RPEQ **4706** DATE 06-08-19 APPROVEDIN.K. mortes

AMEND.

SEWER MAINTENANCE SHAFT 01-10 SEWER PIT NO/LINE

 \longrightarrow S — — — — — EXISTING SEWER

 $-E - \Psi - E - \Psi - EXISTING OVERHEAD ELECTRICITY$ -T - - T - - EXISTING TELSTRA EXISTING RETAINING WALL — — EXISTING CONTOURS

— PROPOSED PROPERTY LINE SITE BOUNDARY — DESIGN CONTOURS SEWER MANHOLE

LEGEND

— EXISTING RISING MAIN

- E - - E - - EXISTING UNDERGROUND ELECTRICITY

-SW— — EXISTING STORMWATER

-W - - W - - EXISTING WATER

-G - -G - -EXISTING GAS

EXISTING KERB (INVERT)

EXISTING PROPERTY LINE

SEWER BEND

(ABOVE)

36901-P&D-500 36901-P&D-500 (BELOW)

SHEET LAYOUT

DRAWING NUMBER 36901-P&D-500 D TRAFFICABLE LID B NON-TRAFFICABLE LID

M M' PREFIX DESIGNATES BOLT DOWN LID

RIGS STRUCTURE TYPES

PRECAST CONCRETE SEWER MAINTENANCE STRUCTURE REFER TO SEQ STD DWG SEQ-SEW-1300-1 TYPE 'A' 1050mm DIA. MAINTENANCE STRUCTURE

REFER TO SEQ STD DWGS SEQ-SEW-1307-1 TYPE 'B' 1200mm DIA. MAINTENANCE STRUCTURE

REFER TO SEQ STD DWGS SEQ-SEW-1307-1 TYPE 'C' 1500mm DIA. MAINTENANCE STRUCTURE REFER TO SEQ STD DWGS SEQ-SEW-1307-1

TYPE 'J1' MAINTENANCE STRUCTURE REFER TO SEQ STD DWGS SEQ-SEW-1314-2

REFER TO SEQ STD DWGS SEQ-SEW-1314-3

RODDING END MAINTENANCE STRUCTURE REFER TO SEQ STD DWGS SEQ-SEW-1314-1

END PROPRIETORY END CAP

SEWER PUMP STATION

REFER TO RELEVANT SEQ STD DWGS RECEIVING MAINTENANCE STRUCTURE RCM | REFER TO RELEVANT SEQ STD SEWER PUMP STATION

TYPE 'G6' TERMINAL MAINTENANCE SHAFT REFER TO SEQ STD DWGS SEQ-SEW-1314-1

RIGS STRUCTURE DROPS

STRAIGHT THROUGH SEWER

REFER TO SEQ STD DWG SEQ-SEW-1303-1

OBLIQUE BACKDROP REFER TO SEQ STD DWG SEQ-SEW-1303-1

INTERNAL BACKDROP

REFER TO SEQ STD DWG SEQ-SEW-1303-1

EXTERNAL BACKDROP REFER TO SEQ STD DWG SEQ-SEW-1303-1

RIGS STRUCTURE DROPS

SEWER PROPERTY CONNECTION (STANDARD & EXTENDED) REFER TO SEQ STD DWGS SEQ-SEW-1104-1 SEWER PROPERTY CONNECTION (SLOPED CONNECTION) REFER TO SEQ STD DWGS SEQ-SEW-1104-1

SEWER PROPERTY CONNECTION (VERTICAL RISER) REFER TO SEQ STD DWG SEQ-SEW-1105-1

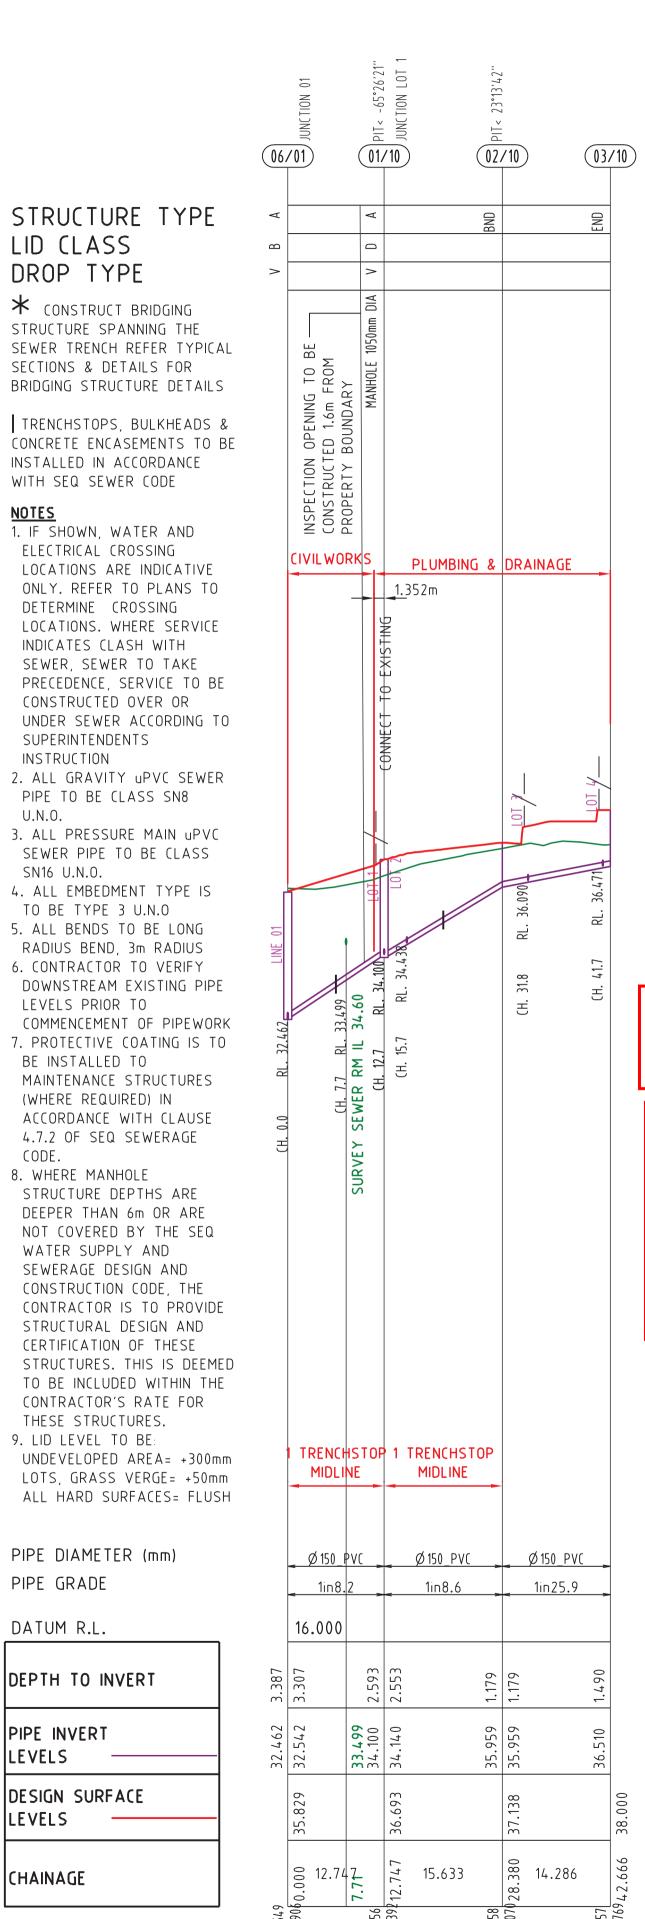
SEWER PROPERTY CONNECTION (STRAIGHT THROUGH SEWER) REFER TO SEQ STD DWG SEQ-SEW-1303-1

SEWER PROPERTY CONNECTION (INTERNAL BACKDROP) REFER TO SEQ STD DWG SEQ-SEW-1303-1

RISER CONNECTION TO PORTION OF MAINTENANCE SHAFT



LINE NO.



PLUMBERS COPY TO REMAIN ONSITE

PLUMBING & DRAINAGE ADVISORY NOTE and Drainage hydraulic design pursuant to the Plumbing and Drainage Act 2018. This approval is not to be taken as approval by Council or any other evelopment and does not alleviate the need to comply with all developmen requirements of Council's Planning Scheme and any relevant Local Laws and

PLUMBING & DRAINAGE ADVISORY NOTE The Private Certifier is to assess matters relating to Council's Planning Scheme Policies, Local Laws and Building Certification functions to ensure

> **Council of the City of Gold Coast** Plumbing & Drainage Services NOTE

Council approved hydraulic plans to be kept on As constructed plans are required prior to final

Approval subject to Council's conditions of

The Plumbing & Drainage design is provisional only and may be amended by the site inspectors

PCS/2019/2926

9 October 2019

pliance with the above.

(01/L0T1) (01/L0T2) (01/10)(02/LOT2) (01/L0T3)(02/L0T3)(01/L0T4)(02/L0T4)Ø 150_PV(Ø 150_PV(_ 1in48.5₋ 1in7.3 1in1.0 16.000 16.000 18.000 18.000 2.593 2.367 1.437 36.522 36.522 36.522 36.538 140 S1.000 0.000 **81.000** E:528680.463 N:6911825.28 E:528661.7 N:6911823.

LOT 3

LOT 4

PROJECT NAME

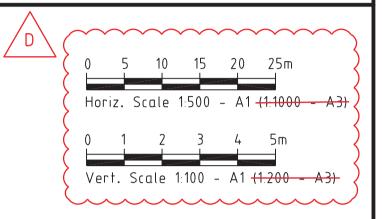
DONINGTON DRIVE RESIDENTIAL

PLUMBING & DRAINAGE

RP DESCRIPTION Lot 3 on SP275769 DONINGTON DRIVE LOCALITY OF OXENFORD LOCAL AUTHORITY - CITY OF GOLD COAST

CLIENT

TELLURIUM GG Pty Ltd



- 1	SSUE	S DATE
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D	08-10-19	SCALE BAR AMENDED TO SHOW ORIGINAL A1 & A3 SCA
C	02-10-19	INSPECTION OPENING AND TEXT ADDED
В	13-09-19	SCALE BAR AMENDED TO SHOW ONLY A3 SCALE
Α	26-08-19	COUNCIL ISSUE
PRE	DATE	AMENDMENT

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SEWER RETICULATION **PROFILES** SHEET 01



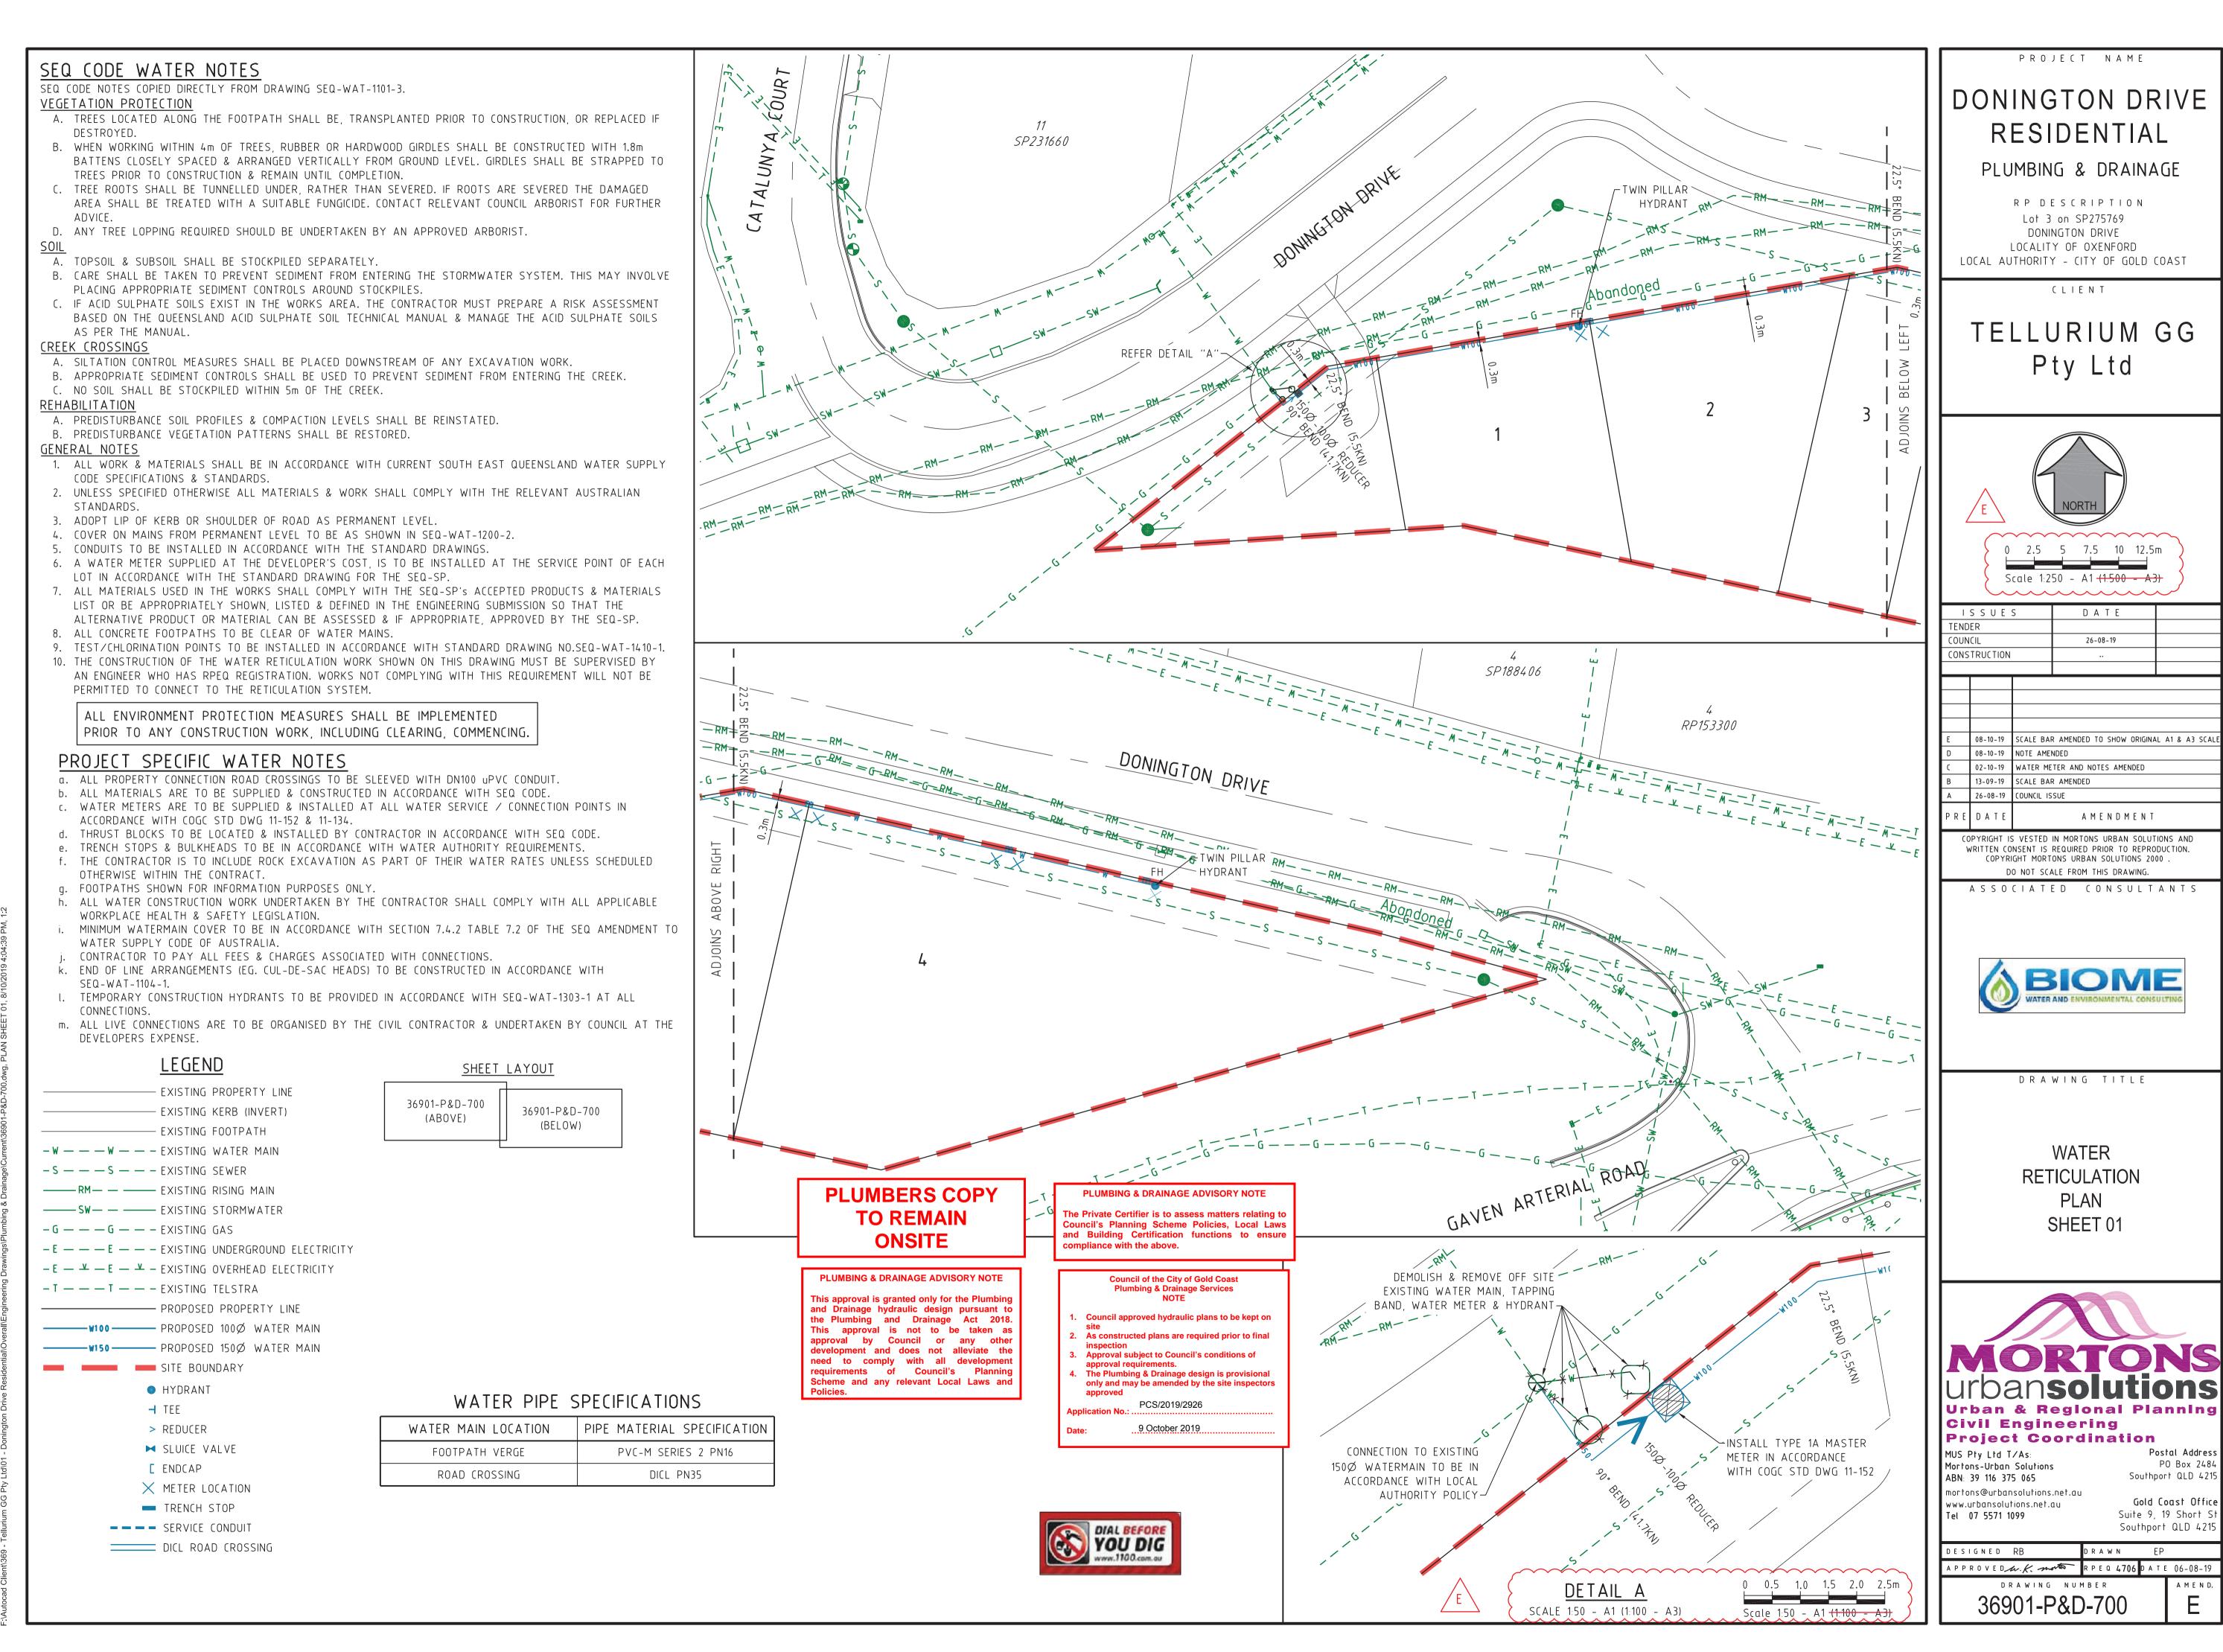
Mortons-Urban Solutions ABN: 39 116 375 065 mortons@urbansolutions.net.au www.urbansolutions.net.au Tel 07 5571 1099

PO Box 2484 Southport QLD 4219 Gold Coast Office Suite 9, 19 Short S

AMEND.

Southport QLD 4215 DESIGNED RB DRAWN APPROVEDM.K. morto RPEQ **4706** DATE 06-08-19

> DRAWING NUMBER 36901-P&D-530



AMEND.

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PLUMBING & DRAINAGE ADVISORY NOTE

This approval is granted only for the Plumbing and Drainage hydraulic design pursuant to the Plumbing and Drainage Act 2018. This approval is not to be taken as approval by Council or any other development and does not alleviate the need to comply with all development requirements of Council's Planning Scheme and any relevant Local Laws and Policies.

PLUMBING & DRAINAGE ADVISORY NOTE

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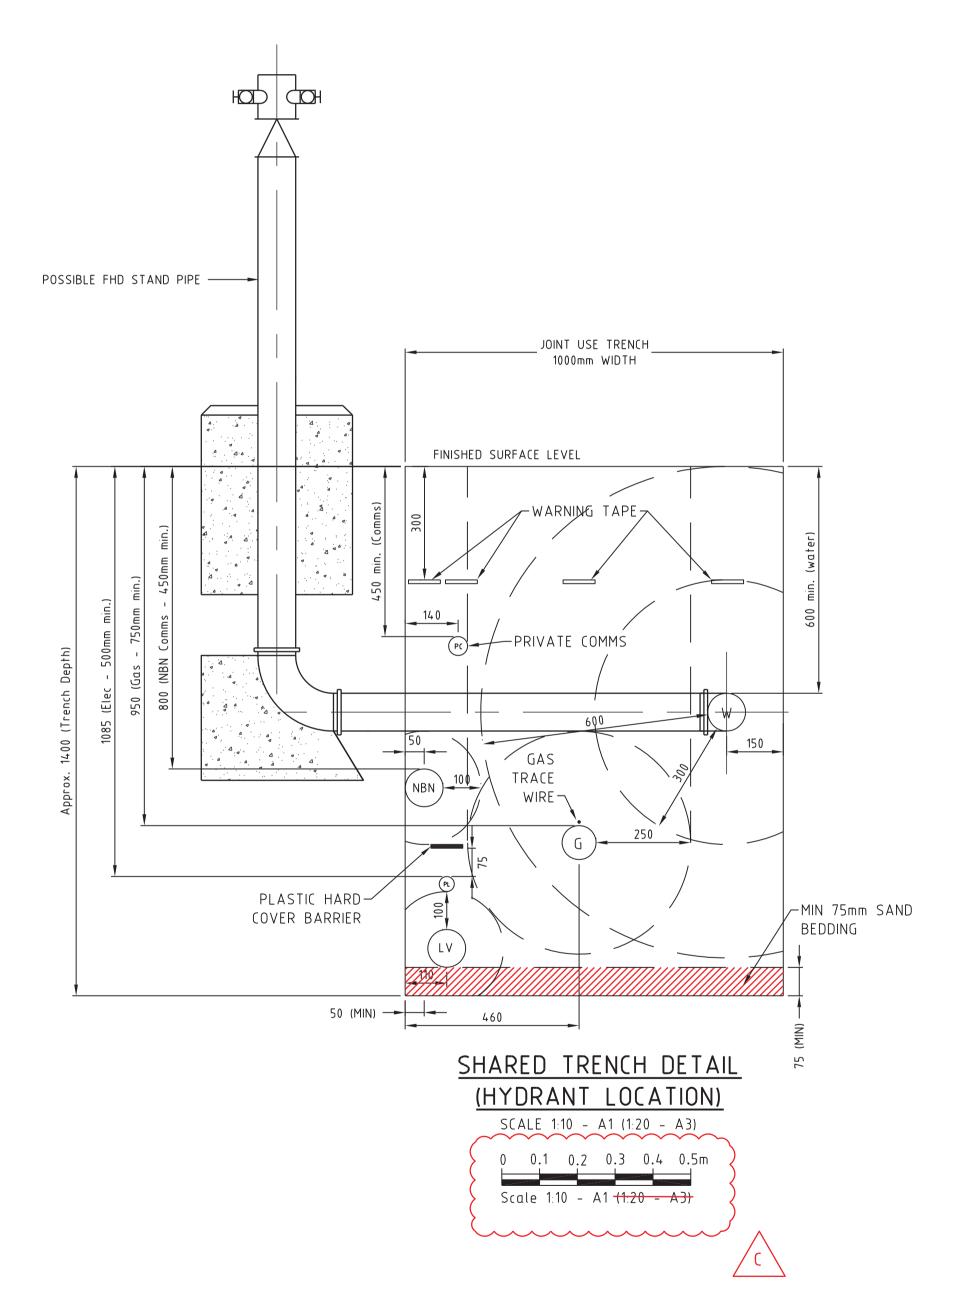
Council of the City of Gold Coast Plumbing & Drainage Services NOTE

- I. Council approved hydraulic plans to be kept on
- 2. As constructed plans are required prior to final
- 3. Approval subject to Council's conditions of
- 4. The Plumbing & Drainage design is provisional only and may be amended by the site inspectors

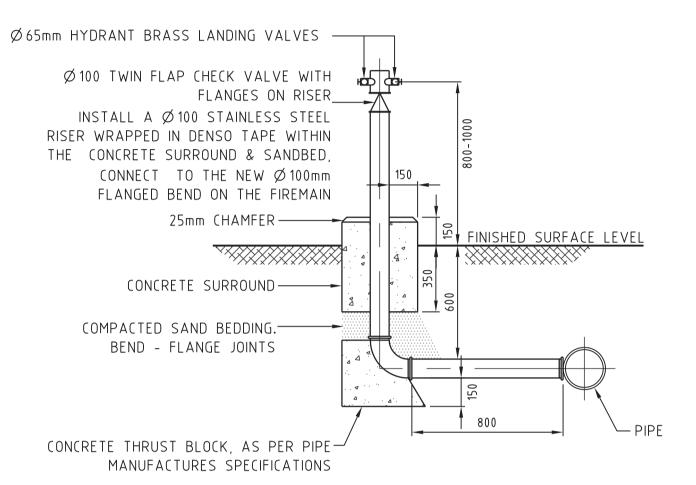
PCS/2019/2926

Date:

9 October 2019









NOTE: POSITION THE FIRE HYDRANT LANDINGS VALVE OUTLET AT 35Ø MAXIMUM LOOKING DOWN FROM THE HORIZONTAL

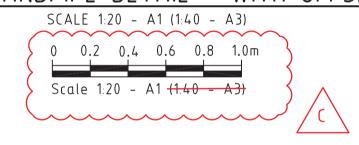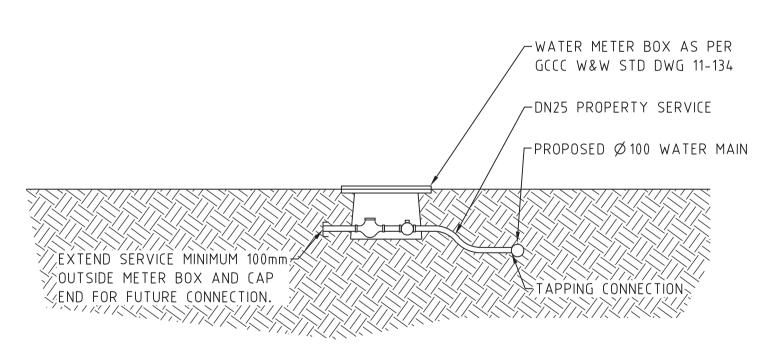FIRE HYDRANT STANDPIPE DETAIL - WITH OFFSET FROM MAIN





TYPICAL WATER HOUSE CONNECTION SCALE N.T.S

PROJECT NAME

DONINGTON DRIVE RESIDENTIAL

PLUMBING & DRAINAGE

RP DESCRIPTION

Lot 3 on SP275769

DONINGTON DRIVE

LOCALITY OF OXENFORD

LOCAL AUTHORITY - CITY OF GOLD COAST

CLIENT

TELLURIUM GG Pty Ltd

I	SSUE	DATE
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В	08-10-19	DETAIL AMENDED
Α	03-10-19	COUNCIL ISSUE
PRE	DATE	AMENDMENT

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DRAWING TITLE

WATER
RETICULATION
DETAIL
SHEET 01



MUS Pty Ltd T/As:
Mortons-Urban Solutions
ABN: 39 116 375 065
mortons@urbansolutions.net.au
www.urbansolutions.net.au

Tel 07 5571 1099

PO Box 2484 Southport QLD 4215

Gold Coast Office Suite 9, 19 Short St Southport QLD 4215

DESIGNED RB DRAWN EP

APPROVED M.K. mortor RPEQ 4706 DATE 06-08-19

36901-P&D-701

DRAWING NUMBER

С

AMEND.

PLUMBERS COPY TO REMAIN ONSITE

TEE OR CLOSED END 112.2

PLUMBING & DRAINAGE ADVISORY NOTE

This approval is granted only for the Plumbing and Drainage hydraulic design pursuant to the Plumbing and Drainage Act 2018. This approval is not to be taken as approval by Council or any other development and does not alleviate the need to comply with all development requirements of Council's Planning Scheme and any relevant Local Laws and

PLUMBING & DRAINAGE ADVISORY NOTE

The Private Certifier is to assess matters relating to Council's Planning Scheme Policies, Local Laws and Building Certification functions to ensure compliance with the above.

Plumbing & Drainage Services NOTE

- Council approved hydraulic plans to be kept or
- inspection
- Approval subject to Council's conditions of approval requirements.
 The Plumbing & Drainage design is provisional only and may be amended by the site inspectors

PCS/2019/2926

Application No.: 9 October 2019

THRUST BLOCK LENGTH THRUST BLOCK LENGTH FITTING FITTING DN DN. 19.8 241.9 2220 1510 1260 90° BEND 1000 • • 90° BEND 700 171.0 2140 1430 1070 890 14.0 60° BEND • 60° BEND 130.9 45° BEND 10.7 45° BEND 1640 1090 820 680 • • 400 800 5.5 66.7 1670 840 • 22.5° BEND • • 22.5° BEND 11.25° BEND 2.7 11.25° BEND 33.5 840 • • • 700 2140 1430 1070 890 TEE OR CLOSED END 171.0 TEE OR CLOSED EN • • 1860 930 2540 1900 1590 90° BEND 41.7 • 90° BEND 342.6 * 29.5 242.3 1350 2690 1800 1120 60° BEND 1320 660 • 60° BEND 185.4 1375 1030 22.6 1000 2060 860 45° BEND • 45° BEND 94.5 2100 1050 700 22.5° BEND • 22.5° BEND • 47.5 1060 11.25° BEND 5.8 11.25° BEND • 29.5 1800 2690 1300 660 TEE OR CLOSED END 242.3 1350 1120 TEE OR CLOSED END • 1300 870 650 2790 2090 1740 418 90° BEND 71.7 90° BEND * 295.6 50.7 920 1970 1480 1230 60° BEND 1850 • 60° BEND 38.8 226.2 45° BEND 1510 940 700 45° BEND 2260 1130 1410 • 550 19.8 22.5° BEND 720 • 22.5° BEND 115. 2310 1150 770 • 58.0 11.25° BEND 11.25° BEND 1160 • • • • 1970 1850 920 1480 1230 TEE OR CLOSED END 50.7 • TEE OR CLOSED END 295.5 2250 1500 1000 750 2700 90° BEND 90° BEND 593 1060 700 2540 1910 1590 63.2 419 2110 60° BEND 60° BEND • 48.4 320 45° BEND 1620 810 45° BEND 1100 * 2920 1950 1460 1220 • 600 600 24.6 22.5° BEND 22.5° BEND 164 2980 1490 990 750 620 • • • 11.25° BEND • • 11.25° BEND 82.2 1500 750 • TEE OR CLOSED END 63.2 1060 700 TEE OR CLOSED END 419 2540 • 1590 1700 1120 840 700 90° BEND 109.0 90° BEND 77.1 2400 1200 800 643 2480 2060 60° BEND • 60° BEND 59.0 492 1580 2530 1890 45° BEND 45° BEND 1820 • 1300 650 750 30.1 1290 22.5° BEND 930 22.5° BEND 251 1930 970 810 • 650 15.1 970 126.1 1940 11.25° BEND 11.25° BEND • • 1200 800 * 77.1 2400 2480 2060 TEE OR CLOSED EN TEE OR CLOSED END 643 158.6 2270 | 1510 | 1140 | 950 1.228 3420 90° BEND 90° BEND * * * 1600 1070 800 670 112.2 2420 868 * * 2900 60° BEND 60° BEND 85.9 664 700 1500 45° BEND 2453 1230 820 45° BEND * 2960 2220 1850 • 900 * (Ø960 43.8 630 22.5° BEND 1250 22.5° BEND 339 2260 1510 1130 940 • • 11.25° BEND 22.0 170 760 630 11.25° BEND 2270 1140 . • •

THRUST BLOCK DIMENSIONS - 1200kPa

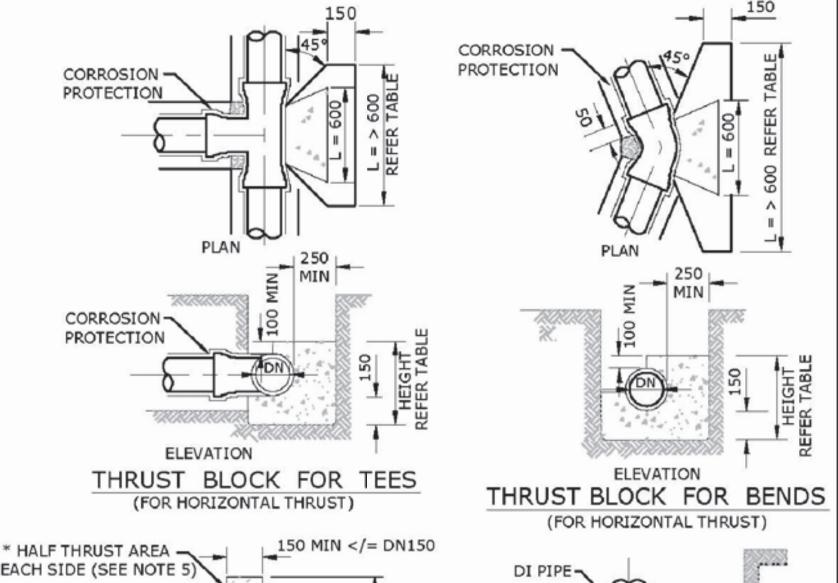
TEE OR CLOSED END 868

- INDICATES BLOCK LENGTH OF 600
- * = SPECIAL DESIGN

750

800

1600 1070



CORROSION

PROTECTION

ELEVATION

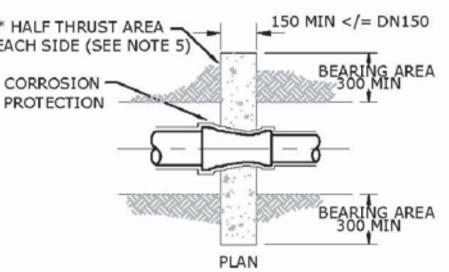
FLUSHING/WASHOUT BEND

THRUST BLOCK

(FOR HORIZONTAL THRUST) (MINIMUM

REQUIRED THRUST AREA AS PER TEE

OR CLOSED END)



TAPER THRUST BLOCK
(FOR HORIZONTAL THRUST)

OTES (FOR HORIZONTAL

1. ALL DIMENSIONS IN MILLIMETRES UNLESS OTHERWISE SPECIFIED.

- 2. CAST THE THRUST AREA OF ALL THRUST BLOCKS AGAINST A CLEAN FACE OF UNDISTURBED NATURAL SOIL. SOIL CLASSIFICATIONS USED ON THIS DRAWING ARE EXPLAINED IN SEQ-WAT-1200-1. DO NOT USE STANDARD THRUST BLOCKS AS SPECIFIED IN THIS DRAWING IN SOILS WITH < 50kPa BEARING CAPACITY EG;
 - VERY SOFT, SOFT OR FIRM CLAY.
- LOOSE CLEAN SAND.

2650

3300

*

- UNCOMPACTED FILL OR REFUSE.
- A GEOTECHNICAL ASSESSMENT AND INDIVIDUAL DESIGN IS REQUIRED FOR THESE SOILS.

 THRUST BLOCKS NOT TO INTERFERE WITH OTHER SERVICES OR BE LOCATED OUTSIDE THE WATER MAIN ALLOCATION WITHOUT WATER AGENCY APPROVAL.
- ALL CONCRETE GRADE N20. TABLE OF DIMENSIONS BASED ON REQUIRED TEST PRESSURE OF 1200kPa AND ACTUAL DICL PIPE DIAMETERS.
- 5. THE MINIMUM THRUST AREA FOR TAPER THRUST BLOCKS TO BE EQUAL TO THE DIFFERENCE BETWEEN THE THRUST AREAS FOR TEES OR CLOSED ENDS OF EQUIVALENT DIAMETER TO THOSE EACH SIDE OF TAPER. THE DETAIL SHOWN IS FOR < OR = DN150 MAINS. FOR LARGER MAINS, THE TAPER THRUST BLOCK SHALL BE REINFORCED AND OF A SIZE AS SHOWN IN SEQ-WAT-1206-1.
- FOR DOWNWARD VERTICAL THRUST, THE ALLOWABLE BEARING PRESSURES FOR VARIOUS SOILS MAY BE TAKEN AS TWICE THAT FOR HORIZONTAL THRUST SHOWN.
- WHEN POURING CONCRETE AGAINST FITTINGS PLACE A MEMBRANE OF POLYETHYLENE, PVC OR FELT BETWEEN THE FITTING AND CONCRETE TO PREVENT DAMAGE TO THE FITTING. PIPE JOINTS TO BE CLEAR OF CONCRETE.
- 8. CONCRETE THRUST BLOCK ANCHORS FOR VALVES TO BE AS DETAILED ON SEQ-WAT-1206-1.

REV. No.	DATE	DESCRIPTION	AUTH.		WATER SUPPLY STANDARD DRAWING	GCCC	LCC	RCC	QUU	UW
				SEQ WATER	TYPICAL THRUST BLOCK DETAILS	DRAWING No				VERSION
				SERVICE PROVIDERS	MASS CONCRETE	SEQ-WAT-1205-1		A		
				WORK PRACTICES MUST COMPLY WITH ALL APPLICABLE OCCUPATIONAL HEALTH & SAFETY LEGISLATION		NOT	TO SCALE			ORG DATE: 1/1/2013

PROJECT NAME

DONINGTON DRIVE RESIDENTIAL

PLUMBING & DRAINAGE

RPDESCRIPTION

Lot 3 on SP275769

DONINGTON DRIVE

LOCALITY OF OXENFORD

LOCAL AUTHORITY - CITY OF GOLD COAST

CLIENT

TELLURIUM GG Pty Ltd

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TEND	ER					
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DRAWING TITLE

WATER
RETICULATION
DETAIL
SHEET 02



Project Coordination

MUS Pty Ltd T/As: Po

Mortons-Urban Solutions

ABN: 39 116 375 065 Southp

Mortons-Urban Solutions
ABN: 39 116 375 065
mortons@urbansolutions.net.au
www.urbansolutions.net.au

Gold Coast Office Suite 9, 19 Short St

Southport QLD 4215

Postal Address
PO Box 2484

Tel 07 5571 1099

Suite 9, 19 Short S
Southport QLD 4215

DESIGNED RB

DRAWN EP

APPROVED ALK. MOTO RPEQ 4706 DATE 06-08-19

DRAWING NUMBER AMEND.

36901-P&D-710

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36901-P&D-710

F:\Autocad Client\369 - Tellurium GG Ptv Ltd\01 - Donington Drive Residentia\\Overal\\Engineering Drawings\Plumbing & Drainage\Current\36901-P&D-700.dwg. DETA\L SHEET 02. 8/10\'.

Our reference: OPW/2019/1241

Your reference:

Decision notice—approval (with conditions)

(Given under section 63(2) of the *Planning Act 2016*)

Date of decision notice: 29 October 2019

Applicant details

Applicant name: Tellurium Gg Pty Ltd

Applicant contact details: C/- Mortons Urban Solutions

PO BOX 2484

SOUTHPORT QLD 4215

Application details

Application number: OPW/2019/1241

Approval sought: Operational Works

Details of proposed Development Permit for Operational Works for Change to Ground

Level (Earthworks and Retaining Walls), Tree works (vegetation clearing) and Works for Infrastructure (Roadworks, Stormwater

Drainage and Sewerage Reticulation).

Location details

development:

Street address: Lot 3 Gaven Arterial Road, Maudsland Qld 4210

Real property description: Lot 3 SP275769

Decision

Date of decision 29 October 2019

Decision details: Under Delegated Authority, the Executive Coordinator for Engineering

and Environmental Assessment has resolved to approve the

development application in full with conditions.

Referral agency(s) for the application

Not applicable – no part of the application required referral.

Details of the approval

Development permit Operational Works for Change to Ground Level (Earthworks and

Retaining Walls), Tree works (vegetation clearing) and Works for Infrastructure (Roadworks, Stormwater Drainage and Sewerage

Reticulation).

Conditions

The conditions that have been imposed by Council, as Assessment manager, are enclosed.

Properly made submissions

Not applicable—No part of the application required public notification.

Currency period for the approval (section 85 of the Planning Act 2016)

In accordance with section 85 of the *Planning Act 2016*, this approval has a currency period of two years.

Approved plans and drawings

Approved plans and drawings are attached and are identified in the conditions imposed by Council as the Assessment manager.

Appeal rights

Applicant

You have appeal rights in relation to this decision. An appeal may be made against, as applicable:

- the refusal of part of the development application; or
- a provision of the development approval; or
- if a development permit was applied for, the decision to give a preliminary approval.

An appeal must be started within 20 business days after this notice is given to you.

An appeal may be made to the Planning and Environment Court or, for certain matters which are identified in section 1(2) of Schedule 1 of the *Planning Act 2016*, to a development tribunal.

An appeal is started by lodging a notice of appeal with the registrar of the Planning and Environment Court or a development tribunal, as applicable. The notice of appeal must be in the approved form, succinctly state the grounds of the appeal and be accompanied by the required fee.

An appellant to the Planning and Environment Court must give a copy of the notice of appeal, within 10 business days after the appeal is started, to the persons identified in section 230(3) of the *Planning Act 2016.* A person who is appealing to the Planning and Environment Court must comply with the rules of the court that apply to the appeal.

An extract of Chapter 6, Part 1 and Schedule 1 of the *Planning Act* 2016 is attached to this notice, which sets out further information about the appeal rights.

For further information please contact Nathan Seiler, Civil Engineer on p: 07 5582 8866 or via email mail@goldcoast.qld.gov.au who will be pleased to assist.

AUTHORISED BY

Sam Hartley

Executive Coordinator Engineering & Environmental Assessment

For the Chief Executive Officer Council of the City of Gold Coast

enc:

Conditions imposed by Council as Assessment manager

Attach:

Stamped approved plans and drawings

Appeal rights extracts

General

1 Timing

a All conditions of this development approval must be complied with at no cost to Council at all times unless otherwise stated in another condition.

2 Approved drawings

Undertake and maintain the development generally in accordance with the following drawings including as amended in red by the Council:

Operational Works				
Drawing Title	Author	Date	Drawing No.	Ver
Title Page	Mortons Urban Solutions	-	36901-ALL- 000	В
Existing Features and Demolition Plan Sheet 01	Mortons Urban Solutions	26-08-19	36901-ALL- 020	A
Tree Clearing and Preservation Plan Sheet 01	Mortons Urban Solutions	26-08-19	36901-ALL- 030	Α
Earthworks Cut to Fill Plan Sheet 01	Mortons Urban Solutions	03-10-19	36901-ALL- 040	В
Bulk Earthworks Section Key Plan	Mortons Urban Solutions	02-10-19	36901-ALL- 050	В
Bulk Earthworks Sections Sheet 01	Mortons Urban Solutions	26-08-19	36901-ALL- 051	Α
Bulk Earthworks Sections Sheet 02	Mortons Urban Solutions	03-10-19	36901-ALL- 052	В
Retaining Wall and Detail Grading Plan Sheet 01	Mortons Urban Solutions	02-10-19	36901-ALL- 060	В
Retaining Wall Details Sheet 01	Mortons Urban Solutions	02-10-19	36901-ALL- 070	В
Final Trim Details Sheet 01	Mortons Urban Solutions	26-08-19	36901-ALL- 071	Α
Final Surface and Sediment and Erosion Plan Sheet 01	Mortons Urban Solutions	02-10-19	36901-ALL- 080	В
Combined Services Plan Sheet 01	Mortons Urban Solutions	02-10-19	36901-ALL- 090	В
Roadworks Plan Sheet 01	Mortons Urban Solutions	02-10-19	36901-ALL- 100	В
Roadworks Details Sheet 01	Mortons Urban Solutions	26-08-19	36901-ALL- 120	Α
Longitudinal Sections Donongton Drive	Mortons Urban Solutions	26-08-19	36901-ALL- 200	Α
Cross Sections Donington Drive	Mortons Urban Solutions	26-08-19	36901-ALL- 300	Α
Concrete Jointing Plan and Details Sheet 01	Mortons Urban Solutions	02-10-19	36901-ALL- 410	В
Sewer Reticulation Plan Sheet	Mortons Urban	02-10-19	36901-ALL-	В

01	Solutions		500	
Sewer Reticulation Profiles Sheet 01	Mortons Urban Solutions	02-10-19	36901-ALL- 530	В
Stormwater Drainage Plan Sheet 01	Mortons Urban Solutions	02-10-19	36901-ALL- 600	В
Stormwater Profiles Sheet 01	Mortons Urban Solutions	02-10-19	36901-ALL- 620	В
Stormwater Details Sheet 01	Mortons Urban Solutions	26-08-19	36901-ALL- 640	Α
Stormwater Catchment Plan Sheet 01	Mortons Urban Solutions	02-10-19	36901-ALL- 670	В
Stormwater Calculation Tables Minor and Major Storm Event Sheet 01	Mortons Urban Solutions	03-10-19	36901-ALL- 680	В
Tree Location Plan	Biome	15 August 2019	BC-19093	А
Critical Tree Zone Plan	Biome	15 August 2019	BC-19093	А
Development Impact Plan	Biome	15 August 2019	BC-19093	А
Vegetation Clearing Plan	Biome	15 August 2019	BC-19093	А
Tree Information Table- 1	Biome	15 August 2019	BC-19093	А
Tree Information Table- 2	Biome	15 August 2019	BC-19093	А

The conditions of this approval are to be read in conjunction with the attached stamped approved drawings. Where a conflict occurs between the conditions of this approval and the stamped approved drawings, the conditions of this approval shall take precedence.

3 Approved Plans

Undertake and maintain the development generally in accordance with the following plans:

Operational Works									
Plan Title	Author	Date	Plan Reference No.	Ver					
Fauna Management Plan	Biome	October 2019	BC-19093	1					
Vegetation Management and Tree Clearing Plan	Biome	August 2019	BC-19093	1					

Environmental and Landscaping

4 Vegetation management

a) Implement the vegetation management measures identified in the plan listed below at no cost to Council:

Plan Title	Author	Date	Plan Reference No.	Ver
Vegetation	Biome	August 2019	BC-19093	1

Management and		
Tree Clearing Plan		

Undertake works generally in accordance with an operational works approval and City Plan Policy SC6.8 – Environmental management plans and the Vegetation management code.

5 Vegetation management

Undertake works generally in accordance with an operational works approval and the Environmental significance overlay code, the Vegetation management code and City Plan Policy SC6. 8 – Environmental management plans at no cost to Council.

6 Tree pruning and work

- a Topping, lopping, spur or spike climbing of any tree must not occur.
- Pruning may only occur in a manner consistent with the Australian Standard AS4373 -2007

 Pruning of Amenity Trees.
- c Undertake all other work on the trunk, foliage or root systems of the trees marked on the drawings listed below in a manner consistent with *Australian Standard AS4373 2007 Pruning of Amenity Trees.*

7 Root pruning and barriers

- a Ensure root pruning utilises a high pressure, needle point water jet prior to insertion of proprietary root barriers.
- b Ensure root barriers are installed to a minimum depth of 900mm along the side closest to the structure specified in the approved scope of works condition to prohibit or deter growth of roots towards the structure.

8 No damage to retained vegetation

Ensure all other existing vegetation is retained and not disturbed or damaged during implementation of the approved works.

9 Fauna management

a Implement the fauna management measures identified in the plan listed below at no cost to Council:

Plan Title	Author	Date	Plan Reference No.	Ver
Fauna Management Plan	Biome	October 2019	BC-19093	1

b Undertake the fauna management works generally in accordance with an operational works approval and S.C6.8 Environmental Management Plans policy of the City Plan.

10 Supervision of works

During construction of any works the following professionals must be appointed to supervise the below described actions:

Environmental Assessment	
Expertise required of the suitably qualified professional	Actions to be overseen by the professional
DES approved spotter catcher	Ensure wildlife is suitably cared for during clearing work and at any time where damage to the vegetation is possible.

11 Pre-start inspection

Arrange a pre-start inspection prior to the commencement of works to complete the

requirements identified in City Plan Policy SC6. 11 – Land development guidelines for the following:

Purpose	Council contact
Undertake a pre-clearing fauna assessment including confirmation of wildlife spotter qualifications	Environmental planning 0755828866

Copies of applicable material including this decision notice and stamped approved plans, drawings and reports are to be available for the meeting and kept on site during construction.

12 Hold point inspection

Arrange a hold point inspection to complete the requirements identified in City Plan Policy SC6. 11 – Land development guidelines / Landscape work code of the City Plan for the following:

Purpose	Hold Point	Council contact
Confirm the post clearing fauna summary	Within 5 business days of tree works being finalised	Environmental planning 0755828866

Copies of applicable material including this decision notice and stamped approved plans, drawings and reports are to be available for the meeting and kept on site during construction.

Engineering

13 Rectification of Council's infrastructure

- a Rectify any damage caused to Council infrastructure (including roads, kerb & channelling, service pits, footpaths and water and sewer reticulation networks) prior to an 'on maintenance' inspection, at no cost to Council.
- Maintain the rectified Council infrastructure at no cost to Council until the asset is accepted "off maintenance" by the City in accordance with the procedures in City Planning Policy SC6.11 – Land development guidelines, sections 7 Procedures, 8.5 As-constructed requirements, 9 Specifications and 10 Standard drawings.

14 Footpaths

Construct and maintain the footpath identified in the approved drawings condition at no cost to Council until the asset is accepted "off maintenance" by the City in accordance with the procedures in City Planning Policy SC6.11 – Land development guidelines, sections 2 Transport network standards, 7 Procedures, 8.5 As-constructed requirements, 9 Specifications and 10 Standard drawings.

15 Roadworks

Construct and maintain the roadworks identified in the approved drawings condition at no cost to Council until the asset is accepted "off maintenance" by the City in accordance with the procedures in City Planning Policy SC6.11 – Land development guidelines, sections 2 Transport network standards, 7 Procedures, 8.5 As-constructed requirements, 9 Specifications & 10 Standard drawings.

16 Earthworks and private retaining walls

- a Construct the earthworks and private retaining walls identified in the approved drawings condition at no cost to Council in accordance with the standards and procedures in City Planning Policy SC6.11 Land development guidelines, sections 3 Change to Ground level standards, 7 Procedures, 8.5 As-constructed requirements and 9 Specifications and 10 Standard drawings.
- b Maintain the earthworks and private retaining walls (inclusive of any associated drainage) identified above at no cost to Council at all times.

Stormwater Drainage

17 Overland flow paths and hydraulic alterations

- a Leave unaltered the overland flow paths on the site, such that the characteristics of existing overland flows on other properties remain uninhibited and unchanged.
- b The development must not:
 - i Increase peak flow rates downstream from the site
 - ii Increase flood levels external to the site
 - iii Increase duration of inundation external to the site that could cause loss or damage

18 Stormwater drainage / Legal point of discharge

Construct and maintain the stormwater drainage system identified in the approved drawings condition at no cost to Council until the asset is accepted "off maintenance" by the City in accordance with the procedures in City Planning Policy SC6.11 – Land development guidelines, sections 4 Stormwater drainage and water sensitive urban design standards, 7 Procedures, 8.5 As-constructed requirements, 9 Specifications and 10 Standard drawings.

Sewer and Water Works

19 Sewer reticulation

Construct and maintain the sewer reticulation system /connection identified in the approved drawings condition at no cost to Council until the asset is accepted "off maintenance" by the City in accordance with the procedures in City Plan Policy SC6.11 – Land development guidelines, Section 6 – Water supply and sewerage reticulation standards, Section 7 – Procedures, Section 8.5 – As-constructed requirements, Section 9 - Specifications and Section 10 – Standard drawings and include in particular:

- i The size of the sewer property service connection must be in accordance with Section 4.5.4 of the SEQ Water Supply & Sewerage Design & Construction Code (SEQ WS&S D&C Code).
- ii Remove / seal / cap redundant sewer property services.

Construction Management

20 Certification of works

Provide Council with certificates prepared by qualified experts from the disciplines listed below, confirming as follows:

Operational Works					
Certified document	Certification date	Plan/ Drawing	Expert discipline	Requesting Council Section	
Appendix A Certification from the Land Development Guidelines	Upon practical completion of works.	N/A	Registered Professional Engineer Queensland (RPEQ)	Contributed Assets	

The certification is to confirm:

All works have been undertaken generally in accordance with the approval.

Operational Works					
Certified document	Certification date	Plan/ Drawing	Expert discipline	Requesting Council Section	
Design and inspection intent certificate for retaining walls	Upon practical completion of works.	N/A	Registered Professional Engineer Queensland (RPEQ)	Contributed Assets	

The certification is to confirm:

- The retaining walls have been designed in accordance with relevant standards (i.e AS4678).
- Retaining walls have been adequately completed with inspections completed at the following stages:
 - Footing (including excavation and reinforcement);
 - Drainage behind the wall (including geo-fabric, backfill and perforated pipe)
 and completion (including point of stormwater discharge)

Geotechnical Engineering					
Certified document	Certification date	Plan/ Drawing	Expert discipline	Requesting Council Section	
Retaining structures design	Prior to commencement of any works	-	Registered Professional Engineer of Queensland (RPEQ) specialising in geotechnical engineering	Geotechnical Engineering	

The certification is to confirm:

- i All retaining structures on site/ within the stage are designed based on existing geotechnical conditions of the site taking into account all predicted surcharge loading.
- ii All designed retaining structures on site/ within the stage achieve adequate stability with a long term factor of safety greater than or equal to 1.5 against geotechnical failure.

Geotechnical E	Geotechnical Engineering					
Certified document	Certification date	Plan/ Drawing	Expert discipline	Requesting Council Section		
Retaining structures construction	Immediately following completion of all earthworks on site		Registered Professional Engineer of Queensland (RPEQ) specialising in geotechnical engineering	Development compliance		

The certification is to confirm:

All constructed retaining structures on site/ within the stage achieved adequate stability

with a long term factor of safety greater than or equal to 1.5 against geotechnical failure.

Water and Waste					
Certified document	Certification date	Plan/ Drawing	Expert discipline	Requesting Council Section	
Requirements of Council Water and Sewerage acceptance testing guideline	Prior to connect to existing mains and the use of the connection		Registered Professional Engineer of Queensland (RPEQ)	Water and Waste	

The certification is to confirm:

Infrastructure meets the requirements specified in the SEQ Water Supply and Sewerage Design and Construction Code for sewerage infrastructure.

21 Supervision of works

During construction of any works the following professionals must be appointed to supervise the below described actions:

All works approved by this permit				
Expertise required of the suitably qualified professional	Actions to be overseen by the professional			
Registered Professional Engineer of Queensland (RPEQ)	All supply, installation, construction, testing and commissioning of works			
Operational works				
Expertise required of the suitably qualified professional	Actions to be overseen by the professional			
Registered Professional Engineer of Queensland (RPEQ)	Bulk earthworks inspected to level 1 in accordance with AS3798-2007			

22 Availability of approved plans, drawings and reports

Retain a copy of this decision notice and stamped approved plans, drawings and reports on site at all times during construction. Any contractors undertaking approved work (including tree removal or relocations) must be directly provided with a copy of these conditions and instructed as to the need to comply with them.

23 Transport of soil/fill/excavated material

During the transportation of soil and other fill/excavated material:

- a All trucks hauling soil, or fill/excavated material must have their loads secure and covered.
- b Any spillage that falls from the trucks or their wheels must be collected and removed from the site and streets along which the trucks travel on a daily basis.
- c Prior to vehicles exiting the site, measures must be taken to remove the soil from the wheels of the vehicles to prevent soil and mud being deposited on public roads.

24 Erosion and sediment control

a. Implement the erosion, sediment and dust control measures identified in the approved

drawings at no cost to Council.

- b. Undertake works generally in accordance with the operational works approval and include in particular:
 - Sediment controls must be maintained and amended as necessary to ensure that the measures implemented conform to the Construction Phase stormwater management design objectives of the State Planning Policy 2017 (Appendix 2 Table A).
 - ii. Erosion, sediment and dust control measures must be implemented in accordance with the approved plan / drawings and the Best Practice Erosion & Sediment Control (IECA Australasia, November 2008).
 - iii. Sediment control structures (e.g. sediment fence) must be placed at the base of all materials imported on-site to mitigate any sediment runoff.
 - iv. A perimeter bund and/or diversion drain must be constructed around the disturbed area to prevent any outside clean stormwater from mixing with polluted / contaminated stormwater.
 - v. All polluted / contaminated water from the site, including dewatering discharge, must be treated to achieve the water quality objectives in Table 8.2.1 of the Queensland Water Quality Guidelines (DERM, September 2009) prior to discharging from the site.
- c Inspections for erosion and sediment control measures are to occur in accordance with the compliance procedures in City Planning Policy SC6.11 – Land development guidelines, Section 4.5.17.1.2 – Compliance.

25 Pre-start inspection

Arrange a pre-start inspection prior to the commencement of works to complete the requirements identified in SC.6.11 City Plan Policy – Land development guidelines for the following:

Purpose	Council contact
Review and discuss this Operational works – infrastructure approval, and discuss Water and Waste and Council approval requirements and expectations through the construction phase	Contributed Assets (07) 5582 9034

Copies of applicable material including this decision notice and stamped approved plans, drawings and reports are to be available for the meeting and kept on site during construction.

26 Hold point inspection

Arrange a hold point inspection to complete the requirements identified in SC.6.11 City Plan Policy – Land development guidelines/Landscape work code of the City Plan for the following:

Purpose	Hold Point	Council contact
Confirm works have been undertaken in accordance with the operational works approval and associated hold point requirements identified in SC6.11 City Plan Policy – Land development guidelines	As indicated in SC6.11 City Plan Policy – Land development guidelines	Contributed Assets (07) 5582 9034

Copies of applicable material including this decision notice and stamped approved plans, drawings and reports are to be available for the meeting and kept on site during construction.

27 On maintenance

Arrange an on maintenance meeting to complete the requirements identified in SC.6.11 City Plan Policy – Land development guidelines for the following:

Purpose	Hold Point	Council contact
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Confirm completion of works have been undertaken in accordance with this approval	Prior to commencement of the on maintenance	Contributed Assets 07 5582 9034	_
	period		

Copies of applicable material including this decision notice and stamped approved plans, drawings and reports are to be available for the meeting and kept on site during construction.

28 Off maintenance

Arrange an off maintenance meeting to complete the requirements identified in SC.6.11 City Plan Policy – Land development guidelines for the following:

Purpose	Hold Point	Council contact
Confirmation works have been undertaken in accordance with the Operational works, Works for infrastructure approval	Prior to Asset handover / conclusion of on maintenance period	Contributed Assets (07) 5582 9034

Copies of applicable material including this decision notice and stamped approved plans, drawings and reports are to be available for the meeting and kept on site during construction.

Advice Notes

A Listing of Koala under EPBC Act

Koala populations in South East Queensland are listed under the Environment Protection and Biodiversity Conservation Act 1999 (*EPBC Act*) as a matter of national significance. All necessary approvals must be obtained prior to any works commencing on the site.

B Development infrastructure

Development infrastructure required to be provided in implementing this development approval is non-trunk development infrastructure unless otherwise stated in a condition of the approval.

C Connections and disconnections

Any connection / disconnection to the existing water and sewerage networks will be at the applicant's cost. Prior to the connection / disconnection taking place, the applicant must obtain written approval from Water and Waste.

Refer to Water and Sewerage Connections Policy, available on Council's website http://www.cityofgoldcoast.com.au

D Further development permits / compliance permits

Further development permits and/or compliance permits from Council are required to facilitate the development of the approved works identified in this decision notice. These include:

Water and Waste

Application to work on the City's Infrastructure

A copy of this decision notice and accompanying stamped drawings / plans must be submitted with any subsequent application identified above.

E Separate service connection points

Should a volumetric subdivision be pursued, separate water supply services will need to be designed and constructed to each of the different uses (e.g. commercial / residential), or to each of the volumetric lots created, so as to ensure that all lots within the site have separate service connection points. Internal services will need to be managed through the Building Management Statement.

F Connections to, alteration or realignment of Council infrastructure

Where development works require the connection to, alteration, removal or realignment of Council infrastructure or impact on other public utility infrastructure (e.g. telecommunications, electricity and gas), the applicant must obtain the necessary approvals from the relevant public utility authority prior to works commencing.

Connection to, alteration, removal or realignment of Council infrastructure includes (but is not limited to) fire hydrants, water service meters, sewer maintenance hole covers, stormwater drainage infrastructure, reinstatement of maintenance hole covers, stormwater drainage infrastructure, crossovers, footpaths, road pavement, kerb and channel, kerb ramps, medians, traffic islands, road furniture, signage and line-marking.

G Design, Constructability and Minor change applications

The application has been approved based on the information provided by the consultant. Water and Waste are not liable for any design or constructability issues experienced on-site. All necessary steps must be taken prior to construction to validate the information in the designs, including locating services. Should any changes be required to the design to ensure it can be constructed in compliance with relevant engineering standards; a Minor Change application (Section 78 of the *Planning Act 2016*) must be submitted and approved by Council prior to lodging a request for a Pre-Start meeting.

H Stormwater Management Devices

Stormwater management devices including the bio basin is considered internal and private infrastructure and is to be owned and maintained privately.

I Consistency with other related approvals

The assessment and approval of the operational work the subject of this permit, has been attended to having regard to the conditions of MCU201701129 dated 01 May 2018. Should any change to any of these approvals be sought and achieved, consideration by the applicant should also be had to the consequences on the related approvals (and the potential need to make subsequent changes to these related approvals).

J Compliance with conditions

Once this development approval takes effect, the conditions attach to the land and are applicable in perpetuity. It is a development offence to contravene a development approval, including any of its conditions.

K Indigenous cultural heritage legislation and duty of care requirement

The Aboriginal Cultural Heritage Act 2003 ('ACHA') is administered by the Department of Aboriginal and Torres Strait Islander and Multicultural Affairs (DATSIMA). The ACHA establishes a duty of care to take all reasonable and practicable measures to ensure any activity does not harm Aboriginal cultural heritage. This duty of care:

- a Is not negated by the issuing of this development approval;
- b Applies on all land and water, including freehold land;
- c Lies with the person or entity conducting an activity; and
- d If breached, is subject to criminal offence penalties.

Those proposing an activity involving surface disturbance beyond that which has already occurred at the proposed site must observe this duty of care.

Details of how to fulfil this duty of care are outlined in the duty of care guidelines gazetted with the ACHA.

The applicant should contact DATSIMA's Cultural Heritage Coordination Unit on 07 3405 3050 for further information on the responsibilities of developers under the ACHA.

L Encroachment of works

If any operational works, the subject of this approval encroaches on adjoining land, a letter from the adjoining owner must be submitted to Council consenting to the carrying out of these

works.

M Applicant responsibilities

The applicant is responsible for securing all necessary approvals and tenure, providing statutory notifications and complying with all relevant laws.

Nothing in this decision notice alleviates the need for the applicant to comply with all relevant local, State and Commonwealth laws and to ensure appropriate tenure arrangements have been made where the use of/reliance upon land other than that owned by the applicant is involved. Without liming this obligation, the applicant is responsible for:

- a Obtaining all other/further necessary approvals, licences, permits, resource entitlements etc. by whatever name called required by law before the development the subject of this approval can be lawfully commended and to carry out the activity for its duration;
- b Providing any notifications required by law (by way of example only, to notify the administering authority pursuant to the *Environment Protection Act 1994* of environmental harm being caused/threatened by the activity, and upon becoming aware the premises is being used for a 'notifiable activity'):
- Securing tenure/permission from the relevant owner to use private or public land not owned by the applicant (including for access required by conditions of approval);
- d Ensuring the correct siting of structures on the land. An identification survey demonstrating correct siting and setbacks of structures may be requested of the applicant to ensure compliance with this decision notice and applicable codes;
- e Providing Council with proof of payment of the Portable Long Service Leave building construction levy (or proof of appropriate exemption) where the value of the Operational Works exceed \$150,000. Acceptable proof of payment is a Q.Leave –Notification and Payment Form approved by the Authority. Proof of payment must be provided before Council can issue a development permit for the Operational works. This is a requirement of section 77(1) of the Building and Construction Industry (Portable Long Service Leave) Act 1991; and
- f Making payment of any outstanding Council rates and charges applicable to the development site prior to the lodgement of subdivision plans.
- Obtaining any necessary local government/state approvals where works require the installation of temporary ground anchoring into adjacent Road Reserves. Where ground anchoring is proposed into an adjacent private property, approval from the relevant property owners(s) is required

N Water usage

The use of potable water is not permitted in activities associated with road and pavement construction, the compaction of fill material or dust suppression. The use of recycled water is encouraged, especially where other alternative sources do not exist. Where recycled water is proposed to be used, contact the Water & Waste Recycled Water Management Team. More information is available for viewing on Council's website

http://www.goldcoast.qld.gov.au/environment/recycled-water-for-industry-7900.html

O Fire ant control

Northern suburbs of the Gold Coast are within Fire Ant Biosecurity zone 2 and must remain vigilant for the presence of fire ants. Under the Biosecurity Act 2014 individuals and organisations whose activities involve the movement or storage of fire ant carriers have a general biosecurity obligation to take all reasonable steps to ensure they do not spread fire ants. Movement of a fire ant carrier from within the fire ant biosecurity zone may need a biosecurity instrument permit. More information is available on the Department of Agriculture and Fisheries website www.daf.qld.gov.au/plants/weeds-pest-animals-ants/invasive-ants/fire-ants.

client/369 - tellurium gg pty Itd/01 - donington drive residential/Overallengineering drawings/Current/36901-ALL-000.dwg, COVER SHEET, Thu Oct 10 15:45:35 2019,

DONINGTON DRIVE RESIDENTIAL

PLANS AND DOCUMENTS referred to in the DEVELOPMENT APPROVAL

Application No: OPW/2019/1241

Dated:28 October 2019

Development shall comply with the conditions of approval as detailed in the Decision Notice and Council's Planning Scheme, Local Laws and Planning Policies

OPERATIONAL WORKS OVERALL No. 36901-ALL

SCHEDULE OF DRAWINGS NUMBER | REV. NO. | TITLE ARTHWORKS: EXISTING FEATURES & DEMOLITION 36901-ALL-020 A PLAN SHEET 01 ARTHWORKS: TREE PRESERVATION & CLEARING 6901-ALL-030 A ARTHWORKS: BULK EARTHWORKS (UT FILL 86901-ALL-040 B PLAN SHEET 01 ARTHWORKS: BULK FARTHWORKS 6901-ALL-050 B SECTIONS-SHEET 02 6901-ALL-052 ARTHWORKS RETAINING WALL & DETAIL GRADING 36901-ALL-060 E PLAN SHEET 01 901-ALL-070 DETAILS SHEET O DETAILS SHEET 01 ARTHWORKS: FINAL SURFACE & SEDIMENT AND EROSION CONTROL 36901-ALL-080 B PLAN SHEET 01 ARTHWORKS: COMBINED SERVICES PLAN SHEET 01 ROADS: ROADWORKS 86901-ALL-100 B PLAN SHEET 01 6901-ALL-120 A DETAILS SHEET 01 OADS: LONGITUDINAL SECTIONS 36901-ALL-200 A DONINGTON DRIVE ROADS: CROSS SECTIONS DONINGTON DRIVE 36901-ALL-300 A OADS: JOINTING DETAILS DETAILS SHEET 01 EWER: SEWER RETICULATION PLAN SHEET 01 6901-ALL-500 B EWER: PROFILES 6901-ALL-530 B PROFILES SHEET 01 DRAINAGE: STORMWATER PLAN SHEET 01 6901-ALL-600 B RAINAGE: PROFILES 6901-ALL-620 B PROFILES SHEET 01 RAINAGE: BASIN & STRUCTURE DETAILS 6901-ALL-640 A DETAILS SHEET 01 RAINAGE: CATCHMEN 6901-ALL-670 B PLAN SHEET 01 RAINAGE: CALCULATION TABLES MINOR & MAJOR SHEET 01

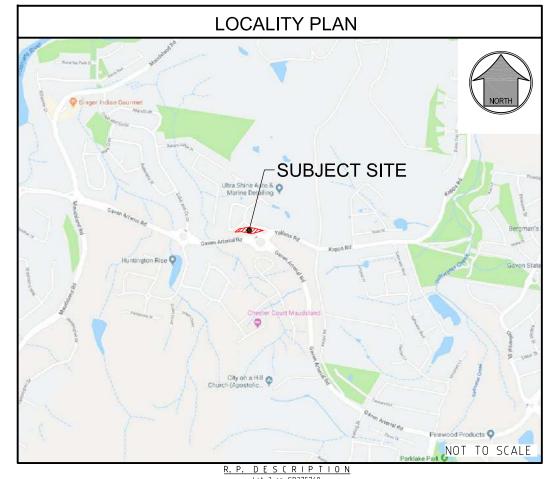




TELLURIUM GG
Pty Ltd

SUB-CONSULTANTS






Lot 3 on SP275769 DONINGTON DRIVE LOCALITY OF OXENFORD LOCAL AUTHORITY - CITY OF GOLD COAST

- 1. EXISTING SERVICES EXTERNAL WORKS THE LOCATIONS OF ALL EXISTING SERVICES WITHIN THE WORK AREA SHALL BE CONFIRMED BY THE CONTRACTOR PRIOR TO CONSTRUCTION COMMENCING. IT IS THE CONTRACTOR'S RESPONSIBILITY TO CONTACT THE RELEVANT AUTHORITIES & TO ENSURE THAT THE EXISTING SERVICES ARE NOT DAMAGED OR DISTURBED IN ANY WAY BY THE CONTRACT WORKS.
- 2. EXISTING STRUCTURES ALL EXISTING STRUCTURES & ASSOCIATED INFRASTRUCTURE TO BE REMOVED & DISPOSED OF
- 3. EXISTING DAMS EXISTING DAMS TO BE DEWATERED. ALL SILT & DEBRIS ARE TO BE REMOVED & LAWFULLY DISPOSED
 OF TO A TIP OFF SITE, OR INCORPORATED INTO THE
 SITE EARTHWORKS AT THE DIRECTION OF THE
 GEOTECHNICAL ENGINEER. REPLACEMENT FILL IS TO BE
 LOCATED & COMPACTED IN ACCORDANCE WITH LOCAL COUNCIL'S SPECIFICATIONS.

NOTE:

CONTRACTOR TO MAKE ALL NECESSARY ALLOWANCES FOR LOCATION AND PROTECTION OF EXISTING SERVICES DURING WORKS.

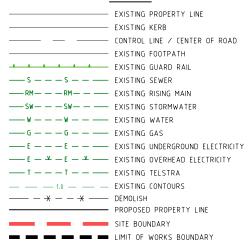LEGEND



SHEET LAYOUT

DIAL BEFORE
YOU DIG

36901-ALL-020 (ABOVE)

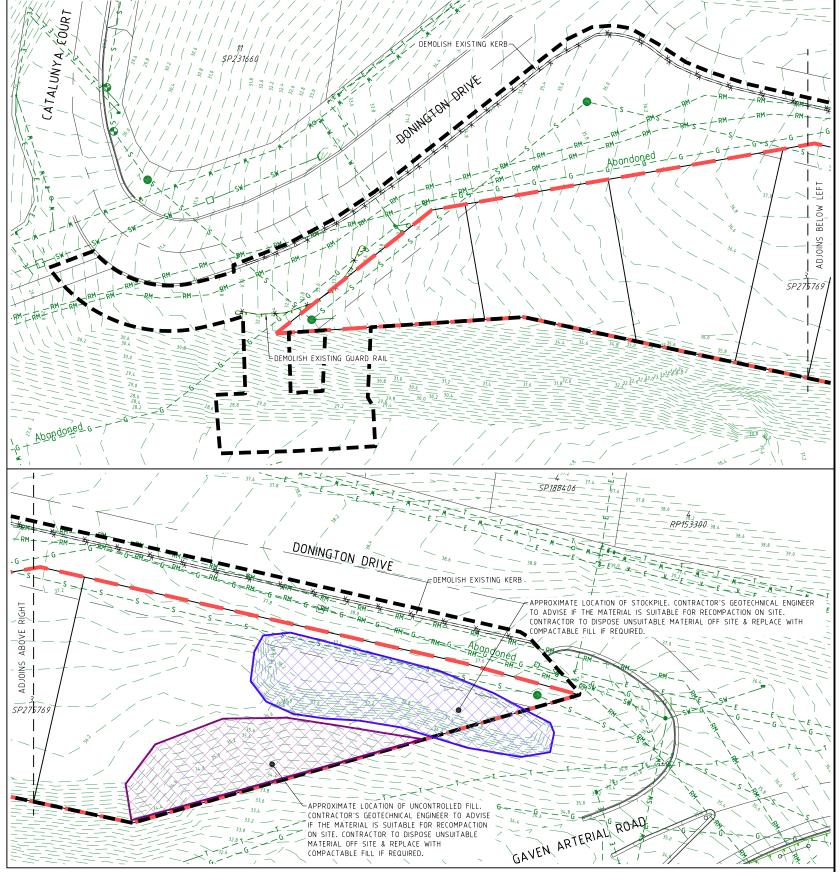
36901-ALL-020 (BELOW)

> PLANS AND DOCUMENTS referred to in the **DEVELOPMENT APPROVAL**

Application No: OPW/2019/1241

Dated:28 October 2019

Development shall comply with the conditions of approval as detailed in the Decision Notice and Council's Planning Scheme, Local Laws and Planning Policies



COMPACTABLE FILL IF REQUIRED.

PROJECT NAME

DONINGTON DRIVE RESIDENTIAL

CIVILWORKS

RP DESCRIPTION Lot 3 on SP275769 DONINGTON DRIVE
LOCALITY OF OXENFORD
LOCAL AUTHORITY - CITY OF GOLD COAST

CLIENT

TELLURIUM GG Pty Ltd



- 1	ISSUES			DAT	E	
TEND	TENDER					
COUN	CIL			26-08-19		
CONS	TRUCTION					
Α	26-08-19	COUNCIL IS	SUE			
PRE	DATE			AMEN	DMENT	

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ASSOCIATED CONSULTANTS



DRAWING TITLE

EXISTING FEATURES AND DEMOLITION PLAN SHEET 01



MUS Pty Ltd T/As: Mortons-Urban Solutions ABN: 39 116 375 065 nortons@urbansolutions.net.au www.urbansolutions.net.au Tel 07 5571 1099

Gold Coast Offic Suite 9, 19 Short S Southport QLD 421

APPROVEDALK MONTO RPEQ 4706 DATE 06-08-19

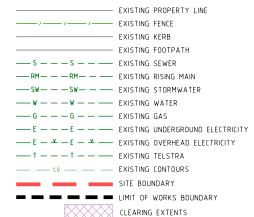
ALL VEGETATION CLEARING AND PROTECTION TO BE PERFORMED IN ACCORDANCE WITH THE APPROVED VEGETATION MANAGEMENT PLAN AND COUNCIL'S APPROVAL CONDITIONS.

VEGETATION CLEARING & PRESERVATION

- 1. PRECAUTIONS SHOULD BE TAKEN TO ENSURE PROPOSED ACTIVITIES ARE OUTSIDE THE PROTECTED ZONE.
- 2. DO NOT PLACE SOIL OR FILL FROM EXCAVATIONS AGAINST TREE TRUNKS OR ON ROOTS ATTACHED TO THE PARENT PLANT, EVEN FOR SHORT PERIODS.

 3. DO NOT DE-BARK OR IMPACT ANY TREE TRUNK, ATTACH ANY STAYS, GUYS, WIRES ETC
- 3. DO NOT DE-BARK OR IMPACT ANY TREE TRUNK, ATTACH ANY STAYS, GUYS, WIRES E TO TREES WITHIN THE PROTECTED ZONE.
- 4. ENSURE THAT THERE IS NO REMOVAL OF TOPSOIL FROM WITHIN THE "TREE PROTECTION ZONE" (TPZ) UNLESS OTHERWISE APPROVED BY A SUITABLY QUALIFIED VEGETATION ARBORIST.
- ENSURE THAT THERE IS NO PARKING OF VEHICLES OR HEAVY MACHINERY WITHIN THE TPZ OR BUFFER AREA (IF DIRECTED BY PROJECT ARBORIST) TO THE TPZ.
- THE CONSTRUCTION CONTRACTOR IS NOT TO UNDERTAKE ANY PRUNING OF TREES. TREE MANAGEMENT IS TO BE UNDERTAKEN BY A SUITABLY QUALIFIED ARBORIST.
- NO CLEARING OF PROTECTED SIZE VEGETATION IS TO OCCUR WITHOUT APPROVAL FROM THE RELEVANT AUTHORITY.

<u>LEGEND</u>



VOU DIG

PLANS AND DOCUMENTS referred to in the DEVELOPMENT APPROVAL

Application No: OPW/2019/1241

Dated: 28 October 2019

Development shall comply with the conditions of approval as detailed in the Decision Notice and Council's Planning Scheme, Local Laws and Planning Policies

PROJECT NAME

DONINGTON DRIVE RESIDENTIAL

CIVILWORKS

R P D E S C R I P T I O N Lot 3 on SP275769 DONINGTON DRIVE LOCALITY OF OXENFORD LOCAL AUTHORITY - CITY OF GOLD COAST

CLIENT

TELLURIUM GG Pty Ltd



0 3 6 9 12 15m Scale 1:300 - A1 (1:600 - A3)

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A S S O C I A T E D C O N S U L T A N T S



DRAWING TITLE

TREE CLEARING AND PRESERVATION PLAN SHEET 01



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mortons@urbansolutions.net.au
www.urbansolutions.net.au
Tel 07 5571 1099

PO Box 2484 outhport QLD 4215

Gold Coast Office Suite 9, 19 Short St Southport QLD 4215

IGNED RB DRAWN EP

EARTHWORKS LEVELS EARTHWORKS LEVELS SHOWN ON DRAWINGS ARE TO FINISHED SURFACE LEVELS & INCLUDE 100mm

COMPACTION STANDARD

SITE FILLING & TRENCH BACKFILL SHALL BE COMPACTED TO THE STANDARDS OUTLINED IN THE LOCAL AUTHORITY'S SPECIFICATIONS. FILL BATTER FACES ARE TO BE OVERFILLED, COMPACTED & CUT BACK TO DESIGN LEVELS. ALL CUT BATTERS ARE TO BE CUT BACK & TRIMMED TO DESIGN

PAVEMENT DEPTHS

THE DESIGN PAVEMENT DEPTHS ALLOWED IN EARTHWORKS CALCULATIONS ARE BASED ON THE DEPTHS SHOWN IN THE SCHEDULE OF PAVEMENT DEPTHS. THE PAVEMENT DEPTHS GIVEN ARE DESIGN DEPTHS ONLY & MAY BE VARIED AFTER SUB GRADE TESTS ARE TAKEN & AUTHORITY

TESTING & CERTIFICATION

ALL COMPACTION TESTING SHALL BE CARRIED OUT BY AN APPROVED N.A.T.A. TESTING AUTHORITY. ALL SITE FILLING SHALL BE TESTED AT LEVEL 1 REQUIREMENTS. THE CONTRACTOR IS TO PROVIDE ALL REQUIRED EARTHWORKS CERTIFICATIONS IN ACCORDANCE WITH THE APPROVAL CONDITIONS. THE CONTRACTOR IS TO PROVIDE A CONSTRUCTED EARTHWORKS SLOPE STABILITY CERTIFICATION CONFIRMING REQUIRED F.O.S. CERTIFIED BY A RPEQ.

TOPSOIL REPLACEMENT

ALL FOOTPATHS, BATTERS & ALLOTMENT CUT & FILL AREAS SHALL BE TOPSOILED WITH TOPSOIL FROM ONSITE STOCKPILES, & AMELIORATE SOIL AS NECESSARY TO ENSURE GRASS STRIKE. GRASSING

ALL CUT/FILL AREAS, DISTURBED AREAS & TRENCHED AREAS SHALL BE GRASSED TO THE SATISFACTION OF THE SUPERINTENDENT & LOCAL AUTHORITY.

ROCK

THE CONTRACTOR IS TO INCLUDE ROCK EXCAVATION AS PART OF THEIR EARTHWORKS RATE. EARTHWORKS ZONE

THE FOLLOWING ACTIVITIES ARE PROHIBITED OUTSIDE THE EARTHWORKS ZONE - STORAGE & MIXING OF MATERIALS, VEHICLE PARKING, LIQUID DISPOSAL, MACHINERY REPAIRS/REFUELING, PLACEMENT OF SITE OFFICES OR SHEDS. COMBUSTION OF ANY MATERIAL. STOCKPILING OF SOIL. RUBBLE OR DEBRIS ANY FILLING OR EXCAVATION INCLUDING TRENCHES, TOPSOIL, SKIMMING AND/OR SURFACE EXCAVATION UNLESS OTHERWISE APPROVED BY THE RELEVANT AUTHORITY.

10. CONSTRUCTION - STOCKPILING

TEMPORARY SILT FENCE TO BE ERECTED 5m FROM TOE OF BATTER ON LOW SIDE OF STOCKPILING. STOCKPILE SITE TO BE CLEAR OF ADJACENT PROPERTY BOUNDARIES SO AS NOT TO CAUSE A NUISANCE TO ADJOINING PROPERTIES. NO STOCKPILES ARE TO BE LOCATED WITHIN THE TREE PROTECTION ZONE, REFER VEGETATION MANAGEMENT PLAN FOR MORE DETAILS. THE CONTRACTOR SHALL NOT (REATE STOCKPILES OF SURPLUS MATERIALS UNLESS DIRECTED BY THE SUPERINTENDENT. ALL MATERIALS ARISING FROM THE WORKS SHALL BE COMPACTED TO FUTURE FILL AREAS AS NOMINATED OR REMOVED FROM THE SITE.

11. TOPSOIL SCREENING

TOPSOIL SHALL BE SCREENED BY THE CONTRACTOR WHEN DIRECTED BY THE SUPERINTENDENT. ALL UNSUITABLE MATERIAL SCREENED FROM THE TOPSOIL WILL BE TAKEN TO AN OFFSITE TIP BY THE CONTRACTOR AT THE CONTRACTORS EXPENSE.

12. EARTHWORKS MATERIAL SIZE

ALL EARTHWORKS MATERIAL IS TO BE BROKEN DOWN TO AN ACCEPTABLE SIZE TO BE COMPACTED UNDER LEVEL 1 FILL. WHERE THE RELEVANT GUIDELINES DON'T SPECIFY AN ACCEPTABLE SIZE, EARTHWORKS MATERIAL IS TO BE BROKEN DOWN TO A SIZE NO LARGER THAN 75mm.

13. MOISTURE CONTENT FARTHWORKS MOISTURF VARIATION TO NOT FXCFFD +2% OF THE OPTIMUM MOISTURF CONTENT.

14. SURFACE FINISH

THE FINISHED SURFACE LEVEL IS TO BE CAPPED WITH FINER MATERIAL & SMOOTH DRUM ROLLED & GRADED TO PROMOTE SURFACE WATER RUNOFF IN A CONTROLLED MANNER

15. EARTHWORKS LIMITS

THE CONTRACTOR IS TO TIE IN TO THE NATURAL SURFACE AT THE LIMIT OF THE EARTHWORKS. THE TIE IN IS TO BE COMPLETED IN A MANNER TO ENSURE THERE IS NO PONDING OF SURFACE

16. IMPORTED MATERIAL LOTS - ALL IMPORTED MATERIAL FOR PLACEMENT ON LOTS TO BE A MINIMUM CBR 10 MATERIAL &

HAVE A SWELL % <1.5.
ROADS - ALL IMPORTED MATERIAL FOR PLACEMENT ON ROADS TO BE A MINIMUM (BR10 MATERIAL

WITH A SWELL % <1.5, LIQUID LIMIT <70 & PLASTICITY IDEX <45.
SOIL PARAMETERS TO BE REVIEWED BY THE SITE GEOTECHNICAL ENGINEER PRIOR TO PLACEMENT ON

a) ALL REACTIVE TOPSOIL TO BE IDENTIFIED BY THE GEOTECHNICAL ENGINEER & BE SEPARATED FROM THE NON REACTIVE TOPSOIL.

IN THE NOW REALTIVE TOPSOIL.

B) ALL REACTIVE TOPSOIL TO BE RESPREAD IN THE OPEN SPACE AREA. WHERE REACTIVE TOPSOIL IS REQUIRED TO BE RESPREAD ON DEVELOPABLE AREAS THE CONTRACTOR SHALL LIME TREAT THE

TOPSOIL TO THE SATISFACTION OF THE GEOTECHNICAL ENGINEER.
c) WHEN UNDERTAKING THE EARTHWORKS CUT ALL MATERIALS SHOULD BE SELECTIVELY SORTED SO THAT THE REACTIVE SOILS ARE SEPARATED FROM THE LOW REACTIVE RESIDUAL SOILS & XW

d) ALL REACTIVE SOILS ARE TO BE PLACED IN THE LOWER SECTIONS OF FILL WITH THE LESS REACTIVE RESIDUAL SOILS & XW BEDROCK TO BE PLACE IN THE UPPER FILLS. ALTERNATIVELY, THE REACTIVE SOILS CAN BE BLENDED WITH THE LESS REACTIVE SOILS & XW ROCK TO THE SATISFACTION OF THE GEOTECHNICAL ENGINEER

e) NO REACTIVE CLAY SOILS SHOULD BE PLACED WITHIN THE UPPER 0.75M APPROX. FILL PROFILE WHERE POSSIBLE.

) WHEN PLACING FILL OVER HIGHLY REACTIVE SOILS, TREATMENT MAY BE REQUIRED IF THE FILLS ARE ONLY MINOR, 0.3m APPROX. & THE REACTIVE SOIL PROFILE IS GREATER THAN 0.7m APPROX. IN THESE AREAS SUBGRADE REPLACEMENT OF AT LEAST 0.75m OF NON REACTIVE / LOW REACTIVE MATERIAL OVERLYING THE REACTIVE SOILS SHALL BE UNDERTAKEN.

g) ALL WORKS ASSOCIATED WITH THE IDENTIFICATION, PLACEMENT & TREATMENT OF REACTIVE SOILS SHALL BE UNDERTAKEN TO THE SATISFACTION OF THE GEOTECHNICAL ENGINEER.

LEGEND

SITE BOUNDARY

— — -0.5 — — CUT CONTOUR

— 0.5 —

EXISTING PROPERTY LINE

EXISTING KERB (INVERT)

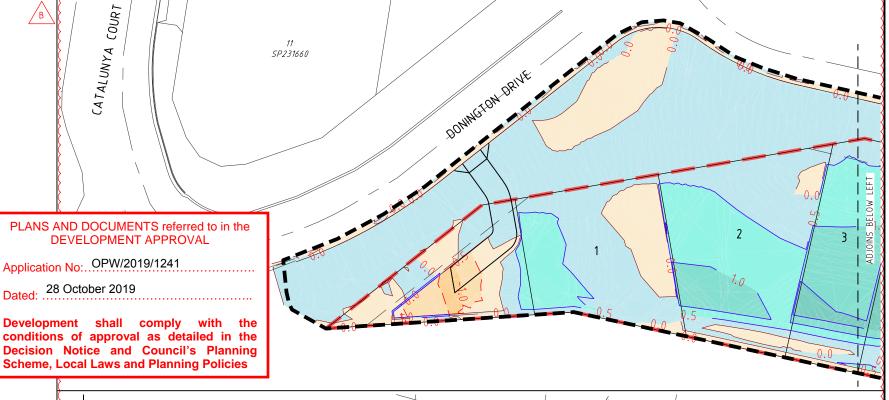
■ ■ LIMIT OF EARTHWORKS BOUNDARY

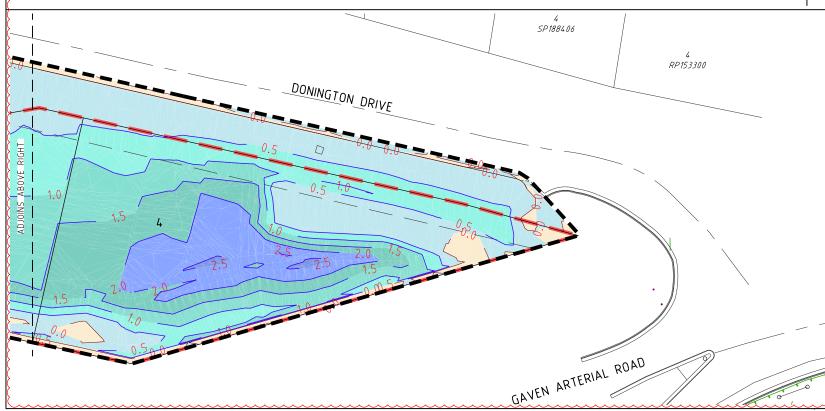
PROPOSED PROPERTY LINE

PROPOSED KERB (INVERT)

— INTERFACE CONTOUR

FILL CONTOUR





NOTE:

0.0 - 0.5m

0.5 - 1.0m

1.0 - 1.5m

1.5 - 2.0m

2.0 - 2.5m

2.5 - 3.0m

3.0 - 3.5m

3.5 - 4.0m

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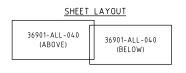
1.0 - 1.5m

0.5 - 1.0m

0.0 - 0.5m

BULK FARTHWORKS (EXISTING TO FINISHED SURFACE)

CONTRACTOR TO MAKE ALL NECESSARY ALLOWANCES FOR EXISTING SERVICES DURING ALL WORKS.



NOTES:

EARTHWORKS VOLUMES ARE APPROXIMATE ONLY, CONTRACTOR TO VERIFY & ALLOW FOR ANY DISCREPANCY IN THE CONTRACT VALUE.

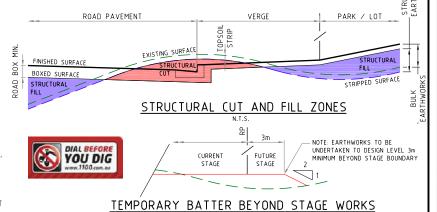
VOLUMES INDICATE THE STRUCTURAL QUANTITY OF EARTHWORKS, IE BETWEEN THE EXISTING SURFACE & THE

UNDERSIDE OF THE MINIMUM BOX & OF THE FSL, AS PROSCRIBED IN THE CONTRACT DOCUMENTATION. NO ALLOWANCE FOR COMPACTION OR BULKING FACTOR IS INCLUDED IN THE EARTHWORKS VOLUMES. THE

CONTRACTOR IS TO MAKE ALLOWANCES FOR BULKING/COMPACTION AS PART OF THEIR CONTRACT WORKS. THE CONTRACTOR IS TO VERIFY EXISTING SURFACE & TOPSOIL DISTRIBUTION PRIOR TO SIGNING THE CONTRACT. THE CONTRACTORS PRICE FOR THESE WORKS IS DEEMED TO BE ACCEPTING OF THE NATURAL SURFACE &

TOPSOIL DISTRIBUTION. THE CONTRACTOR IS REQUIRED TO EXPORT / IMPORT AS NEEDED TO ACHIEVE THE FINAL SURFACE LEVELS THE EXPORT/IMPORT AS REQUIRED TO COMPLETE EARTHWORKS FORMS PART OF THE CONTRACT WORKS.

WHERE NO SPOIL AREA IS AVAILABLE WITHIN THE PROJECT FOOTPRINT, THE CIVIL CONTRACTOR SHALL EXPORT EXCESS MATERIALS TO A LICENCED TIP OFF SITE. THESE WORKS FORM PART OF THE CONTRACT WORKS.



PROJECT NAME

DONINGTON DRIVE RESIDENTIAL

CIVILWORKS

RP DESCRIPTION Lot 3 on SP275769 DONINGTON DRIVE LOCALITY OF OXENFORD LOCAL AUTHORITY - CITY OF GOLD COAST

TELLURIUM GG Pty Ltd



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EARTHWORKS CUT TO FILL PLAN SHEET 01

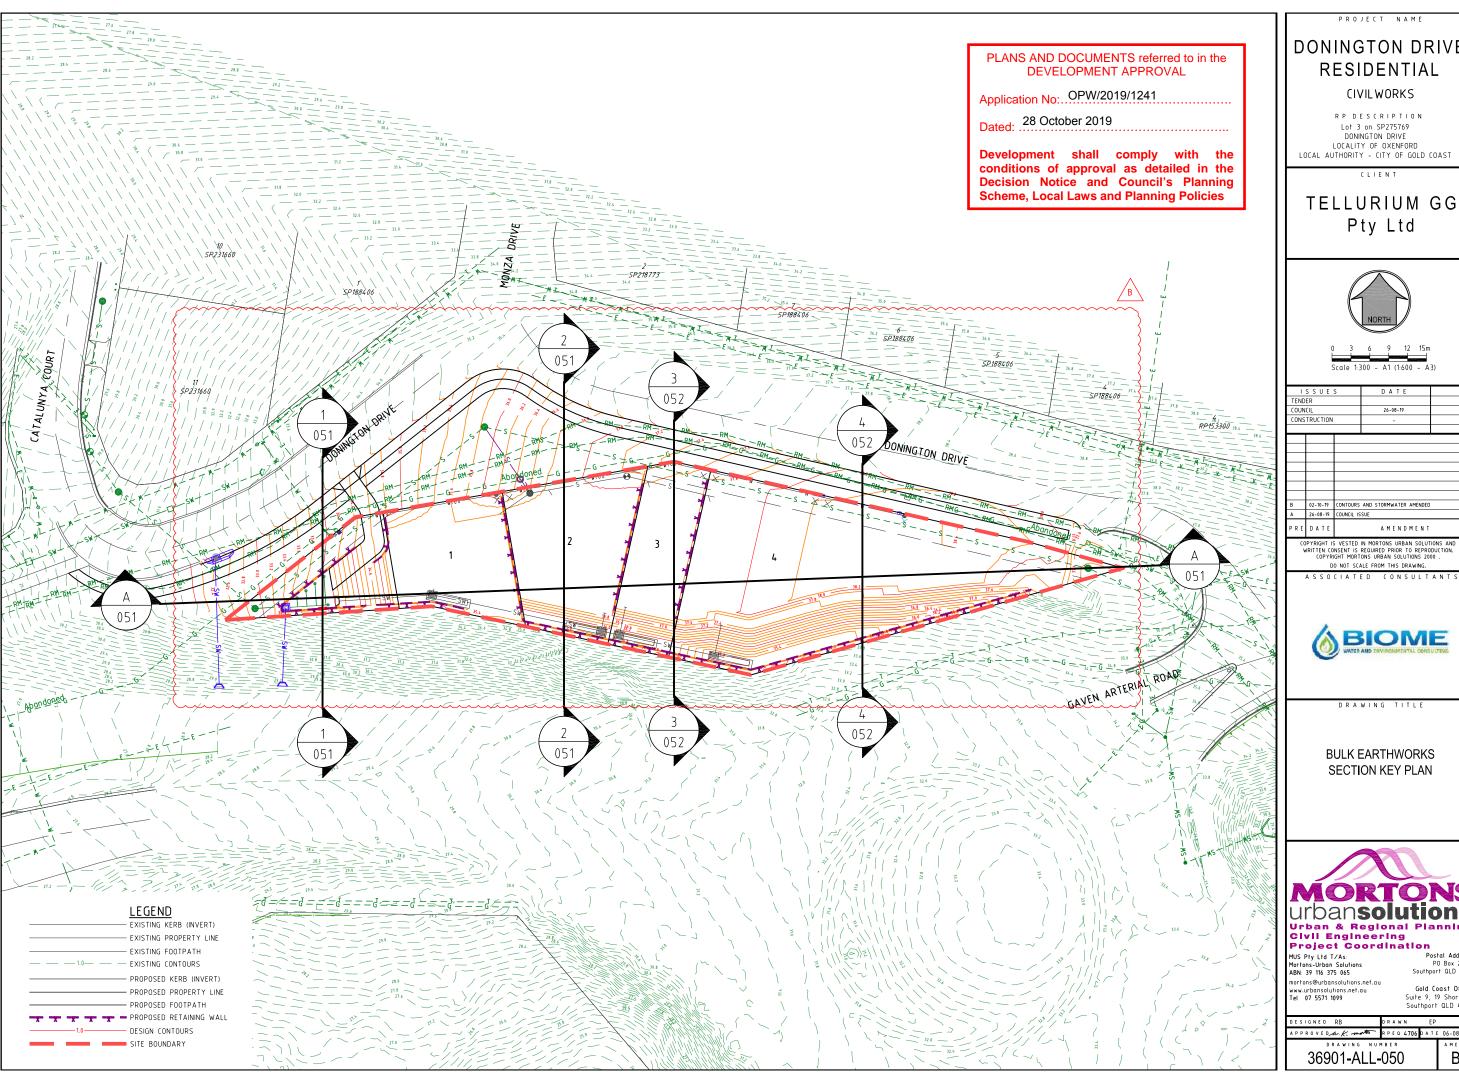


MUS Pty Ltd T/As: Mortons-Urban Solutions ABN: 39 116 375 065 rtons@urbansolutions.net.au 07 5571 1099

Gold Coast Offic

Southport QLD 421 DESIGNED RB DRAWN RPEQ 4706 DATE 06-08-19

36901-ALL-040



DONINGTON DRIVE RESIDENTIAL

TELLURIUM GG

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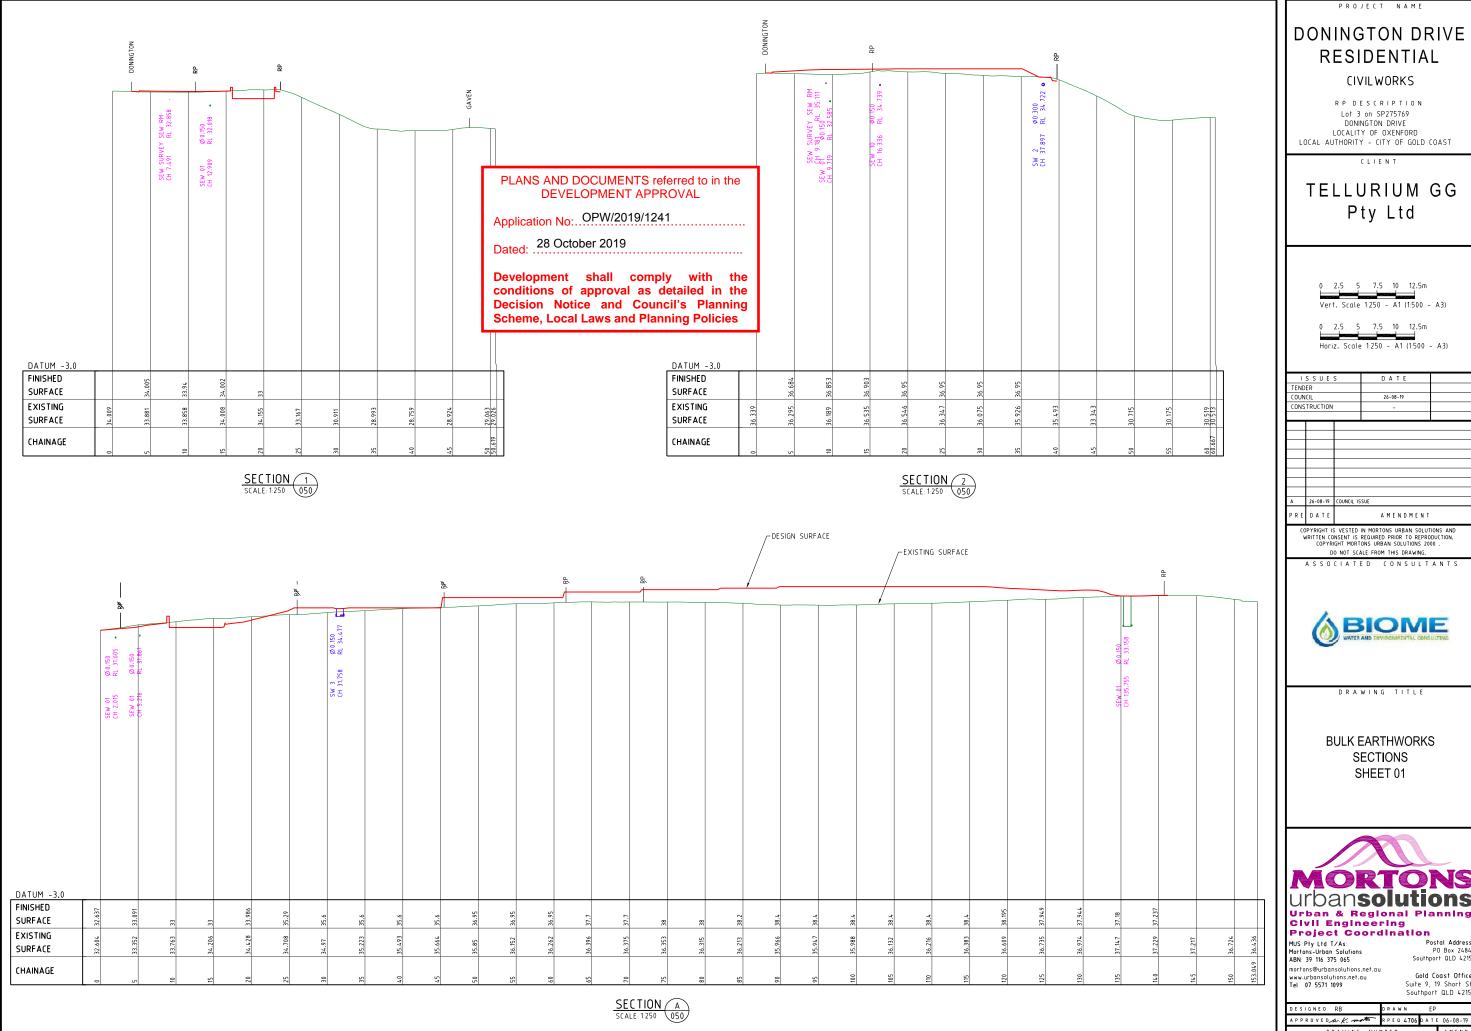
DRAWING TITLE

BULK EARTHWORKS SECTION KEY PLAN



Postal Addres Gold Coast Office

Suite 9, 19 Short S Southport QLD 4219



DONINGTON DRIVE RESIDENTIAL

CIVILWORKS

RP DESCRIPTION Lot 3 on SP275769 DONINGTON DRIVE
LOCALITY OF OXENFORD
LOCAL AUTHORITY - CITY OF GOLD COAST

CLIENT

TELLURIUM GG Pty Ltd

Vert. Scale 1:250 - A1 (1:500 - A3)

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Gold Coast Office

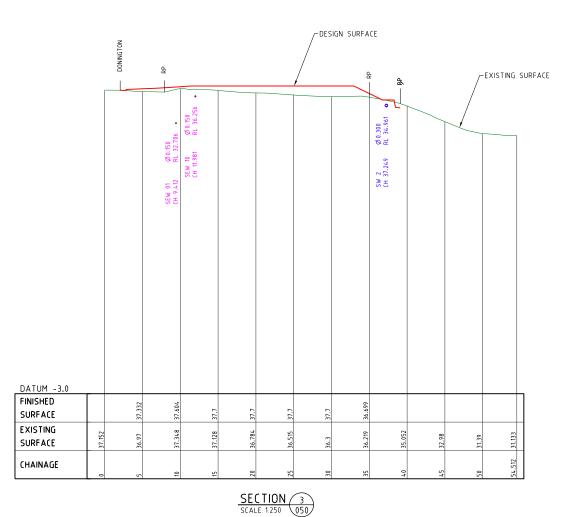
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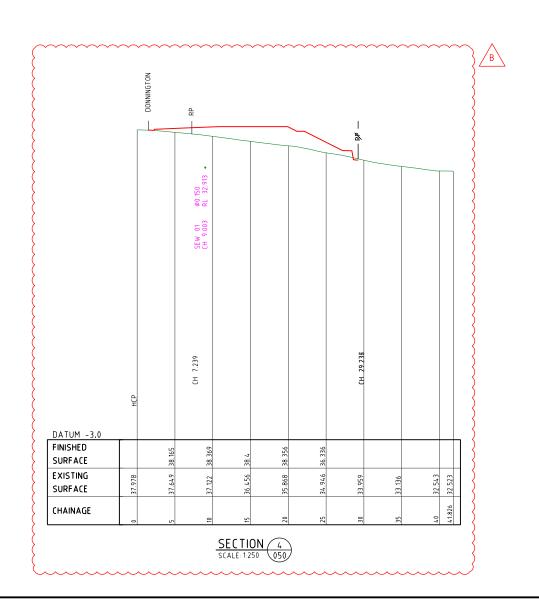
Suite 9, 19 Short S Southport QLD 4219 DRAWN DESIGNED RB

Application No: OPW/2019/1241

Dated: 28 October 2019

Development shall comply with the conditions of approval as detailed in the **Decision Notice and Council's Planning** Scheme, Local Laws and Planning Policies





PROJECT NAME

DONINGTON DRIVE RESIDENTIAL

CIVILWORKS

RP DESCRIPTION Lot 3 on SP275769 DONINGTON DRIVE
LOCALITY OF OXENFORD
LOCAL AUTHORITY - CITY OF GOLD COAST

TELLURIUM GG Pty Ltd

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BULK EARTHWORKS SECTIONS SHEET 02



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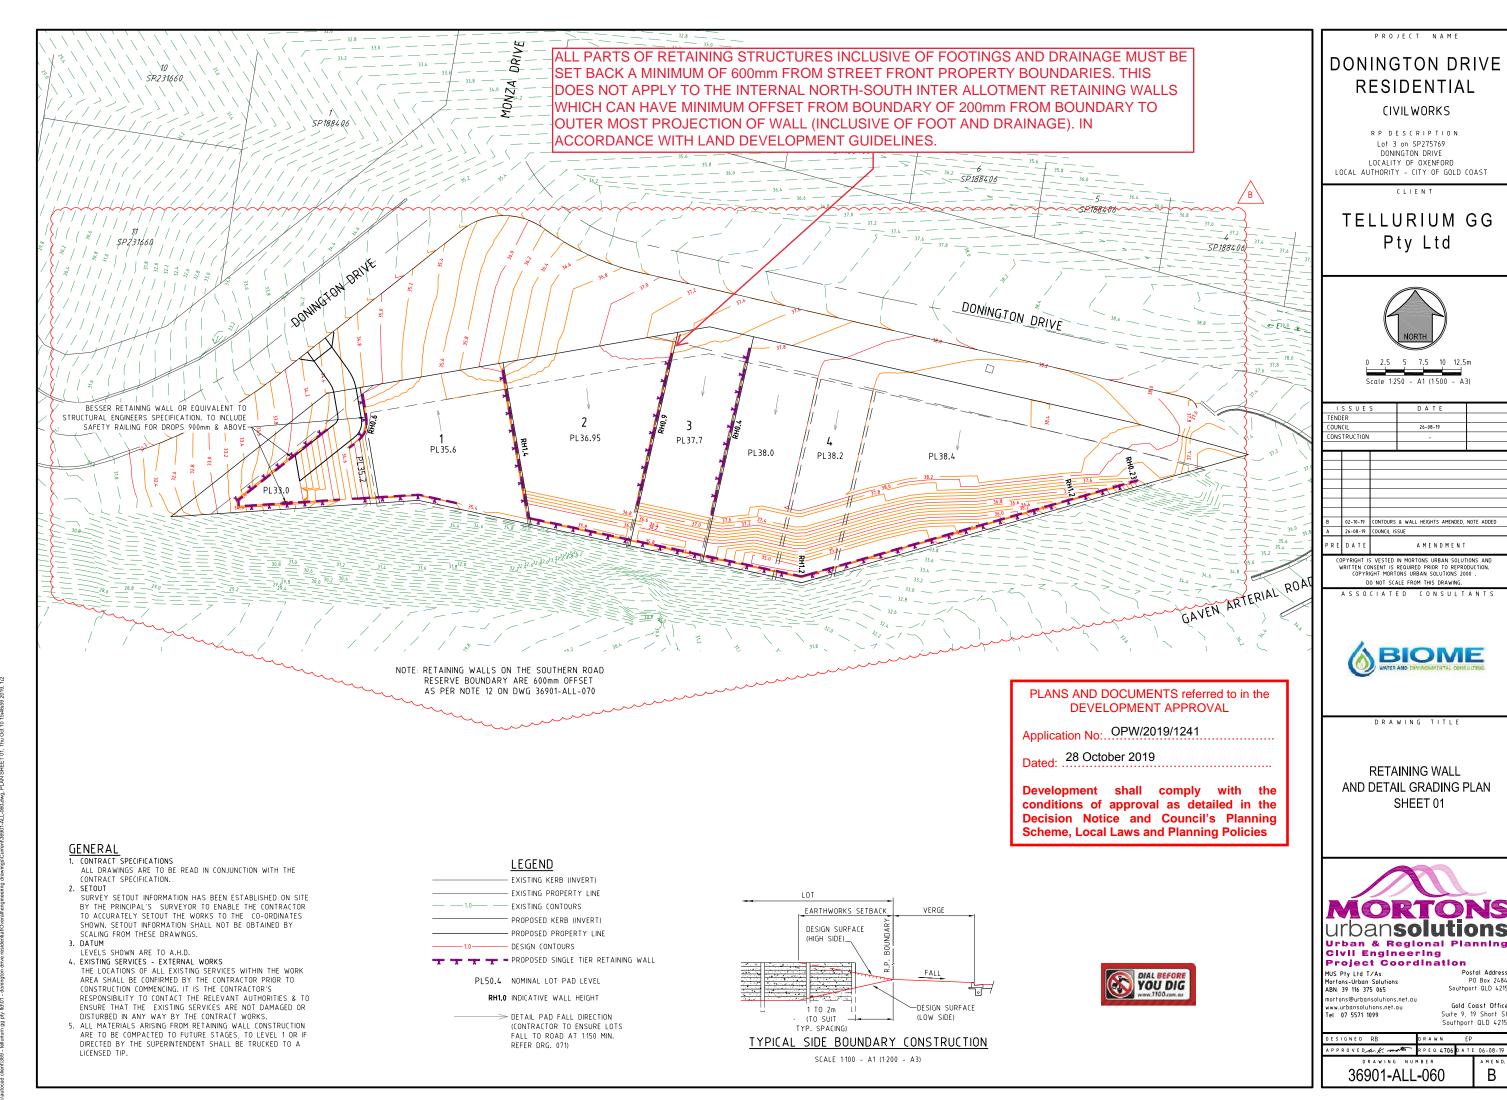
mortons@urbansolutions.net.au www.urbansolutions.net.au Tel 07 5571 1099

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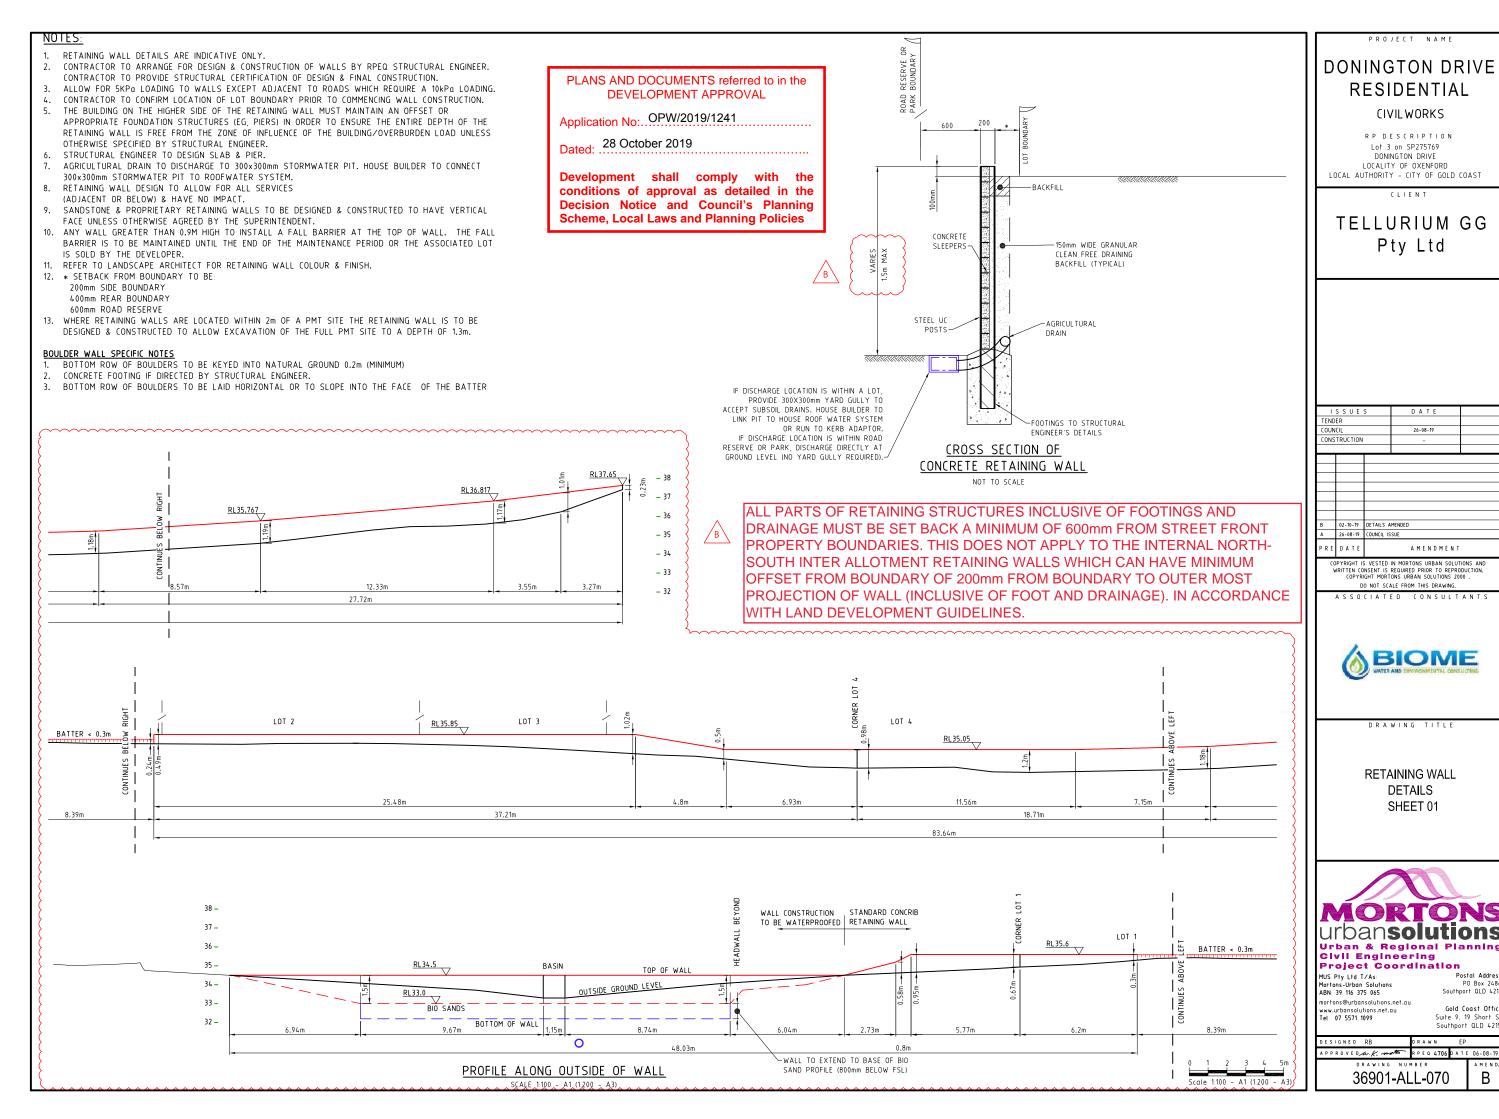
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Gold Coast Office Suite 9, 19 Short St Southport QLD 4215

APPROVEDA.K. MOTO RPEQ 4706 DATE 06-08-19



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PLANS AND DOCUMENTS referred to in the DEVELOPMENT APPROVAL

Application No: OPW/2019/1241

Dated: 28 October 2019

Development shall comply with the conditions of approval as detailed in the Decision Notice and Council's Planning Scheme, Local Laws and Planning Policies

STORMWATER MANAGEMENT DEVICES INCLUDING THE BIO BASIN IS CONSIDERED INTERNAL AND PRIVATE INFRASTRUCTURE AND IS TO BE OWNED AND MAINTAINED PRIVATELY.

PROJECT NAME

DONINGTON DRIVE RESIDENTIAL

CIVILWORKS

R P D E S C R I P T I O N

Lot 3 on SP275769

DONINGTON DRIVE

LOCALITY OF OXENFORD

LOCAL AUTHORITY - CITY OF GOLD COAST

CLIENT

TELLURIUM GG Pty Ltd

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FINAL TRIM DETAILS SHEET 01



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Tel 07 5571 1099

Postal Address PO Box 2484 Southport QLD 4215

Gold Coast Office Suite 9, 19 Short St Southport QLD 4215

DESIGNED RB DRAWN EP
APPROVEDANK NATO RPEG 4706 DATE 06-08-19

36901-ALL-071

Α

b. State Planning Policy Prescribed water contaminants (as defined in the environmental protection act 1994) MUST NOT BE RELEASED FROM THE SITE OR TO WATERS WITHIN THE SITE, OR BE LIKELY TO BE RELEASED SHOULD RAINFALL OCCUR. UNLESS ALL REASONABLE & PRACTICABLE MEASURES ARE TAKEN TO PREVENT OR MINIMISE THE RELEASE & CONCENTRATION OF CONTAMINATION. THE ESC PLAN MUST BE DESIGNED IMPLEMENTED & MAINTAINED IN ACCORDANCE WITH "BEST PRACTICE EROSION & SEDIMENT CONTROL" PUBLISHED BY THE INTERNATIONAL EROSION CONTROL ASSOCIATION (AUSTRALASIAN CHAPTER) (IECA 2008).

TO COMPLY WITH THE REQUIREMENTS OF THE EP ACT & BEST PRACTICE DESIGN, THE SEDIMENT BASINS ON THE SITE MUST BE DESIGNED & IMPLEMENTED TO ACHIEVE THE FOLLOWING:

SEDIMENT BASINS ARE TO BE DESIGNED, IMPLEMENTED & MAINTAINED TO A STANDARD WHICH WOULD ACHIEVE AT LEAST 80% OF THE AVERAGE ANNUAL RUNOFF VOLUME OF THE CONTRIBUTING CATCHMENT TREATED (I.E. 80% HYDROLOGIC EFFECTIVENESS) TO 50MG/L TSS

OR LESS & PH IN THE RANGE 6.5-8.5
THIS WILL REQUIRE THE INSTALLATION & OPERATION OF A HIGH-EFFICIENCY SEDIMENT BASINIS) DESIGNED IN ACCORDANCE WITH THE SPECIFICATIONS CONTAINED IN THE "BEST PRACTICE EROSION & SEDIMENT CONTROL - APPENDIX B SEDIMENT BASIN DESIGN & OPERATION" PUBLISHED BY THE INTERNATIONAL EROSION CONTROL ASSOCIATION (AUSTRALASIAN CHAPTER) (IECA, 2016, DRAFT) THE EROSION & SEDIMENT CONTROL PLAN MUST BE PREPARED & CERTIFIED BY A CERTIFIED

PROFESSIONAL IN EROSION & SEDIMENT CONTROL & FOLLOW THE REQUIREMENTS OUTLINED IN IECA'S BEST PRACTICE EROSION & SEDIMENT CONTROL DOCUMENT & THE QUEENSLAND URBAN DRAINAGE MANUAL.

PRIOR TO THE COMMENCEMENT OF WORKS ONSITE THE CONTRACTOR MUST MAKE THEMSELVES AWARE OF ALL PREVIOUS GEOTECHNICAL REPORTS & DETERMINE THE DISPERSIVE CHARACTERISTICS OF THE SOIL (INCLUDING PERFORMING ANY SOIL TESTS IF REQUIRED). THE RESULTS OF THIS REVIEW & ANY TESTS MUST BE INCLUDED IN THE CONTRACTOR'S EROSION & SEDIMENT CONTROL PLAN. A COPY OF ALL TEST RESULTS MUST BE PROVIDED TO THE

THE CONTRACTOR SHALL TAKE ALL NECESSARY PRECAUTIONS TO CONTROL EROSION & DOWNSTREAM SEDIMENTATION DURING ALL STAGES OF CONSTRUCTION (INCLUDING THE MAINTENANCE PERIOD). NOTWITHSTANDING THE CONTROL MEASURES OR FINISHED EARTHWORKS DESIGN SHOWN ON THESE DRAWINGS, THE CONTRACTOR IS RESPONSIBLE FOR IMPLEMENTING ADDITIONAL OR ALTERNATIVE EROSION & SEDIMENT CONTROL MEASURES TO MINIMISE SEDIMENT ACROSS OR LEAVING THE SITE.

AT ALL TIMES THE CONTRACTOR SHALL MONITOR THE PREVAILING WEATHER CONDITIONS (INCLUDING WEEKENDS & PUBLIC HOLIDAYS) & AT ALL TIMES REMAINS RESPONSIBLE TO: CLEAN & REPAIR CONTROL DEVICES WHENEVER THE ACCUMULATED SEDIMENT REDUCES THEIR

CAPACITY BY 50%. MAINTAIN POSITIVE GRADES OF ALL PERIMETER BANKS & SWALES TO AN OUTLET.

c) PROTECT ANY DOWNSTREAM CONSTRUCTION.

CONTROLLING DUST.
MEASURES HAVE BEEN INSTALLED IN ACCORDANCE WITH DETAILS OUTLINED IN THEIR EROSION & SEDIMENT CONTROL PLAN & AS DIRECTED BY THE SUPERINTENDENT.

THE CONTRACTOR'S PLAN SHALL ALLOW FOR SUITABLE ACCESS TO ALLOW MAINTFNANCE OF ALL SEDIMENT CONTROL DEVICES. NO ADDITIONAL VEGETATION CLEARING IS PERMITTED FOR GAINING ACCESS UNLESS APPROVED BY THE SUPERINTENDENT.

THE CONTRACTOR MAY REQUEST APPROVAL FROM THE SUPERINTENDENT TO REUSE THE STOCKPILED MULCH FOR STABILISING BATTERS ONLY IN LOCATIONS WHERE THE APPROVED LANDSCAPE OPW DESIGN REQUIRES MULCH ULTIMATELY.

CONSTRUCTION STOCKPILING

TOPSOIL SHALL BE STRIPPED & STOCKPILED IN LOCATIONS NOMINATED ON THE

CONSTRUCTION DRAWINGS OR IN LOCATIONS AGREED WITH THE SUPERINTENDENT.
b) ADDITIONAL VEGETATION CLEARING IS NOT PERMITTED TO FACILITATE THE STOCKPILING OF MATERIALS UNLESS SHOWN ON THE APPROVED VEGETATION MANAGEMENT PLAN.
c) ANY STOCKPILE SITE MUST BE CLEAR OF ADJACENT PROPERTY BOUNDARIES SO AS NOT TO

CAUSE A NUISANCE TO ADJOINING PROPERTIES.

d) NO STOCKPILES ARE TO BE LOCATED WITHIN THE TREE PROTECTION ZONE OF VEGETATION.

A TEMPORARY SILT FENCE IS TO BE ERECTED APPROXIMATELY 5m FROM TOE OF BATTER ON LOW SIDE OF STOCKPILING.

10. NOTWITHSTANDING THE DETAILS SHOWN IN THE CONTRACTOR'S EROSION & SEDIMENT CONTROL PLAN DURING CONSTRUCTION THE CONTRACTOR MUST-

SIZE ALL TEMPORARY SEDIMENT BASINS APPROPRIATELY TO TREAT THE UPSTREAM CATCHMENT. NOTE THAT THE PERMANENT BIO BASINS SHOWN ON THESE DRAWINGS ARE SIZED FOR THE ULTIMATE CATCHMENT NOT FOR THE CONSTRUCTION PHASE.

PLACE A ROCK BUND AROUND ALL HEADWALLS DURING CONSTRUCTION. PROVIDE KERB INLET PROTECTION TO ALL GULLIES.

c) PLACE A MINIMUM 1.0m WIDE TURF STRIP BEHIND ALL KERBS & IN A HERRINGBONE LAYOUT WITHIN THE ROAD VERGE.

d) MAINTENANCE (INCLUDING FLOCCULATION IF REQUIRED & PUMP OUT) OF ALL CONSTRUCTION SEDIMENT BASINS (WHETHER EXISTING OR NEW).

CLEAN OUT OF ALL GROSS POLLUTANT TRAPS, SEDIMENT FOREBAYS & ALL OTHER PERMANENT SEDIMENT CONTROL DEVICES AT BOTH ON & OFF MAINTENANCE.

CONTRACTOR TO CONFIRM THE EXTENTS OF REQUIRED GRASSING TREATMENTS WITH THE SUPERINTENDENT AT LEAST 7 DAYS PRIOR TO FINAL TRIMMING.

THE CONTRACTOR IS RESPONSIBLE FOR ENSURING THAT GRASSING STRIKE RATES ARE ACHIEVED AT THE ON & OFF MAINTENANCE INSPECTIONS IN ACCORDANCE WITH COUNCIL REQUIREMENTS. THIS INCLUDES THE SUPPLY & INSTALLATION OF ANY REQUIRED CHEMICAL/FERTILISER AMELIORATION TO ACHIEVE THE SPECIFIED GRASS STRIKE RATES.

GEOFABRIC LINING OF CHANNELS & CHECK DAMS MAY BE REQUIRED SUBJECT TO THE SITE CONDITIONS.

BATTERS WITHIN PUBLIC OPEN SPACE TO BE VEGETATED IN ACCORDANCE WITH APPROVED OPEN SPACE MANAGEMENT PLAN & LANDSCAPING OPW. CONTRACT DOCUMENTATION WILL SPECIFY WHETHER THIS IS THE CIVIL CONTRACTOR OR THE LANDSCAPE CONTRACTOR'S RESPONSIBILITY TO SUPPLY & INSTALL. THE CIVIL CONTRACTOR IS RESPONSIBLE FOR PROVIDING SUITABLE ACCESS FOR THE LANDSCAPE CONTRACTOR TO PERFORM THEIR WORKS.

MAINTENANCE PERIOD (PRE TO POST CONSTRUCTION)

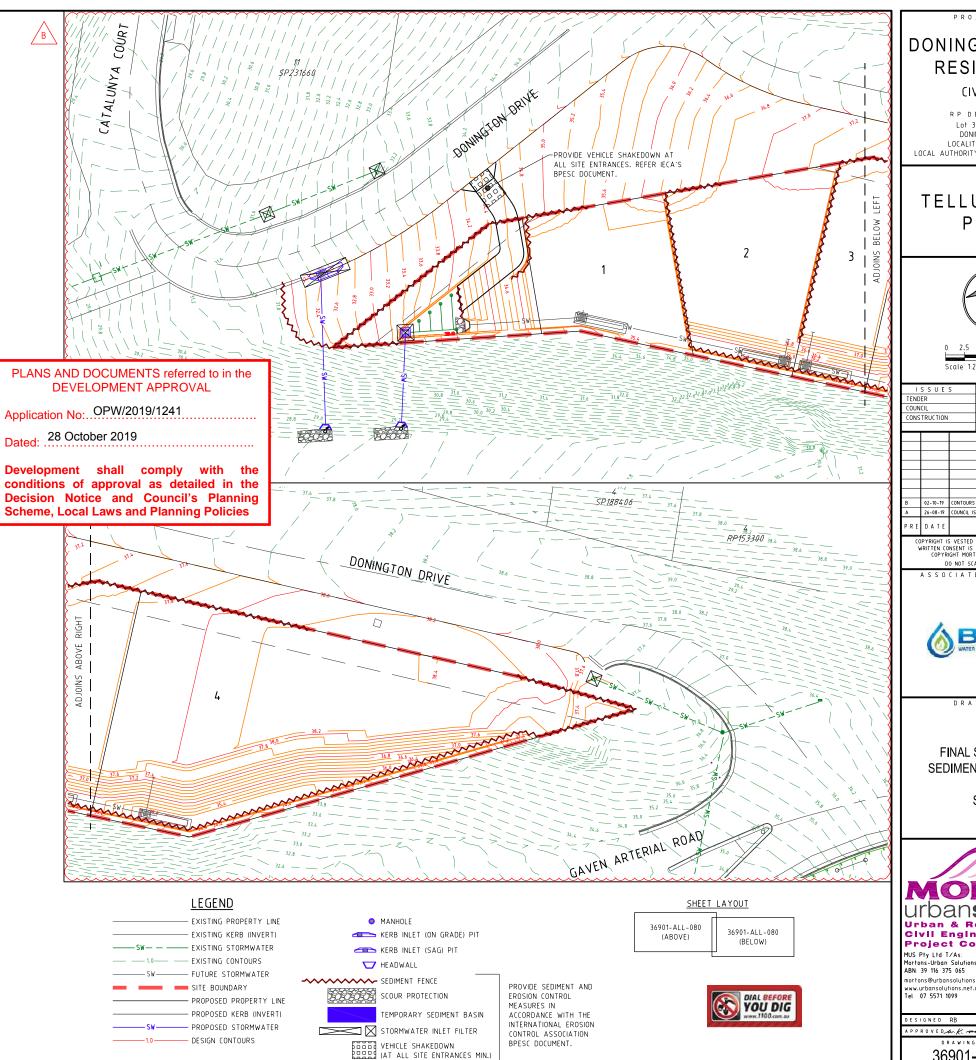
a) ALL PROTECTION MEASURES ARE TO BE INSPECTED & MAINTAINED REGULARLY

b) REPAIRS ARE TO BE EFFECTED IMMEDIATELY.
c) SILT AFTER RAIN IS TO BE CLEANED FROM STREETS & ALLOTMENTS IMMEDIATELY &

CORRECTIVE ACTION TAKEN TO AVOID A RE-OCCURRENCE. AT OFF-MAINTENANCE & ONLY WHEN DIRECTED BY COUNCIL, REMOVE & DISPOSE OFFSITE ALL TEMPORARY EROSION & SEDIMENT CONTROL DEVICES.

NOTE:

SEDIMENT AND EROSION CONTROL MEASURES SHOWN RELATE TO THE FINISHED SURFACE ONLY AND ARE CONCEPTUAL ONLY. THE CONTRACTOR IS TO PREPARE A SITE SPECIFIC CONSTRUCTION AND MAINTENANCE PHASE SEDIMENT AND EROSION CONTROL PLAN.



PROJECT NAME

DONINGTON DRIVE RESIDENTIAL

CIVILWORKS

RP DESCRIPTION Lot 3 on SP275769 DONINGTON DRIVE LOCALITY OF OXENFORD LOCAL AUTHORITY - CITY OF GOLD COAST

CLIENT

TELLURIUM GG Pty Ltd



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1	TENDER COUNCIL CONSTRUCTION		DATE	
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DRAWING TITLE

FINAL SURFACE AND SEDIMENT AND EROSION PLAN SHEET 01



MUS Pty Ltd T/As: Mortons-Urban Solutions ABN: 39 116 375 065 rtons@urbansolutions.net.au Tel 07 5571 1099

Postal Addres Gold Coast Offic

RPEQ 4706 DATE 06-08-19

Southport QLD 421 DESIGNED RB DRAWN

36901-ALL-080

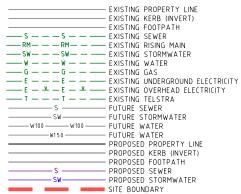
1. CONSTRUCTION OF SEWER/ROOFWATER/STORMWATER/SERVICES EXCAVATED MATERIAL TO BE PLACED ON HIGH SIDE OF TRENCH & TO PROTECT PIPE WORK & DIRECT SURFACE MATERIAL AWAY FROM EXCAVATIONS. TOPSOIL & GRASS SEED AREAS IN ALLOTMENTS IMMEDIATELY AFTER COMPLETING THE SEWER & ROOFWATER DRAINAGE CONSTRUCTION.
DEPRESS GROUND AROUND TEMPORARY FIELD
INLETS TO CREATE SILT POND.

2. TRIP HAZARD

MANHOLES OR STRUCTURES INSTALLED IN THE ROAD, FOOTPATH OR VERGE MUST MATCH NEATLY WITH NO TRIP HAZARD.

3. EXISTING SERVICES - EXTERNAL WORKS
THE LOCATIONS OF ALL EXISTING SERVICES WITHIN THE WORK AREA SHALL BE CONFIRMED BY THE CONTRACTOR PRIOR TO CONSTRUCTION COMMENCING. IT IS THE CONTRACTOR'S RESPONSIBILITY TO CONTACT THE RELEVANT AUTHORITIES & TO ENSURE THAT THE EXISTING SERVICES ARE NOT DAMAGED OR DISTURBED IN ANY WAY BY THE CONTRACT WORKS.

LEGEND



STORMWATER MANAGEMENT DEVICES INCLUDING THE BIO BASIN IS CONSIDERED INTERNAL AND PRIVATE INFRASTRUCTURE AND IS TO BE OWNED AND MAINTAINED PRIVATELY.



PLANS AND DOCUMENTS referred to in the **DEVELOPMENT APPROVAL**

Application No: OPW/2019/1241

Dated:28 October 2019

Development shall comply with the conditions of approval as detailed in the Decision Notice and Council's Planning Scheme, Local Laws and Planning Policies

VEHICULAR CROSSOVER (VXO)

The vehicular crossover (VXO) is not part of this assessment.

Where a new VXO is required, or a change to the existing VXO is necessary, a Vehicular Crossing Permit must be obtained prior to the issuing of a development permit for building work, in accordance with the requirements of Local Law 11.

PROJECT NAME

DONINGTON DRIVE RESIDENTIAL

CIVILWORKS

RP DESCRIPTION Lot 3 on SP275769 DONINGTON DRIVE
LOCALITY OF OXENFORD
LOCAL AUTHORITY - CITY OF GOLD COAST

TELLURIUM GG Pty Ltd



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DRAWING TITLE

COMBINED SERVICES PLAN SHEET 01



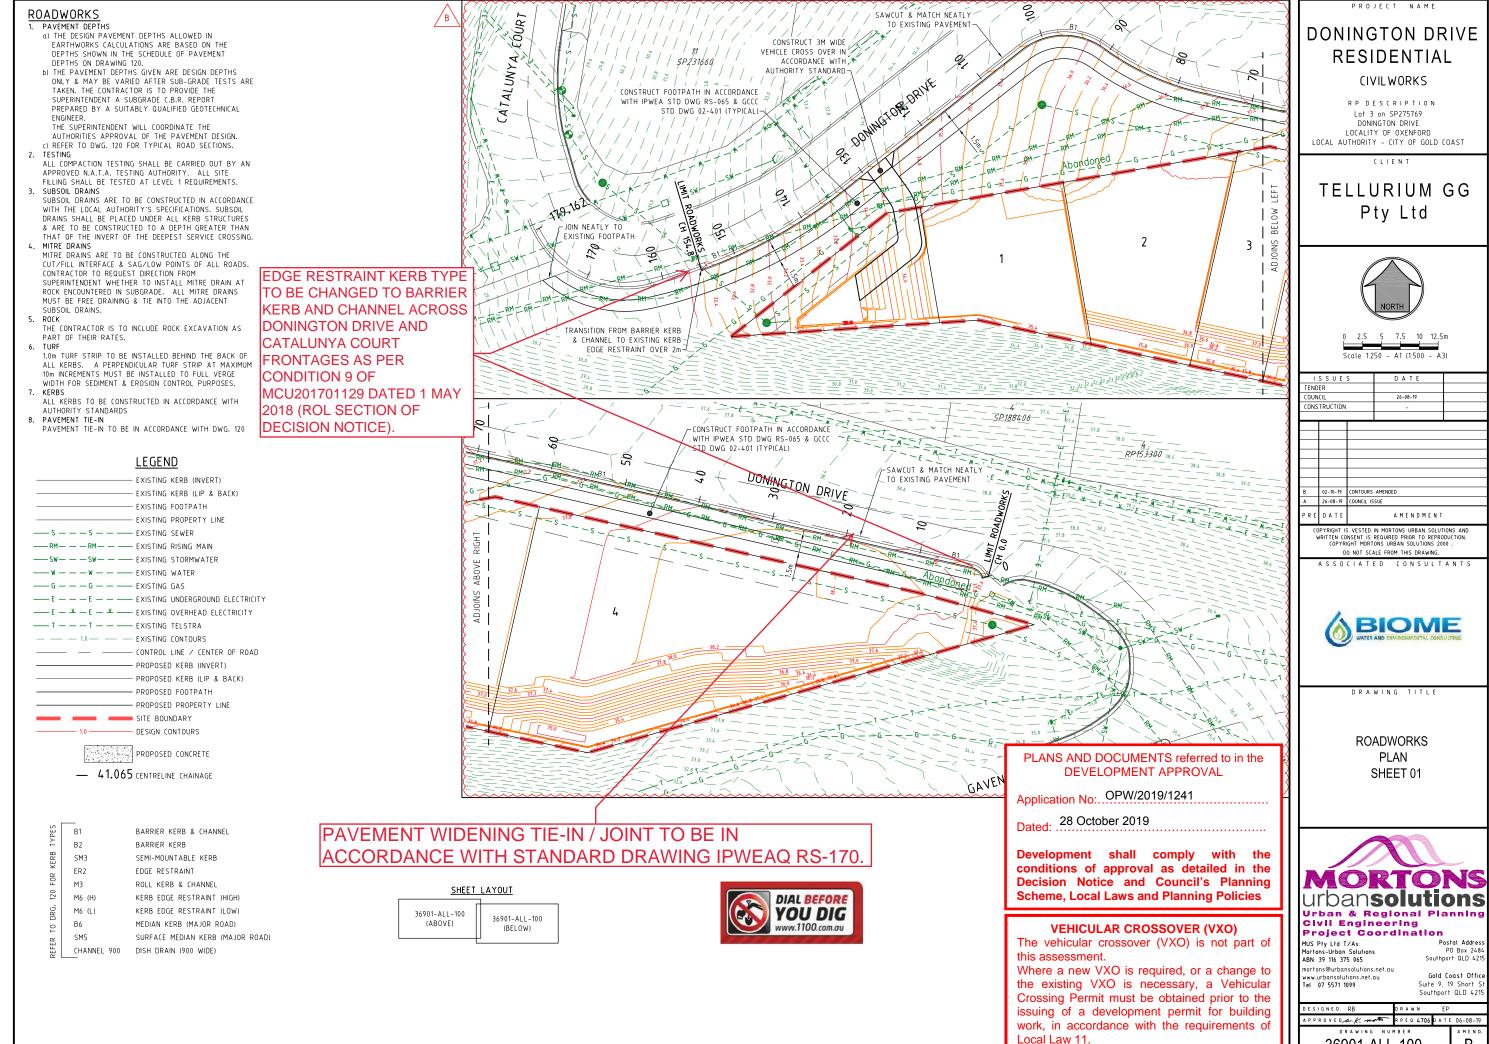
MUS Pty Ltd T/As: Mortons-Urban Solutions ABN: 39 116 375 065 rtons@urbansolutions.net.au

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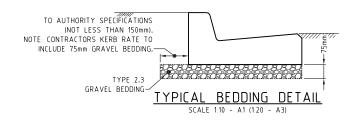
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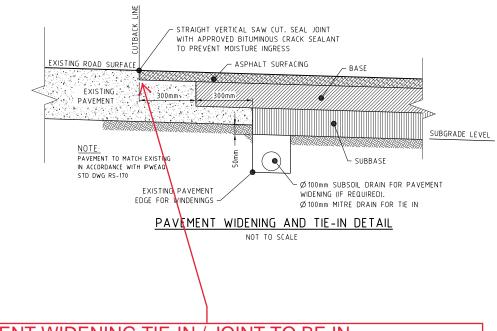
w.urbansolutions.net.au 07 5571 1099 Suite 9, 19 Short S Southport QLD 421

DESIGNED RB DRAWN APPROVEDAK MONTO RPEQ 4706 DATE 06-08-15

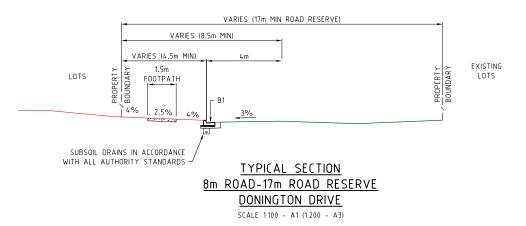


36901-ALL-100





PAVEMENT WIDENING TIE-IN / JOINT TO BE IN ACCORDANCE WITH STANDARD DRAWING IPWEAQ RS-170.



PLANS AND DOCUMENTS referred to in the **DEVELOPMENT APPROVAL**

Application No: OPW/2019/1241

Dated: 28 October 2019

Development shall comply with the conditions of approval as detailed in the **Decision Notice and Council's Planning Scheme, Local Laws and Planning Policies**

PROJECT NAME

DONINGTON DRIVE RESIDENTIAL

CIVILWORKS

RP DESCRIPTION Lot 3 on SP275769 DONINGTON DRIVE
LOCALITY OF OXENFORD
LOCAL AUTHORITY - CITY OF GOLD COAST

CLIENT

TELLURIUM GG Pty Ltd

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ASSOCIATED CONSULTANTS



DRAWING TITLE

ROADWORKS DETAILS SHEET 01



MUS Pty Ltd T/As: Mortons-Urban Solutions ABN: 39 116 375 065 mortons@urbansolutions.net.au www.urbansolutions.net.au Tel 07 5571 1099

Postal Addres Gold Coast Office

Suite 9, 19 Short S Southport QLD 4219

Α

DESIGNED RB DRAWN APPROVEDA.K. MONTO RPEQ 4706 DATE 06-08-19

PLANS AND DOCUMENTS referred to in the DEVELOPMENT APPROVAL

Application No: OPW/2019/1241

Dated: 28 October 2019

Development shall comply with the conditions of approval as detailed in the Decision Notice and Council's Planning Scheme, Local Laws and Planning Policies

CIVIL WORKS

RP DESCRIPTION
Lot 3 on SP275769

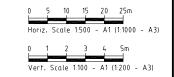
Lot 3 on SP275769 DONINGTON DRIVE LOCALITY OF OXENFORD LOCAL AUTHORITY - CITY OF GOLD COAST

PROJECT NAME

DONINGTON DRIVE RESIDENTIAL

CLIENT

TELLURIUM GG Pty Ltd



TEND	ER					
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A S S O C I A T E D C O N S U L T A N T S



DRAWING TITLE

LONGITUDINAL SECTIONS
DONONGTON DRIVE



MUS Pty Ltd T/As:
Mortons-Urban Solutions
ABN: 39 116 375 065
mortons@urbansolutions.net.au
www.urbansolutions.net.au
Tel 07 5371 1099
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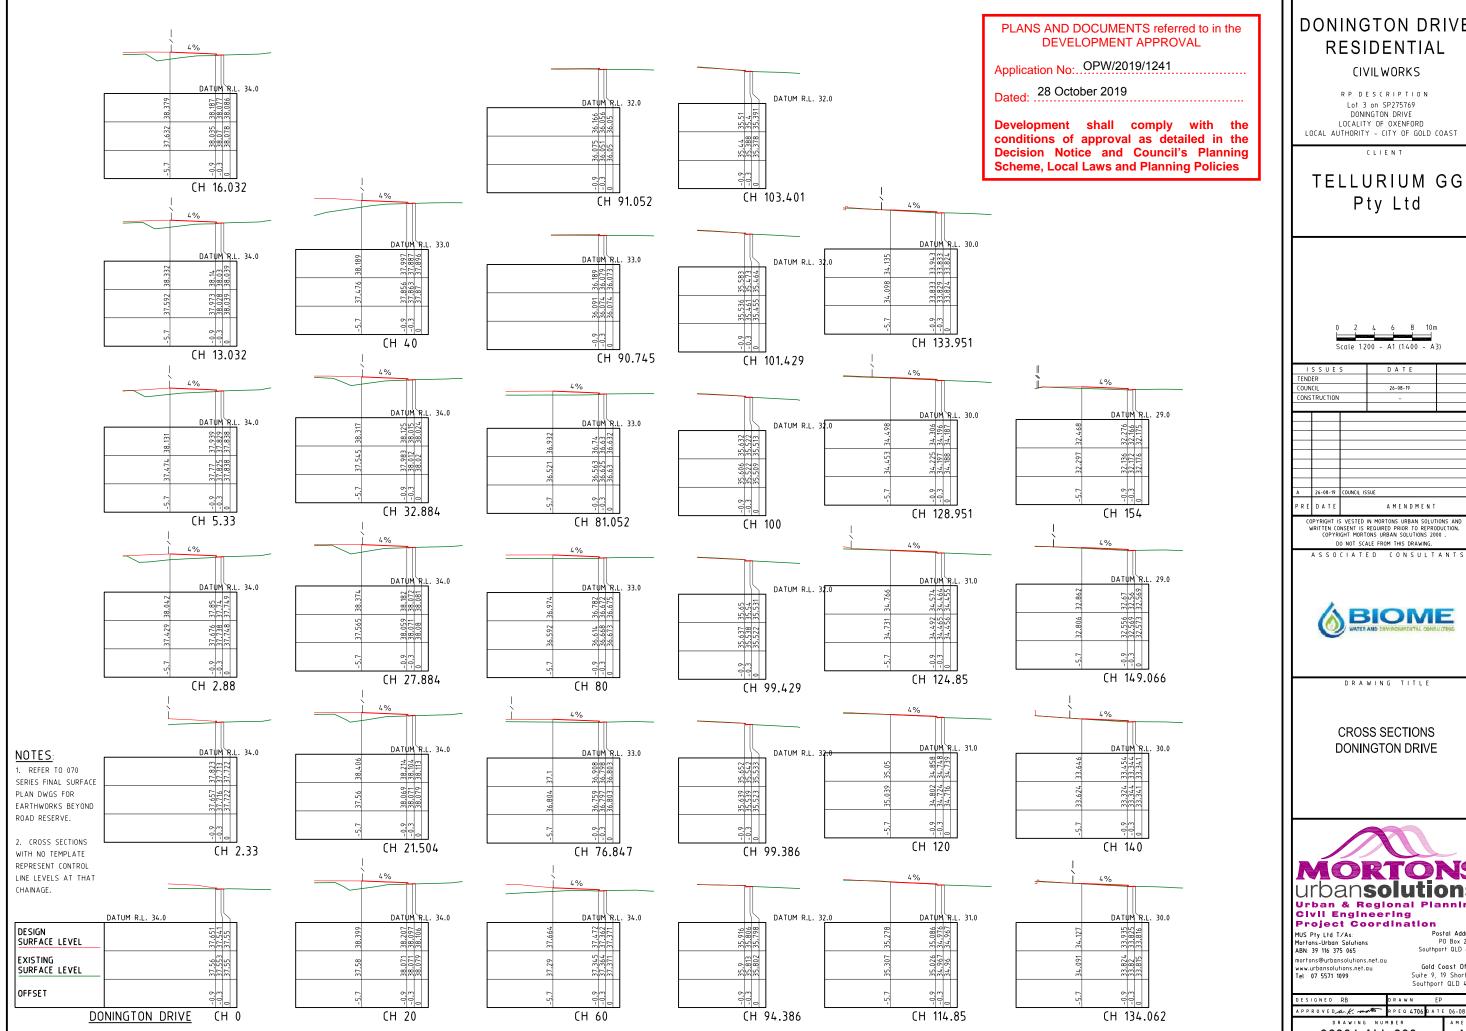
PO Box 2484 Southport QLD 4215 Gold Coast Office

Α

Gold Coast Office Suite 9, 19 Short St Southport QLD 4215

DESIGNED RB ORAWN EP

APPROVEDALK SOUTH RPEG 4706 DATE 06-08-19



DONINGTON DRIVE RESIDENTIAL

CIVILWORKS

RP DESCRIPTION Lot 3 on SP275769 DONINGTON DRIVE LOCALITY OF OXENFORD LOCAL AUTHORITY - CITY OF GOLD COAST

TELLURIUM GG Pty Ltd



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PRE	DATE			AMEND	MENT	

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DRAWING TITLE

CROSS SECTIONS DONINGTON DRIVE



Gold Coast Offic Suite 9, 19 Short S Southport QLD 421

APPROVEDA.K. morto RPEQ 4706 DATE 06-08-19

1. CONCRETE MIX

THE CONCRETE SHALL HAVE A MINIMUM 28 DAY CHARACTERISTIC COMPRESSIVE STRENGTH AS SPECIFIED IN THE SCHEDULE OF CONCRETE PAVEMENTS TABLE, MAXIMUM WATER/CEMENT RATIO OF 0.45 & A MINIMUM CEMENT CONTENT OF 300kg/m 3 .

2. SUBGRADE PREPARATION

THE SUBGRADE TO THE CONCRETE PAVEMENT AREAS SHALL BE PREPARED THE SAME AS CONVENTIONAL ROADS. REFER TO SCHEDULE OF CONCRETE PAVEMENTS TABLE.

3. TRAFFIC

TRAFFIC SHALL NOT BE ALLOWED ON THE FINISHED CONCRETE PAVEMENT FOR AT LEAST 14 DAYS AFTER COMPLETION OF CONSTRUCTION. THE CONTRACTOR IS RESPONSIBLE FOR INSTALLING MEASURES TO PREVENT UNAUTHORISED ACCESS.

4. JOINTS

ALL JOINTS SHALL BE LOCATED GENERALLY PERPENDICULAR
TO THE CENTRELINE. ALL CONTROL JOINTS TO BE COMPLETED
AS SOON AS CONCRETE HAS CURED SUFFICIENTLY SO AS NOT
TO DAMAGE THE SLAB SURFACE.

ALL JOINTS ARE TO BE INSTALLED AS DETAILED ON IPWEAQ STD DWG RS-065.

5. GENERAL

THE GRAVEL PAVEMENT SHALL BE NEATLY PROFILED & TRIMMED TO ENSURE CONSTANT CONCRETE DEPTHS & PROFILES. ACTUAL CONSTRUCTION REQUIREMENTS MAY VARY FROM THE DETAILS SHOWN & THEREFORE ALL CONSTRUCTION DETAILS SHOULD BE VERIFIED BY THE SUPERINTENDENT PRIOR TO CONSTRUCTION COMMENCING. PROVIDE ABLEFLEX BETWEEN KERB & DRIVEWAY.

6. COMPLIANCE ST&ARDS

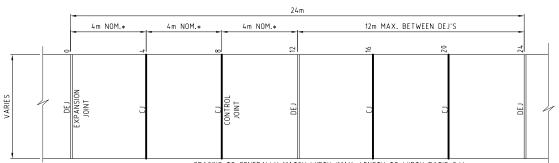
SLIP RESISTANCE OF SURFACE MATERIALS IN ACCORDANCE WITH AUSTRALIAN STANDARDS.

AS/NZS 4586 2013 SLIP RESISTANCE OF NEW

PEDESTRIAN SURFACE MATERIALS.
AS/NZS 4663: 2013 SLIP RESISTANCE MEASUREMENT OF

EXISTING PEDESTRIAN SURFACES
HB.A.A. 197: 1999 "AN INTRODUCTORY GUIDE TO THE
SLIP RESISTANCE OF PEDESTRIAN SURFACE MATERIALS"






* SPACING TO GENERALLY MATCH WIDTH (MAX. LENGTH TO WIDTH RATIO 3:4)


TYPICAL CONCRETE PAVEMENT DETAIL FOR DRIVEWAYS AND ROADS SCALE 150 - A1 (1:100 - A3)

0	0.	5 1	.0	1.	5	2.	0	2.	5
Sc	ale	1:50	-	Α1	(1:	100	-	A:	3)

SCHEDULE OF CONCRETE PAVEMENTS						
FUNCTION	SURFACING SUBGRADE PREPARATION THICKNESS 'T' STRENGTH REINCORCING					
FOOTPATH 1.5 AND 2.0M WIDE	HEAVY BROOM FINISH	50mm SAND BLINDING LAYER	100mm	32 mPa	SL 72 MESH	
DRIVEWAY STORMWATER BASIN	HEAVY BROOM FINISH	100mm (CBR 15)	175mm	32 mPa	SL 72 MESH	

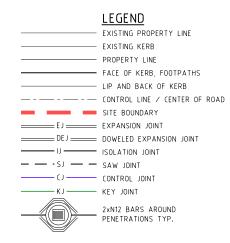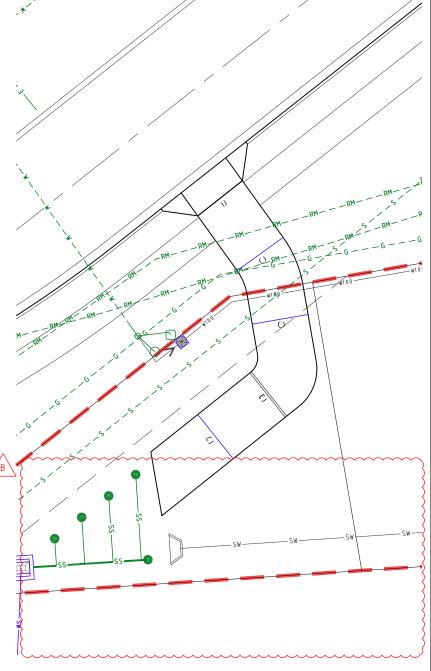NOTE: FOOTPATH JOINTING TO BE IN ACCORDANCE WITH IPWEAQ DWG RS-065 SUPERINTENDENT TO CONFIRM SUBGRADE PREPARATION





STORMWATER MANAGEMENT DEVICES INCLUDING THE BIO BASIN IS CONSIDERED INTERNAL AND PRIVATE INFRASTRUCTURE AND IS TO BE OWNED AND MAINTAINED PRIVATELY.

PLANS AND DOCUMENTS referred to in the DEVELOPMENT APPROVAL

Application No: OPW/2019/1241

Dated: 28 October 2019

Development shall comply with the conditions of approval as detailed in the Decision Notice and Council's Planning Scheme, Local Laws and Planning Policies

VEHICULAR CROSSOVER (VXO)

The vehicular crossover (VXO) is not part of this assessment.

Where a new VXO is required, or a change to the existing VXO is necessary, a Vehicular Crossing Permit must be obtained prior to the issuing of a development permit for building work, in accordance with the requirements of Local Law 11.

PROJECT NAME

DONINGTON DRIVE RESIDENTIAL

CIVILWORKS

RPDESCRIPTION

Lot 3 on SP275769

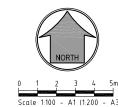
DONINGTON DRIVE

LOCALITY OF OXENFORD

LOCAL AUTHORITY - CITY OF GOLD COAST

CLIENT

TELLURIUM GG Pty Ltd



ISSUES			DATE	
TENDER				
COUN	CIL		26-08-19	
CONS	ONSTRUCTION			
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		COUNCIL IS	SUE	
PRE DATE			AMENDMEN	T

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A S S O C I A T E D C O N S U L T A N T S



DRAWING TITLE

CONCRETE JOINTING PLAN AND DETAILS SHEET 01



MUS Pty Ltd T/As: Mortons-Urban Solutions ABN: 39 116 375 065 mortons@urbansolutions.net.au

Postal Address
PO Box 2484
Southport QLD 4215
Gold Coast Office

Tel 07 5571 1099 Suite 9, 19 Short St Southport QLD 4215

APPROVED M.K. RPEQ 4706 DATE 06-08-19

DRAWING NUMBER AMEND.

36901-ALL-410

VEGETATION PROTECTION

- TREES LOCATED ALONG THE FOOTPATH SHALL BE, TRANSPLANTED PRIOR TO CONSTRUCTION, OR REPLACED IF DESTROYED.
- WHEN WORKING WITHIN 4m OF TREES RUBBER OR HARDWOOD GIRDLES SHALL BE CONSTRUCTED WITH 1.8 m BATTENS CLOSELY SPACED & ARRANGED VERTICALLY FROM GROUND LEVEL. GIRDLES SHALL BE STRAPPED TO
- TREES PRIOR TO CONSTRUCTION & REMAIN UNTIL COMPLETION.
 TREE ROOTS SHALL BE TUNNELLED UNDER, RATHER THAN SEVERED. IF ROOTS ARE SEVERED THE DAMAGED AREA SHALL BE TREATED WITH A SUITABLE FUNGICIDE. CONTACT RELEVANT COUNCIL ARBORIST FOR FURTHER ADVICE. ANY TREE LOPPING REQUIRED SHOULD BE UNDERTAKEN BY AN APPROVED ARBORIST.

- TOPSOIL & SUBSOIL SHALL BE STOCKPILED SEPARATELY.

 (ARE SHALL BE TAKEN TO PREVENT SEDIMENT FROM ENTERING THE STORMWATER SYSTEM. THIS MAY INVOLVE PLACING APPROPRIATE SEDIMENT CONTROLS AROUND STOCKPILES.
 IF ACID SULPHATE SOILS EXIST IN THE WORKS AREA. THE CONTRACTOR MUST PREPARE A RISK ASSESSMENT
- BASED ON THE QUEENSLAND ACID SULPHATE SOIL TECHNICAL MANUAL & MANAGE THE ACID SULPHATE SOILS AS PER THE MANUAL.

CREEK CROSSINGS

- SILTATION CONTROL MEASURES SHALL BE PLACED DOWNSTREAM OF ANY EXCAVATION WORK.
- APPROPRIATE SEDIMENT CONTROLS SHALL BE USED TO PREVENT SEDIMENT FROM ENTERING THE CREEK. NO SOIL SHALL BE STOCKPILED WITHIN 5 m OF THE CREEK.
- REHABILITATION PREDISTURBANCE SOIL PROFILES & COMPACTION LEVELS SHALL BE REINSTATED.
- PREDISTURBANCE VEGETATION PATTERNS SHALL BE RESTORED.

SAFETY

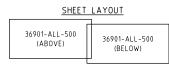
- A. THE DESIGN & CONSTRUCTION OF THE WORKS SHALL COMPLY WITH ALL QUEENSLAND LEGISLATION. <u>GENERAL</u>
- ALL WORK & MATERIALS SHALL BE IN ACCORDANCE WITH CURRENT SOUTH EAST QUIFNSI AND SEWFRAGE CODE SPECIFICATIONS & STANDARDS.
- UNLESS SPECIFIED OTHERWISE ALL MATERIALS & WORK SHALL COMPLY WITH THE RELEVANT AUSTRALIAN STANDARDS.
- THE CONSTRUCTION OF THE SEWERAGE WORK SHOWN ON THIS DRAWING SHALL BE SUPERVISED BY AN ENGINEER WHO HAS RPEQ REGISTRATION. SEWERAGE WORKS NOT COMPLYING WITH THIS REQUIREMENT WILL NOT BE PERMITTED TO CONNECT INTO THE SEQ SERVICE PROVIDER SEWERAGE SYSTEM.
- ALL WORK ASSOCIATED WITH LIVE SEWERS OR MAINTENANCE HOLES SHALL BE CARRIED OUT BY DEVELOPER'S APPROVED CONTRACTOR UNDER THE SUPERVISION OF SEQ'S AGENT AT THE DEVELOPER'S COST.
- ALL PIPES & MATERIALS SHALL COMPLY WITH THE REQUIREMENTS OF THE "ACCEPTED PRODUCTS & MATERIALS"
- EACH ALLOTMENT SHALL BE SERVED BY A DN100 PVC PROPERTY CONNECTION. FOR ALLOTMENTS OTHER THAN
- SINGLE RESIDENTIAL, A DN160 PE (OR DN150 PVC) PROPERTY CONNECTION SHALL BE PROVIDED. PROPERTY CONNECTIONS SHALL BE LOCATED WITHIN THE PROPERTY AS SHOWN IN THE DRAWINGS
- PROPERTY CONNECTION BRANCHES SHALL EXTEND INTO THE PROPERTY A MINIMUM OF 300 mm & A MAXIMUM OF 750 mm. UNITYWATER REQUIRES MINIMUM EXTENSION OF 500 mm INTO PROPERTY.
- WHERE PIPES ARE LAID IN FILL, THE FILLING SHALL BE CARRIED OUT IN LAYERS NOT EXCEEDING 300 mm (LOOSE) IN DEPTH & SHALL BE COMPACTED UNTIL THE COMPACTION IS NOT LESS THAN 95% OF THE MATERIALS MAXIMUM COMPACTION WHEN TESTED IN ACCORDANCE WITH A.S. 1289 (MODIFIED COMPACTION). TESTING SHALL BE CARRIFD OUT AFTER FACH ALTERNATE LAYER. IN ALL SUCH CASES APPROVAL OF CONSTRUCTED SEWERS WILL NOT BE ISSUED BY THE SEQ SERVICE PROVIDER UNLESS CERTIFICATES ARE PRODUCED CERTIFYING THAT THE REQUIRED COMPACTION HAS BEEN ACHIEVED.
- WHERE SEWERS HAVE A GRADE OF 1 IN 20 OR STEEPER BULKHEADS SHALL BE CONSTRUCTED IN ACCORDANCE WITH THE SEQ SEWER CODE.
- THE CONTRACTOR SHALL VERIFY THE LOCATION & DEPTH OF EXISTING SERVICES WITH RELEVANT AUTHORITIES BEFORE COMMENCING WORKS.
- SEWERS SHALL BE DISUSED / ABANDONED IN ACCORDANCE WITH PROCEDURES SET OUT IN THE SEQ SEWER CODE.
- 13. BENCH MARK & LEVELS TO AHD.
- 14. THE EXISTING DWELLING ON LOT 3, REFER SEQ-SEW-1100, SERVED BY A SEPTIC SYSTEM, SHALL BE CONNECTED TO THE NEW SEWER BY A LICENCED PLUMBER IN ACCORDANCE WITH THE RELEVANT STATUTORY & COUNCIL.
 REQUIREMENTS. THE SEPTIC SYSTEM, INCLUDING TRENCHES, SHALL BE REMOVED AT THE DEVELOPER'S COST. ALL FIXTURES SHALL BE UPGRADED IF REQUIRED BY PLUMBING CODE. STANDARD NOTE NOT APPLICABLE & THEREFORE DELETED.
- 15. EXISTING ALLOTMENTS REQUIRING A PROPERTY CONNECTION FROM EXISTING SEWERS SHALL BE PROVIDED BY THE SEQ SERVICE PROVIDER AT THE DEVELOPERS COST.

- PROJECT SPECIFIC SEWER NOTES

 a. ALL SEWER MAINS TO BE AS PER SEWER PIPE SPECIFICATIONS TABLE.
- NOTWITHSTANDING THE STANDARD SEQ NOTES ABOVE, ALL MATERIALS & WORKS MUST BE IN ACCORDANCE WITH THE SERVICE PROVIDER'S APPROVAL CONDITIONS & THE SEQ WS&S D&C CODE. THE CONTRACTOR IS TO INCLUDE ROCK EXCAVATION AS PART OF THEIR SEWER RATES UNLESS SCHEDULED
- OTHERWISE WITHIN THE CONTRACT THE CONTRACTOR TO PROVIDE CALCAREOUS CONCRETE WHERE SPECIFIED IN THE SEQ CODE BY THE RELEVANT
- WATER & ELECTRICAL CROSSING LOCATIONS ARE INDICATIVE ONLY. REFER TO PLANS TO DETERMINE PRECISE
- CROSSING LOCATIONS. WHERE SERVICE INDICATES CLASH WITH SEWER, SEWER TO TAKE PRECEDENCE, SERVICE TO BE CONSTRUCTED OVER OR UNDER SEWER ACCORDING TO SUPERINTENDENT'S INSTRUCTION ALL BENDS TO BE LONG RADIUS BEND TO MEET MANUFACTURER'S MINIMUM RADIUS REQUIREMENTS U.N.O.
- CONTRACTOR TO VERIFY DOWNSTREAM EXISTING PIPE LEVELS PRIOR TO COMMENCEMENT OF WORKS ON-SITE.
- PROPERTY CONNECTIONS HAVE BEEN DESIGNED TO CONTROL THE REQUIRED SERVICE AREA OF FACH LOT AT A GRADE OF 1.60 & A MAXIMUM DEPTH OF PROPERTY CONNECTION AT 1.5m. UNLESS OTHERWISE STATED.
- CONTRACTOR TO PAY ALL FEES & CHARGES ASSOCIATED WITH CONNECTIONS.

LEGEND EXISTING KERB (INVERT EXISTING PROPERTY LINE - - EXISTING SEWER _ PM __ EXISTING RISING MAIN — SW — — — EXISTING STORMWATER -W - - W - - - EXISTING WATER -G - - G - - FXISTING GAS -E — -E — - EXISTING UNDERGROUND ELECTRICITY -E - ¥ -E - ¥ - EXISTING OVERHEAD ELECTRICITY -T - - T - - - EXISTING TELSTRA — 1.0— FXISTING CONTOURS FUTURE SEWER PROPOSED KERB (INVERT) PROPOSED PROPERTY LINE — S — PROPOSED SEWER PROPOSED RETAINING WALL SITE BOUNDARY - DESIGN CONTOURS SEWER MANHOLE SEWER BEND SEWER MAINTENANCE SHAFT

01-10 SEWER PIT NO/LINE



No.

LIVE CONNECTIONS BY CONTRACTOR THE CONTRACTOR MAY MAKE THE LIVE SEWER & WATER CONNECTIONS UNDER THE WATER AUTHORITY'S SUPERVISION. SEWER PIPE SPECIFICATIONS

TO COMMENCEMENT OF EARTHWORKS. LIVE CONNECTION TO BE COMPLETED AFTER SUCCESSFUL "ON MAINTENANCE" INSPECTION.

PLANS AND DOCUMENTS referred to in the **DEVELOPMENT APPROVAL**

Development shall comply with the conditions of approval as detailed in the

Decision Notice and Council's Planning

Scheme, Local Laws and Planning Policies

03/10

IF THE CONTRACTOR WISHES TO MAKE THE CONNECTION THEY MUST INDICATE AT TIME OF TENDER & INSERT A LUMP SUM TO COMPLETE

THE CONTRACTOR IS TO MAKE THE LIVE CONNECTIONS ALL

THESE REQUIREMENTS ARE NOT LIMITED TO BUT MAY INCLUDE:

a. CURRENT FEES PER CONNECTION TO BE PAID BY THE

b. CARRY OUT ALL TESTING AS REQUIRED.

SUPPLY ALL DETAILS OF CONNECTION

d. SUPPLY ALL HEALTH & SAFETY INFORMATION.

REQUIREMENTS OF THE WATER AUTHORITY MUST BE ADHERED TO.

THE WORKS

CONTRACTOR

Application No: OPW/2019/1241

Dated: 28 October 2019

SEWER MAIN LOCATION	PIPE MATERIAL SPECIFICATIO
GRAVITY VERGE	PVC-U SN8
GRAVITY ROAD CROSSING	PVC-U SN8
HOUSE CONNECTIONS	PVC-U SN6
RISING MAIN TRENCHED	PVC-m SN16
RISING MAIN BORED	PVC-m SN16

CONTRACTOR TO LOCATE

STUB & ENSURE NO

DAMAGE TO SERVICE

DONINGTON DRIVE

ALL ENVIRONMENT PROTECTION MEASURES SHALL BE IMPLEMENTED PRIOR TO ANY CONSTRUCTION WORK, INCLUDING CLEARING, COMMENCING.

NSPECTION OPENING 1.6m

OFF PROPERTY BOUNDARY

3

TO BE CONSTRUCTED.

PROVIDE TEMPORARY

NEND CAP FOR FUTURE

CONNECTION

FUTURE SEWER SUBJECT TO

PLUMBING & DRAINAGE

APPLICATION-

RP153300

06/01

LIVE CONNECTION REFER TO LIVE

SEWER WORKS SCHEDULE

LRM-

SP188406

GAVEN ARTERIAL ROAD



SERVICE PROVIDER AND CONSTRUCTOR LIVE SEWER WORKS SCHEDULE Depti MH/MS Cover Dia. Description MH No. Lot no F.S.L E.S.L I.L tο Туре Туре Sewei inver CIVIL CONTRACTOR UNDER GOLD COAST WATER SUPERVISION TO BREAK INTO EXISTING MANHOLE & MAKE GOOD. CONTRACTOR TO CONFIRM EXISTING I.L. PRIOR ROAD 15.0 32.542 06/01 35.829 3.307

PROJECT NAME

DONINGTON DRIVE RESIDENTIAL

CIVILWORKS

RP DESCRIPTION Lot 3 on SP275769 DONINGTON DRIVE LOCALITY OF OXENFORD LOCAL AUTHORITY - CITY OF GOLD COAST

CLIENT

TELLURIUM GG Pty Ltd



5 7.5 10 12.5m Scale 1:250 - A1 (1:500 - A3)

R IIL				
		26-08-19		
CONSTRUCTION				
02-10-19	SEWER INS	PECTION OPENING, CONTOURS	AND NOTE	ADDE
A 26-08-19 COUNCIL IS		SUE		
DATE		AMENDMENT		
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WRITTEN CONSENT IS REQUIRED PRIOR TO REPRODUCTION.

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DRAWING TITLE

SEWER RETICULATION PLAN SHEET 01



MUS Pty Ltd T/As: Mortons-Urban Solutions ABN: 39 116 375 065 tons@urbansolutions.net.au 07 5571 1099

Southport QLD 42 Gold Coast Offic

Southport QLD 421

DESIGNED RB DRAWN RPEQ 4706 DATE 06-08-19 APPROVEDALE MA 36901-ALL-500 В

RIGS STRUCTURE TYPES PRECAST CONCRETE SEWER MAINTENANCE STRUCTURE REFER TO SEQ STD DWG SEQ-SEW-1300-1 TYPE 'A' 1050mm DIA. MAINTENANCE STRUCTURE REFER TO SEQ STD DWGS SEQ-SEW-1307-1 TYPE 'B' 1200mm DIA. MAINTENANCE STRUCTURE REFER TO SEQ STD DWGS SEQ-SEW-1307-1 TYPE 'C' 1500mm DIA. MAINTENANCE STRUCTURE REFER TO SEQ STD DWGS SEQ-SEW-1307-1 TYPE 'J1' MAINTENANCE STRUCTURE REFER TO SEQ STD DWGS SEQ-SEW-1314-2 REFER TO SEQ STD DWGS SEQ-SEW-1314-3 RODDING FND MAINTENANCE STRUCTURE RE RODDING END MAINTENANCE STRUCTURE REFER TO SEQ STD DWGS SEQ-SEW-1314-1

END	PROPRIETORY END CAP
PS	SEWER PUMP STATION REFER TO RELEVANT SEQ STD DWGS

RECEIVING MAINTENANCE STRUCTURE RCM REFER TO RELEVANT SEQ STD SEWER PUMP STATION

TYPE 'G6' TERMINAL MAINTENANCE SHAFT REFER TO SEQ STD DWGS SEQ-SEW-1314-1

RIGS STRUCTURE DROPS V STRAIGHT THROUGH SEWER REFER TO SEQ STD DWG SEQ-SEW-1303-1 W OBLIQUE BACKDROP REFER TO SEQ STD DWG SEQ-SEW-1303-1 INTERNAL BACKDROP REFER TO SEQ STD DWG SEQ-SEW-1303-1 EXTERNAL BACKDROP REFER TO SEQ STD DWG SEQ-SEW-1303-1

INSTRUCTION

SN16 U.N.O.

CODE

PIPE GRADE

DATUM R.L.

PIPE INVERT

LEVELS

LEVELS


CHAINAGE

LINE NO.

RIGS STRUCTURE DROPS

А	SEWER PROPERTY CONNECTION (STANDARD & EXTENDED) REFER TO SEQ STD DWGS SEQ-SEW-1104-1
В	SEWER PROPERTY CONNECTION (SLOPED CONNECTION) REFER TO SEQ STD DWGS SEQ-SEW-1104-1
D	SEWER PROPERTY CONNECTION (VERTICAL RISER) REFER TO SEQ STD DWG SEQ-SEW-1105-1
V	SEWER PROPERTY CONNECTION (STRAIGHT THROUGH SEWER) REFER TO SEQ STD DWG SEQ-SEW-1303-1
×	SEWER PROPERTY CONNECTION (INTERNAL BACKDROP) REFER TO SEQ STD DWG SEQ-SEW-1303-1
Z	RISER CONNECTION TO PORTION OF MAINTENANCE SHAFT



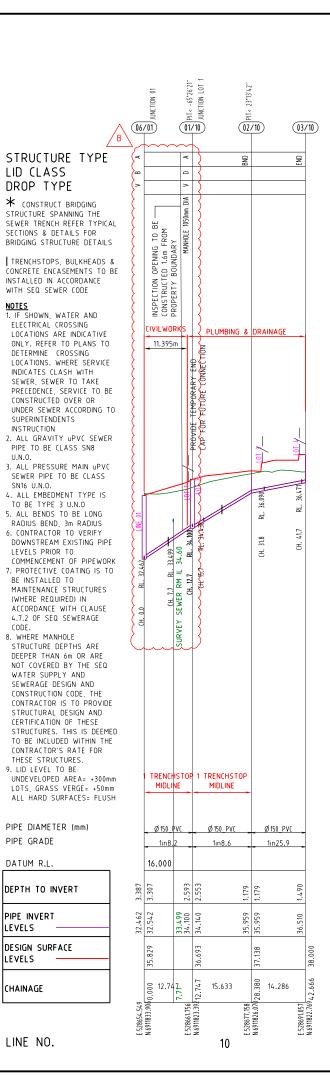

PROJECT NAME

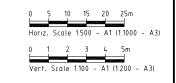
DONINGTON DRIVE RESIDENTIAL

CIVILWORKS

RP DESCRIPTION Lot 3 on SP275769 DONINGTON DRIVE LOCALITY OF OXENFORD LOCAL AUTHORITY - CITY OF GOLD COAST

CLIENT

TELLURIUM GG Pty Ltd



- 1	SSUES		DATE	
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COUN	CIL		26-08-19	
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DRAWING TITLE

SEWER RETICULATION **PROFILES** SHEET 01



Civil Engineering **Project Coordination**

MUS Pty Ltd T/As: Mortons-Urban Solutions ABN: 39 116 375 065 ortons@urbansolutions.net.au Tel 07 5571 1099

PLANS AND DOCUMENTS referred to in the

DEVELOPMENT APPROVAL

Development shall comply with the

conditions of approval as detailed in the

Decision Notice and Council's Planning Scheme, Local Laws and Planning Policies

Application No: OPW/2019/1241

Dated:28 October 2019

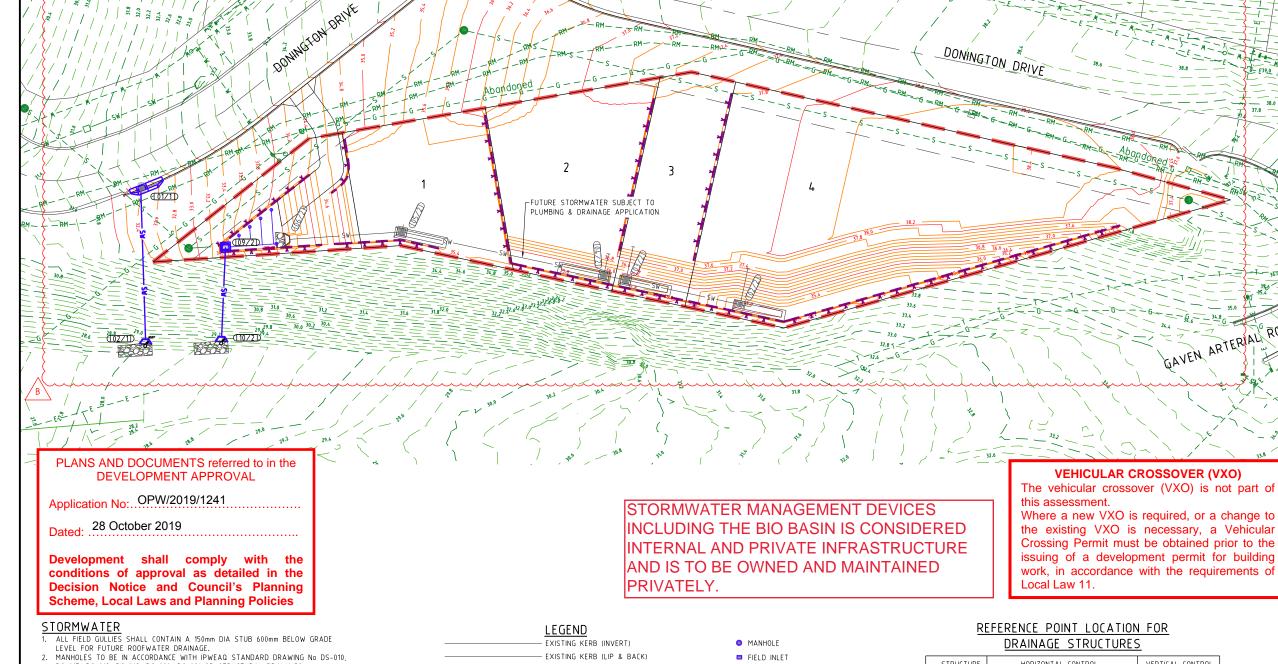
PO Box 248 Gold Coast Offic

В

Postal Addres

Suite 9, 19 Short S Southport QLD 421

DRAWN DESIGNED RB APPROVEDALK MONTO RPEQ 4706 DATE 06-08-15



- EXISTING PROPERTY LINE

-RM— — — EXISTING RISING MAIN

-E---E---EXISTING UNDERGROUND ELECTRICITY --- E - ¥ - E - ¥ --- EXISTING OVERHEAD ELECTRICITY — T — — T — — EXISTING TELSTRA

- FUTURE STORMWATER

- CONTROL LINE / CENTER OF ROAD

PROPOSED KERB (LIP & BACK)

PROPOSED KERB (INVERT)

— PROPOSED PROPERTY LINE

- PROPOSED STORMWATER

DESIGN CONTOURS

1.0— — EXISTING CONTOURS

SITE BOUNDARY

T T T PROPOSED RETAINING WALL

W — — EXISTING WATER

−G — — FXISTING GAS

— S — — — S — — — EXISTING SEWER

KERB INLET (ON GRADE) PIT

KERB INLET (SAG) PIT

(10/001) DRAINAGE PIT & LINE NO.

YOU DIG

T HEADWALL

SCOUR PROTECTION

DIVAINAGE STRUCTURES							
STRUCTURE TYPE	HORIZONTAL CONTROL (Reference Point Location)	VERTICAL CONTROL (Reference Level)					
MANHOLE / GRATED PIT	CENTRE OF MANHOLE / PIT	FINISHED SURFACE LEVEL					
GULLY PIT	LIP AT CENTRE OF PIT	FINISHED SURFACE LEVEL (LIP OF CHANNEL)					
HEADWALL	INTERSECTION OF HEADWALL FACE & PIPE CENTRELINE	INVERT LEVEL					

REFERENCE POINT LOCATION FOR DRAINAGE STRUCTURES

	BRANKINGE STREET ONES	_
STRUCTURE TYPE	HORIZONTAL CONTROL (Reference Point Location)	VERTICAL CONTROL (Reference Level)
MANHOLE / GRATED PIT	CENTRE OF MANHOLE / PIT	FINISHED SURFACE LEVEL
GULLY PIT	LIP AT CENTRE OF PIT	FINISHED SURFACE LEVEL (LIP OF (HANNEL)
HEADWALL	INTERSECTION OF HEADWALL FACE & PIPE CENTRELINE	INVERT LEVEL

REFER TO DWG SERIES 640 FOR ALL DRAINAGE STRUCTURE SETOUT AND/OR CUSTOM DETAILS.

SP188406

DS-015, DS-018, DS-019, DS-020, DS-021 OR STRUCTURAL DRAWINGS (STRUCTURAL DRAWINGS TAKE PRECEDENCE).

OUTLET HEADWALLS TO BE IN ACCORDANCE WITH LOCAL COUNCIL STANDARD

DRAWINGS.

4. ALL HEADWALLS WITH A FALL GREATER THAN 900mm HIGH REQUIRE INSTALLATION OF PEDESTRIAN SAFETY FENCES.

5. ALL PIPES 600mm DIA OR LESS TO BE SOCKETED CONCRETE PIPES WITH RUBBER RING JOINTS. PIPED GREATER THAN 600mm DIA SHALL BE BUTT OR FLUSH

JUNIEU.
ALL ALLOTMENTS TO BE GRADED SUCH THAT FUTURE ROOFWATER DRAINAGE
DISCHARGES TO KERB OR TO PIPED DRAINAGE SYSTEM.
ALL PIPE 300mm DIA & GREATER SHALL BE CONSTRUCTED USING SRC OR FRC
PIPES. CONTRACTOR MAY ELECT TO USE PVC PIPES WITHIN ALLOTMENTS FOR

PIPES SMALLER THAN 300mm DIA. FOR SETOUT DETAILS REFER TO 640 SERIES DRAWINGS (PROFILES & PIT DETAILS).

GULLY PITS TO BE IN ACCORDANCE WITH IPWEAQ STANDARD DRAWING No DS-060, DS-061, DS-062, DS-063. WHERE PITS ARE CONSTRUCTED AS DRAINWAY PITS, TO BE IN ACCORDANCE WITH IPWEAQ STANDARD DRAWINGS No 05-068.

10. LOTS WHICH CAN DRAIN OVERLAND FLOW TO THE STREET SWALE / DRAINAGE WITHOUT FLOWING THROUGH ADJOINING PROPERTIES NEED TO PROVIDE FOR Q100

OVERLAND FLOW TO THE ROAD

11. LOT EARTHWORKS DURING BUILDING CONSTRUCTION MUST NOT CHANGE FLOW PATH DIRECTION UNLESS IT IS REPLACED WITH ANOTHER FLOW PATH DRAINING TO THE ROAD SWALE / DRAINAGE.

12. THE CONTRACTOR IS TO INCLUDE ROCK EXCAVATION AS PART OF THEIR STORMWATER RATE.

13. PIPE CLASS - PIPE CLASSES/TRENCH BEDDING SHOWN ON THE DRAWINGS ARE

SUBJECT TO THE CONTRACTORS PREFERRED INSTALLATION METHOD. THE CONTRACTOR IS RESPONSIBLE FOR INSTALLING THE APPROPRIATE PIPE (LASSES & BEDDING, & CONSIDERING CONSTRUCTION LOADING.

14. KERB ADAPTORS ARE TO BE INSTALLED TO AUTHORITIES REQUIREMENTS.

ALL RCBC SLABS ARE TO BE CAST INSITU

PROJECT NAME

DONINGTON DRIVE RESIDENTIAL

CIVILWORKS

RP DESCRIPTION Lot 3 on SP275769 DONINGTON DRIVE LOCALITY OF OXENFORD LOCAL AUTHORITY - CITY OF GOLD COAST

TELLURIUM GG Pty Ltd



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_	Α	26-08-19	COUNCIL IS	SUE		
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DRAWING TITLE

STORMWATER DRAINAGE PLAN SHEET 01

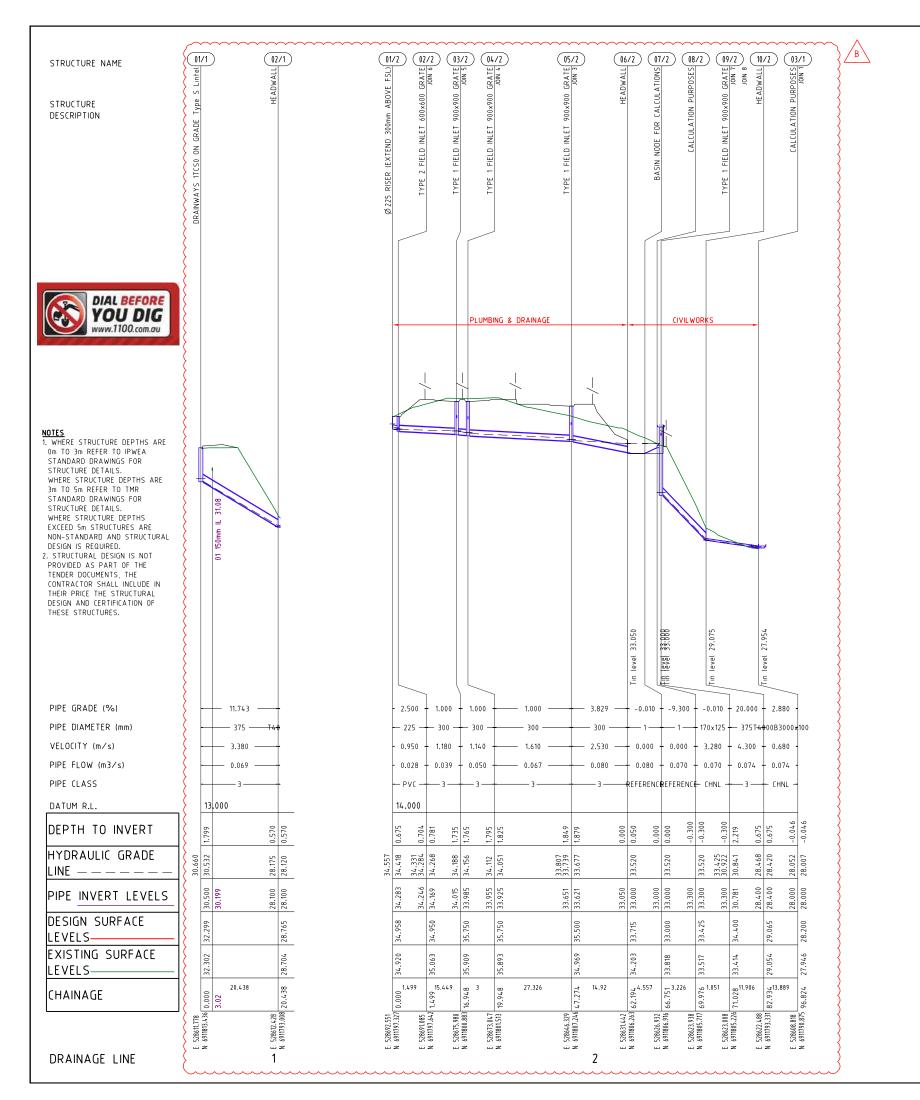


rtons@urbansolutions.net.au www.urbansolutions.net.au Tel 07 5571 1099

Gold Coast Offic Suite 9, 19 Short S Southport QLD 421

RPEQ 4706 DATE 06-08-19

36901-ALL-600




DONINGTON DRIVE RESIDENTIAL

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TELLURIUM GG Pty Ltd



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DRAWING TITLE

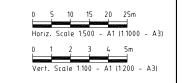STORMWATER **PROFILES** SHEET 01



Project Coordination Postal Addres

MUS Pty Ltd T/As: Mortons-Urban Solutions ABN: 39 116 375 065 ortons@urbansolutions.net.au www.urbansolutions.net.au Tel 07 5571 1099

PLANS AND DOCUMENTS referred to in the

DEVELOPMENT APPROVAL

Development shall comply with the

conditions of approval as detailed in the

Decision Notice and Council's Planning

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Application No: OPW/2019/1241

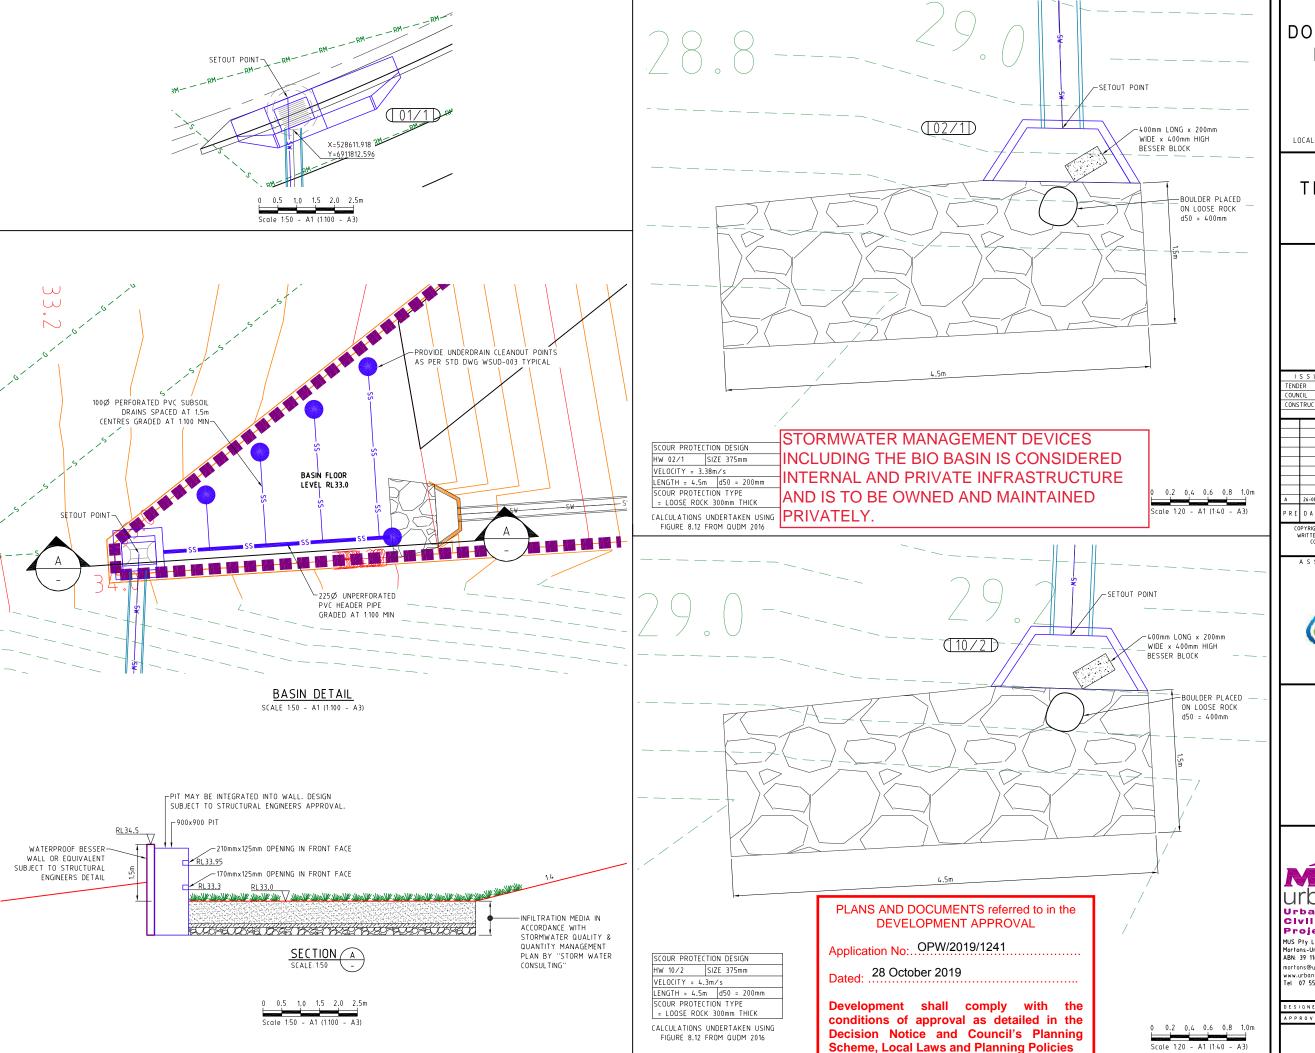
Dated:28 October 2019

Gold Coast Offic

В

Suite 9, 19 Short S Southport QLD 421

DRAWN DESIGNED RB APPROVEDALK MONTO RPEQ 4706 DATE 06-08-19



DONINGTON DRIVE RESIDENTIAL

CIVILWORKS

RP DESCRIPTION Lot 3 on SP275769 DONINGTON DRIVE
LOCALITY OF OXENFORD
LOCAL AUTHORITY - CITY OF GOLD COAST

CLIENT

TELLURIUM GG Pty Ltd



- 1	SSUE	S		DATE		
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DRAWING TITLE

STORMWATER DETAILS SHEET 01



Gold Coast Office Suite 9, 19 Short S Southport QLD 421

DESIGNED RB RPEQ 4706 DATE 06-08-19

DONINGTON DRIVE RESIDENTIAL

CIVILWORKS

RP DESCRIPTION LOCAL AUTHORITY - CITY OF GOLD COAST

CLIENT

TELLURIUM GG Pty Ltd



- 1	SSUE	S	DATE	
TEND	ER			
COUN	CIL		26-08-19	
CONS	TRUCTION			
В	02-10-19	STORM AND	CONTOURS AMENDED	
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PRE	DATE		AMENDMENT	

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DRAWING TITLE

STORMWATER **CATCHMENT PLAN** SHEET 01



MUS Pty Ltd T/As: Mortons-Urban Solutions ABN: 39 116 375 065 ortons@urbansolutions.net.au

Scheme, Local Laws and Planning Policies

Postal Addres

Gold Coast Office Suite 9, 19 Short S Southport QLD 4219

DESIGNED RB APPROVEDA.K. MOTO RPEQ 4706 DATE 06-08-19

36901-ALL-670

CALCULATION TABLES-MINOR 2YR ARI

0.1 ARI (Q10) MINOR	FLOW - 12D DYNAMIC DRAINAGE RESULTS				* REFER	TO IFD TABLE	FOR MAX	OMUM INTER	ISITY DUF	RING STO	RM																						
NOTE: NEGATIVE F	LOW VALUES INDICATE REVERSE FLOWS	9	CATCHME	NTAREA	RAINFALL	VOLUME*	RAINFAL	L Coef.	CATO	CHMENT	FLOW	DATE SALLING AND A STATE	I Commencer	APPROA	CH FLOW		F	LOWATP	IT.		- 10000100000 -	PIT		HGL		n selection verific	PIPE	HE	ADLOSSES	amora venera	Commence of	E Company	1
NODE	terration international meson til turnet i protesta.	A1	A2	A3	CRITICAL	INTENSITY		CURRENT	A1	A2	A3	CRITICAL	GRADE		FLOW		CAPTURED		BYPASS		GRADE	GRATE	PIT	PIPE		GRADE	FLOW	COEFFIC	HEAT HEA	ADLOSS	CAPACITY	VELOCITY	NODE
FROM: TO:	NODE TYPE	HA	HA	HA	STORM	MWHR	10 YR	Storm	HA	HA	HA	ARI MIN.	96	L/S	WDTH	DxV	L/S	L/S	DxV	NODE	96	RL.	RL	U/S RL.	D/S RL	96	M3/S	Ku	Kw K	Gu Kw	RATIO	MS	
01/1 02/1	DRAINWAYS 1TCS0 ON GRADE Type S Lintel	0.158			60	69.1	0.877	0.877	0.069			25	0.00	69			69.000					32.299	30.660	30.532	28.175	11.532	0.069	9.7	9.7 0	0.19	0.09	3.38	01/1
02/1 03/1	HEADWALL											25		0			0					28.765	28.12	28.12	28.05	1.62	0.07	0.0	0.0 0.	.0 0.0	0.06	0.9	02/1
03/1 04/1	CALCULATION PURPOSES	2								8		25		0			0					28.200	28.05	28.01	27.89	5.46	0.13	2.0	2.0 0.	0.0	0.02	1,16	03/1
04/1	CALCULATION PURPOSES											25		0			0					28.070	27.89										04/1
01/2 02/2	%%C225 RISER (EXTEND 300mm ABOVE FSL)	0.064	3 8		60	69.1	0.877	0.877	0.028			25	9.5	28			28	6 5			9.486	34.958	34.56	34.42	34,33	5.80	0.03	6.2	6.2 0.	1 0.1	0.3	0.95	01/2
02/2 03/2	TYPE 2 FIELD INLET 600x600 GRATE											25	9.3	0			0				9.292	34.950	34.28	34.27	34.19	0.52	0.04	0.2	0.2 0.	0.0	0.31	1.18	02/2
03/2 04/2	TYPE 1 FIELD INLET 900x900 GRATE	7.4										25	2.4	0			0				2.387	35.750	34.19	34,16	34.11	1.47	0.05	0.6	0.6 0.	0.0	0.4	1.14	03/2
04/2 05/2	TYPE 1 FIELD INLET 900x900 GRATE	7										25	0.8	0			0				0.828	35.750	34.11	34.05	33.81	0.89	0.07	0.8	0.8 0.	0.0		1.61	04/2
05/2 06/2	TYPE 1 FIELD INLET 900x900 GRATE	3	A									25	4.2	0			0	0 5		1	4.200	35,500	33.74	33.68	33,52	1.05	0.08	0.6	0,6 0,	0.0	0.32	2,53	05/2
06/2 07/2	HEADWALL	1										25	6.6	0			0				6,639	33.715	33.52	33.52	33.52	0.00	0.08	0.0	0.0 0.				06/2
07/2 08/2	BASIN NODE FOR CALCULATIONS	2										25	9.9	. 0			0			1	9.883	33.000	33.52	33.52	33.52	0.00	0.07	0.0	0.0 0.	0.0	- B 1000 - S	C 100000	07/2
08/2 09/2	CALCULATION PURPOSES	4										25	8.9	0			0				8.925	33.425	33.52	33.52	33.43	9.04	0.07	0.0	0.8 0.	0.5		3.28	08/2
09/2 10/2	TYPE 1 FIELD INLET 900x900 GRATE	0.013			60	69.1	0.877	0.877	0.006			25	8.9	6			6				8.925	34,400	30.92	30.84	28.47	19.93	0.07	2.1	2.7 0.	1 0.1	0.07	4.3	09/2
10/2 03/1	HEADWALL					-			- 00000			25	The same of	0			0	3 3				29.065	28.42	28.42	28.05	2.65	0.07	0.0	0.0	0.0	0.06	0.68	10/2
01/3 05/2	%%C225 RISER (EXTEND 300mm ABOVE FSL)	0.029			60	69.1	0.877	0.877	0.013			25	4.2	13			13				4.200	35.600	34.76	34.63	34.57	6.20	0.01	5.7	5.7 0.	0.1	0.4	0.92	01/3
01/4 04/2	%%C225 RISER (EXTEND 300mm ABOVE FSL)	0.040			60	69.1	0.877	0.877	0.017	1		25	8.0	17			17	3 3			0.828	36.100	35.14	34.99	34.89	10.50	0.02	4.6	4.0 0.	1 0.2	0.55	1.18	01/4
01/5 03/2	%%C225 RISER (EXTEND 300mm ABOVE FSL)	0.025			60	69.1	0.877	0.877	0.011			25	2.4	11			11				2.387	36,100	35.11	34.99	34.93	6.00	0.01	6.7	6.7 0.	1 0.1	0.35	0.83	01/5
01/6 02/2	%%C225 RISER (EXTEND 300mm ABOVE FSL)	0.027	1		60	69.1	0.877	0.877	0.012	8		25	9.3	12			12				9.292	35.300	34.50	34.37	34.31	5.70	0.01	6.2	6.2 0.	.1 0.1	0.42	0.85	01/6
01/7 09/2	CALCULATION PURPOSES											25	8.9	0			0				8.925	34.500	34.40	34.40	34.40	0.09	0.00	0.0	0.0	0.0	0	0	01/7
01/8 09/2	CALCULATION PURPOSES	3	8		9						3	25	8.9	0			0	8			8.925	34.075	33.95	33.95	33.95	0.00	0.00	0.0	0.0 0.	0.0	0	0	01/8
03/2 04/2	TYPE 1 FIELD INLET 900x900 GRATE											25	2.4	0			0				2.387	35,750	34.19	34.16	34.11	1.47	0.05	0.6	0.6 0.	0.0	0.4	1.14	03/2
01/6 02/2	%%C225 RISER (EXTEND 300mm ABOVE FSL)	0.027			60	69.1	0.877	0.877	0.012			25	9.3	12			12	D 1			9.292	35,300	34.50	34.37	34.31	5.70	0.01	6.2	6.2 0.	.1 0.1	0.42	0.85	01/6
02/2 03/2	TYPE 2 FIELD INLET 600x600 GRATE		1					2001312				25	9.3	0			0				9.292	34,950	34.28	34.27	34.19	0.52	0.04	0.2	0.2 0.	0.0	0.31	1.18	02/2
07/2 08/2	BASIN NODE FOR CALCULATIONS	-	Ä :									25	9.9	0			0	0 8			9.883	33.000	33.52	33.52	33.52	0.00	0.07	0.0	0.0 0.	0.0	9 10	E	07/2
01/7 09/2	CALCULATION PURPOSES											25	8.9	0			0				8.925	34.500	34.40	34.40	34.40	0.09	0,00	0.0	0.0 0.	.0 0.0	0	0	01/7
09/2 10/2	TYPE 1 FIELD INLET 900x900 GRATE	0.013			60	69.1	0.877	0.877	0.006			25	8.9	- 6			6				8.925	34.400	30.92	30.84	28.47	19.93	0.07	2.1	2.7 0.	1 0.1	0.07	4.3	09/2
07/2 08/2	BASIN NODE FOR CALCULATIONS				3000				- spicesson			25	9.9	0			0				9.883	33.000	33.52	33.52	33.52	0.00	0.07	0.0	0.0 0.	0.0		- 1100	07/2
01/8 09/2	CALCULATION PURPOSES	S management						N POST IN T	10.500			25	8.9	0			0				8.925	34.075	33.95	33.95	33.95	0.00	0.00	0.0	0.0	0.0	0	0	01/8
09/2 10/2	TYPE 1 FIELD INLET 900x900 GRATE	0.013			60	69.1	0.877	0.877	0.006	((25	8.9	6			6				8.925	34,400	30.92	30.84	28.47	19.93	0.07	2.1	2.7 0.	1 0.1	0.07	4.3	09/2

CALCULATION TABLES-MAJOR 100YR ARI

NOTE	NEGATIVE F	LOW VALUES INDICATE REVERSE FLOWS		CATCHM	ENT AREA	RANFALL	VOLUME*	RANFA	LL Coef.	CAT	CHMENT	FLOW		1	APPROA	CHFLOW			FLOWAT P	TT.			PIT		HGL		0	PIPE	HE	ADLOSS	SES				
MODE			A1	A2	A3	CRITICAL	INTENSITY	Y	CURRENT	A1	A2	A3	CRITICAL	GRADE		FLOW		CAPTURED		BYPASS		GRADE	GRATE	PIT	PIPE		GRADE	FLOW	COEFFIC	CIENT	HEADL(OSS	CAPACITY.	VELOCITY	NO
MOS	TO:	NODE TYPE	HA	HA	HA	STORM	MWHR	10 YR	Storm	HA	HA	HA	ARI MIN.	%	L/S	MOTH	DxV	L/S	L/S	DxV	NODE	%	RL.	RL	U/S RL	D/S.RL	%	M3/S	Ku	Kw	Ku	Kw	RATIO	MS	
1/1	02/1	DRAINWAYS 1TCS0 ON GRADE Type S Lintel	0.158			120	134.0	0.877	0.928	0.098			25		98			98.000					32.299	30.698	30.539	28.189	11.498	0.098	9.7	9.7	0	0.31	0.12	3.55	01
2/1	03/1	HEADWALL											25		0			0					28.765	28.13	28.13	28.07	1.26	0.10	0.0	0.0	0.0	0.0	0.09	0.93	0.2
3/1	04/1	CALCULATION PURPOSES		5			2			14 3			25		0			0				14 10	28.200	28.07	28.01	27.90	5.17	0.19	2.0	2.0	0.1	0.0	0.04	1.22	0.3
4/1		CALCULATION PURPOSES											25		0			0					28.070	27.90										1000000	04
1/2	02/2	%%C225 RISER (EXTEND 300mm ABOVE FSL)	0.064	5		120	134.0	0.877	0.928	0.040			25	9.5	40			40			1	9486	34.958	35.50	35.30	35.20	6.67	0.04	6.6	6.6	0.2	0.2	0.43	1.27	01
2/2	03/2	TYPE 2 FIELD INLET 600x600 GRATE								0.00			25	9.3	0			0				9292	34.950	35.11	35.09	35.07	0.18	0.06	0.2	0.2	0.0	0.0	0.45	1.37	02
3/2	04/2	TYPE 1 FIELD INLET 900x900 GRATE											25	2.4	0			0				2387	35.750	35.07	35.05	35.00	1.57	0.07	0.3		0.0		0.57	1.37	03
1/2	05/2	TYPE 1 FIELD INLET 900x900 GRATE	1	3					1//	V 3			25	0.8	0	0 3		0			()	0828	35.750	35.00	34.96	34.70	0.96	0.10	0.3	0.3	0.0	0.0	0.76	1.83	0.4
/2	06/2	TYPE 1 FIELD INLET 900x900 GRATE											25	4.2	0			0				4200	35.500	34.59	34.55	33.62	6.25	0.11	0.3		0.0		0.29	3.65	0.5
6/2	07/2	HEADWALL	1			1							25	6.6	0	1		0				6639	33.715	33.62	33.62	33.62	0.00	0.11	0.0	0.0	0.0	0.0		000000	0.6
//2	08/2	BASIN NODE FOR CALCULATIONS											25	9.9	0			0				9.883	33.000	33.62	33.62	33.62	0.00	0.10	0.0	0.0	0.0	0.0			07
3/2	09/2	CALCULATION PURPOSES											25	8.9	0			0				8925	33.425	33.62	33.62	33.43	18.07	0.10	0.0	0.8	0.0	0.9	19.51	4.64	0.8
9/2	10/2	TYPE 1 FIELD INLET 900x900 GRATE	0.013	8		120	134.0	0.877	0.928	0.008			25	8.9	8			8			-	8925	34.400	30.96	30.85	28.48	19.87	0.11	2.1	2.7	0.1	0.1	0.1	4.37	09
0/2	03/1	HEADWALL											25		0			0					29.065	28.42	28.42	28.07	2.53	0.11	0.0	0.0	0.0	0.0	0.09	0.72	10
1/3	05/2	%%C225 RISER (EXTEND 300mm ABOVE FSL)	0.029			120	134.0	0.877	0.928	0.018			25	4.2	18			18				4200	35.600	34.84	34.70	34.59	11.10	0.02	6.2	6.2	0.1	0.2	0.57	1.22	01
1/4	04/2	%%C225 RISER (EXTEND 300mm ABOVE FSL)	0.040	ý.		120	134.0	0.877	0.928	0.025			25	0.8	25	- 1		25				0828	36,100	35.25	35.11	35.00	11.30	0.02	4.4	4.4	0.1	0.2	0.77	1.37	01
1/5	03/2	%%C225 RISER EXTEND 300mm ABOVE FSL)	0.025			120	134.0	0.877	0.928	0.016			25	2.4	16			16				2387	36.100	35.22	35.08	35.07	0.70	0.02	6.8	6.8	0.1	0.1	0.5	0.89	01
11/6	02/2	%%C225 RISER (EXTEND 300mm ABOVE FSL)	0.027			120	134.0	0.877	0.928	0.017			25	9.3	17			17				9292	35.300	35.31	35.17	35.11	6.00	0.02	6.8	6.8	0.1	0.2	0.53	1.02	01
1/7	09/2	CALCULATION PURPOSES		3									25	8.9	0			0				8925	34.500	34.40	34.40	34.40	0.09	0.00	0.0	0.0	0.0	0.0	0	0	01
1/8	09/2	CALCULATION PURPOSES											25	8.9	0			0				8925	34.075	33.95	33.95	33.95	0.00	0.00	0.0	0.0	0.0	0.0	0	0	01
3/2	04/2	TYPE 1 FIELD INLET 900x900 GRATE		-						9			25	2.4	0			0				2387	35.750	35.07	35.05	35.00	1.57	0.07	0.3	0.3	0.0	0.0	0.57	1.37	03
1/6	02/2	%%C225 RISER (EXTEND 300mm ABOVE FSL)	0.027			120	134.0	0.877	0.928	0.017			25	9.3	17			17				9292	35.300	35.31	35.17	35.11	6.00	0.02	6.8	6.8	0.1	0.2	0.53	1.02	01
2/2	03/2	TYPE 2 FIELD INLET 600x600 GRATE				100000000	2001117(0)	-					25	9.3	0			0				9.292	34.950	35.11	35.09	35.07	0.18	0.06	0.2	0.2	0.0	0.0	0.45	1.37	02
1/2	08/2	BASIN NODE FOR CALCULATIONS											25	9.9	0			0				9883	33.000	33.62	33.62	33.62	0.00	0.10	0.0	0.0	0.0	0.0			07
17	09/2	CALCULATION PURPOSES					33777						25	8.9	0			0				8925	34,500	34.40	34.40	34.40	0.09	0.00	0.0	0.0	0.0	0.0	0	0	01
V2	10/2	TYPE 1 FIELD INLET 900x900 GRATE	0.013			120	134.0	0.877	0.928	0.008			25	8.9	8			8				8925	34.400	30.96	30.85	28.48	19.87	0.11	2.1	2.7	0.1	0.1	0.1	4.37	09
12	08/2	BASIN NODE FOR CALCULATIONS		3									25	9.9	0			0				9883	33.000	33.62	33.62	33.62	0.00	0.10	0.0	0.0	0.0	0.0			0
1/8	09/2	CALCULATION PURPOSES											25	8.9	0			0				8925	34.075	33.95	33.95	33.95	0.00	0.00	0.0	0.0	0.0	0.0	0	0	01
1/2	10/2	TYPE 1 FIELD INLET 900x900 GRATE	0.013	3		120	134.0	0.877	0.928	0.008			25	8.9	8			8				8925	34.400	30.96	30.85	28.48	19.87	0.11	2.1	2.7	0.1	0.1	0.1	4.37	05

PLANS AND DOCUMENTS referred to in the DEVELOPMENT APPROVAL

Application No: OPW/2019/1241

Dated: 28 October 2019

Development shall comply with the conditions of approval as detailed in the Decision Notice and Council's Planning Scheme, Local Laws and Planning Policies

INTE	NSITY - FREQ	UENCY	' - DUR	ATION	(IFD) 1	TABLE		
DURATION		Α	RI INT	ENSITY	(YEAR	t)		
MINUTES	TREAT	1	2	5	10	20	50	100
5	63.5	127.0	160.0	195.0	214.0	241.0	276.0	302.0
6	59.5	119.0	150.0	183.0	201.0	226.0	259.0	284.0
10	48.6	97.1	123.0	150.0	166.0	187.0	214.0	235.0
20	35.7	71.3	90.3	111.0	123.0	139.0	159.0	175.0
30	29.1	58.1	73.8	91.0	101.0	114.0	131.0	144.0
60	19.7	39.3	50.0	62.2	69.1	78.6	91.0	100.0
120	12.6	25.2	32.2	40.6	45.4	52.0	60.5	67.0
180	9.6	19.1	24.5	31.2	35.1	40.3	47.1	52.3
360	5.9	11.8	15.3	19.8	22.4	25.9	30.6	34.2
 l n	FRIVED FROM	1 RURE	ΔII OF	METEC	ROLO	GΥ		

NOTE:

1. THESE CALCULATIONS ARE BASED ON IISAX2 DYNAMIC DRAINAGE ANALYSIS USING

2. INDIVIDUAL TIMES OF CONCENTRATION ARE GENERATED FOR EACH NODE & CATCHMENT TYPE USING TEMPORAL PATTERNS DETERMINED FROM THE RELEVANT AUTHORITY.

3. "TREAT" IN THE IFD TABLE REFERS TO 0.5x1 YEAR ARI, USED TO DETERMINE WATER QUALITY TREATMENT FLOWS.

4. CATCHMENT 1 REFERS TO TYPICAL URBANISED CATCHMENTS WITH LOTS <1000m2. THE IMPERVIOUS PORTION OF THE CATCHMENT TIME OF CONCENTRATION (TC) IS TYPICALLY 5 MINUTES & THE PERVIOUS PORTION OF THE CATCHMENT TYPICALLY HAS AN 8 MINUTE TC.


5. CATCHMENT 2 IS TYPICALLY USED TO MODEL LOTS >1000m2, WITH INDIVIDUAL PERCENTAGES OF IMPERVIOUS SURFACE & TC'S.

6. CATCHMENT 3 IS TYPICALLY USED TO MODEL OPEN SPACE & RURAL CATCHMENTS WITH INDIVIDUAL PERCENTAGES OF IMPERVIOUS SURFACE & TC'S.

	KR	LANE	1/2 RD	1 WAY	2 WAY
MAX. WIDTH	1.0	2.5	3.75	11.175	14.8
MAX. AREA m2	0.021	0.101	0.219	1.421	2.104
Rd Grade %					
0.5	0.032	0.092	0.209	1.938	3.070
1	0.046	0.130	0.296	2.054	2.950
2	0.064	0.184	0.418	2.150	2.920
3	0.079	0.225	0.512	1.886	2.780
4	0.091	0.260	0.591	1.711	2.650
5	0.102	0.291	0.661	1.600	2.510
6	0.112	0.318	0.724	1.505	2.390
7	0.120	0.344	0.782	1.407	2,300
8	0.129	0.368	0.836	1.345	2.230
9	0.137	0.390	0.887	1.285	2.170
10	0.144	0.411	0.935	1.220	2.110
11	0.151	0.431	0.981	1.180	2.110
12	0.158	0.450	1.024	1.154	2.110
13	0.164	0.469	1.066	1.133	2.090
14	0.170	0.486	1.106	1.105	2.060
15	0.176	0.503	1.101	1.101	2.060
16	0.182	0.520	1.093	1.093	2.030

FLOW CONSTRAINED TO 0.4 DxV

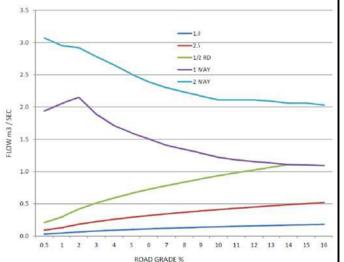FLOW CONSTRAINED TO 250mm DEEP MAX.
CAPACITY COMPOUND CROSS SECTION (ARR 1987 , 4.38) (n varies)



PROJECT NAME

DONINGTON DRIVE RESIDENTIAL

CIVILWORKS

R P D E S C R I P T I O N

Lot 3 on SP275769

DONINGTON DRIVE

LOCALITY OF OXENFORD

LOCAL AUTHORITY - CITY OF GOLD COAST

CLIENT

TELLURIUM GG Pty Ltd

	J J U L	-	U A . L						
TEND	ER								
COUN	CIL		26-08-19						
CONS	TRUCTION								
В	B 03-10-19 TABLES AMENDED								
Α	26-08-19	COUNCIL IS	SUE						
PRE	DATE		AMENDMENT	·					
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A S S O C I A T E D C O N S U L T A N T S



DRAWING TITLE

STORMWATER
CALCULATION TABLES
MINOR & MAJOR STORM EVENT
SHEET 01

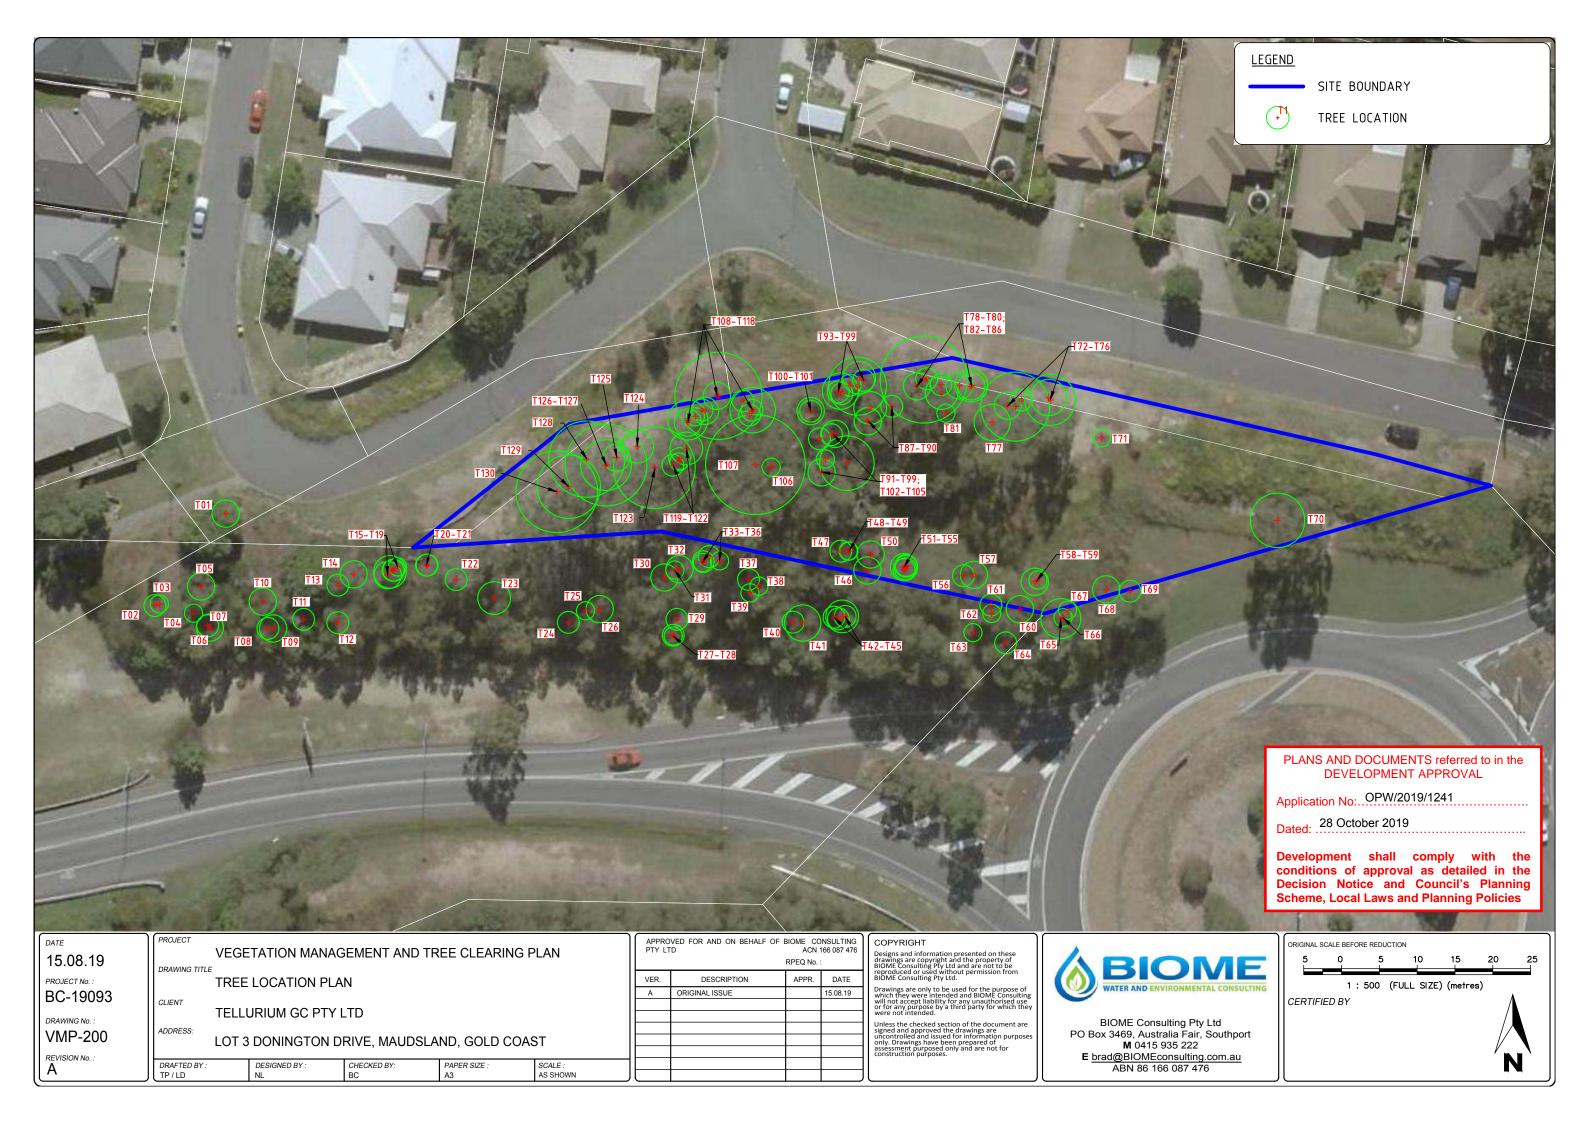


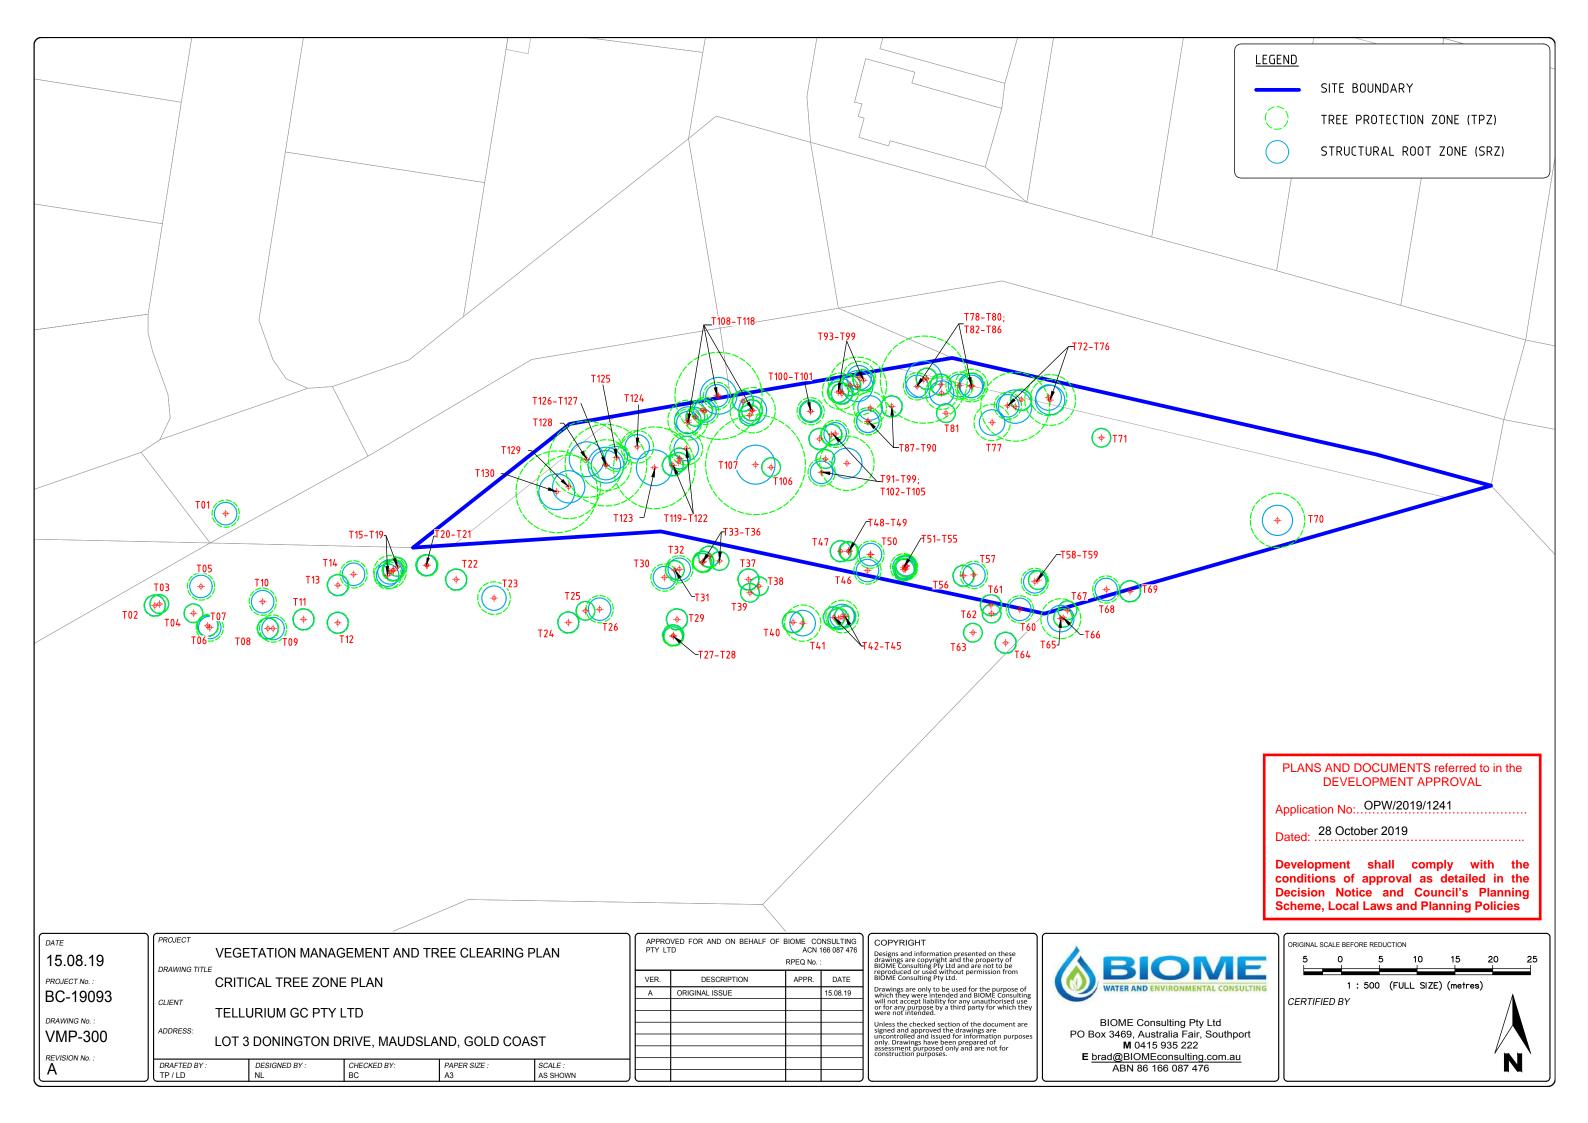
MUS Pty Ltd T/As: Mortons-Urban Solutions ABN: 39 116 375 065 mortons@urbansolutions.net.au www.urbansolutions.net.au Tel 07 5571 1099 Postal Addres PO Box 248 Southport QLD 421

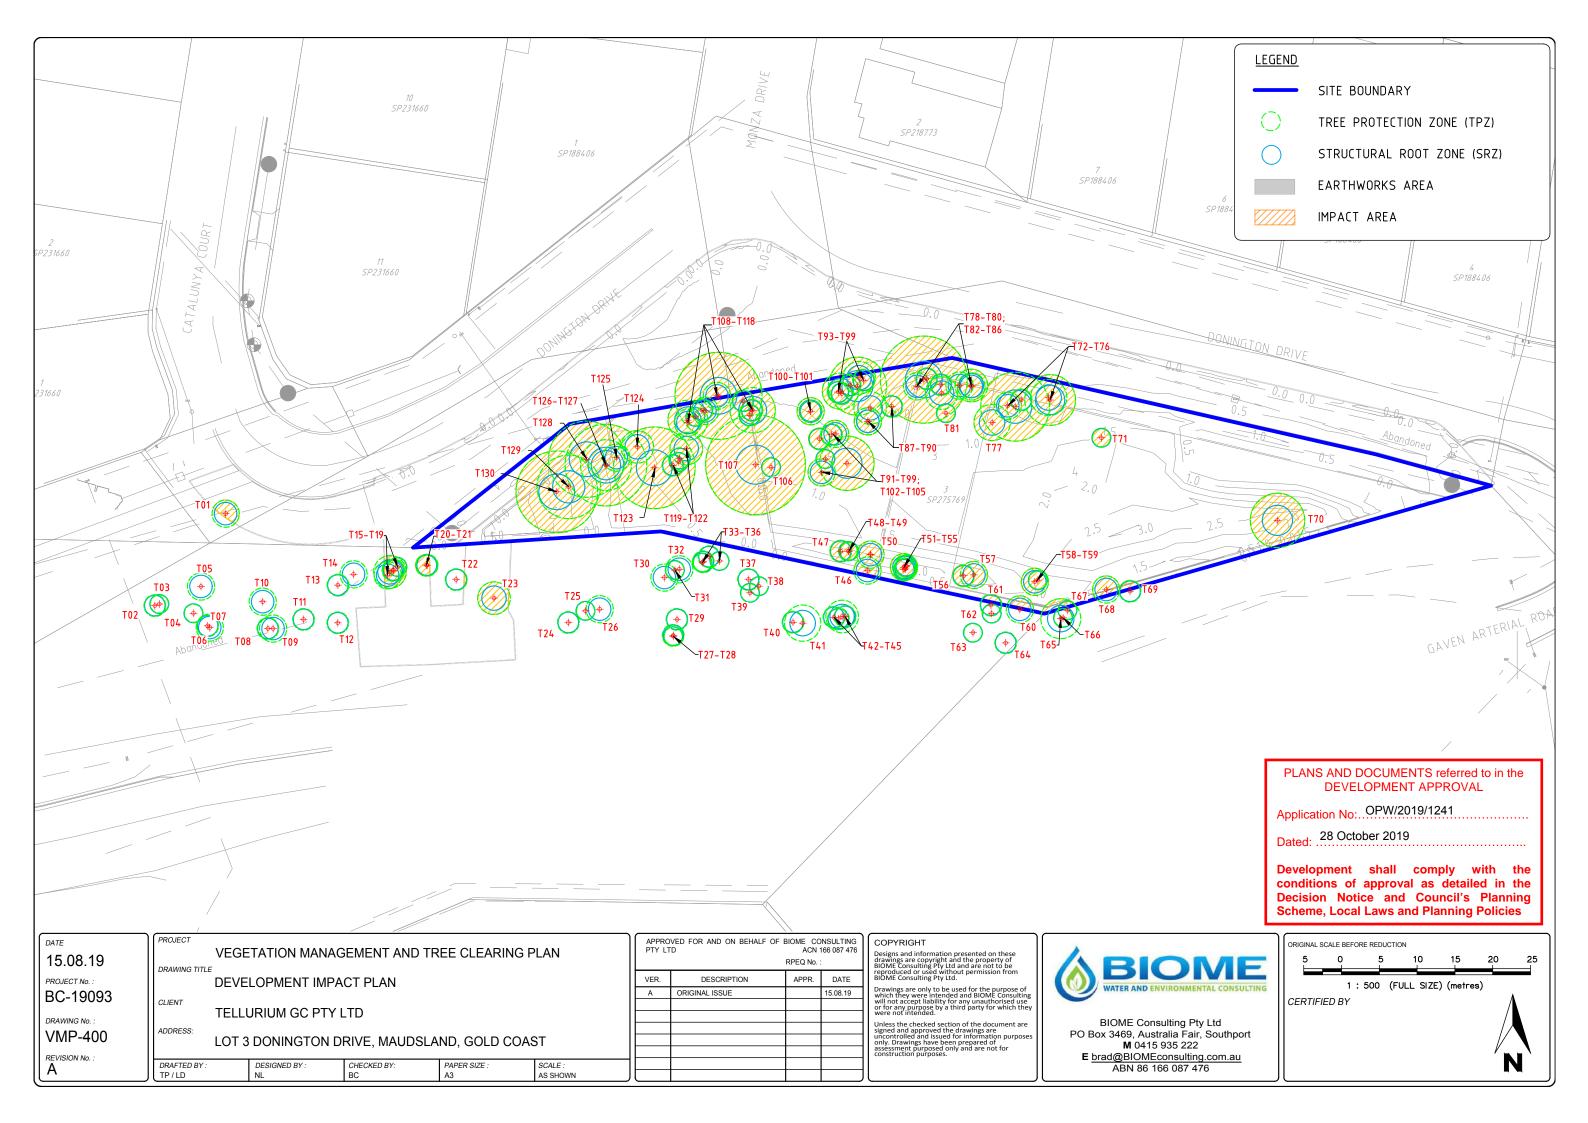
Gold Coast Office Suite 9, 19 Short St Southport QLD 4215

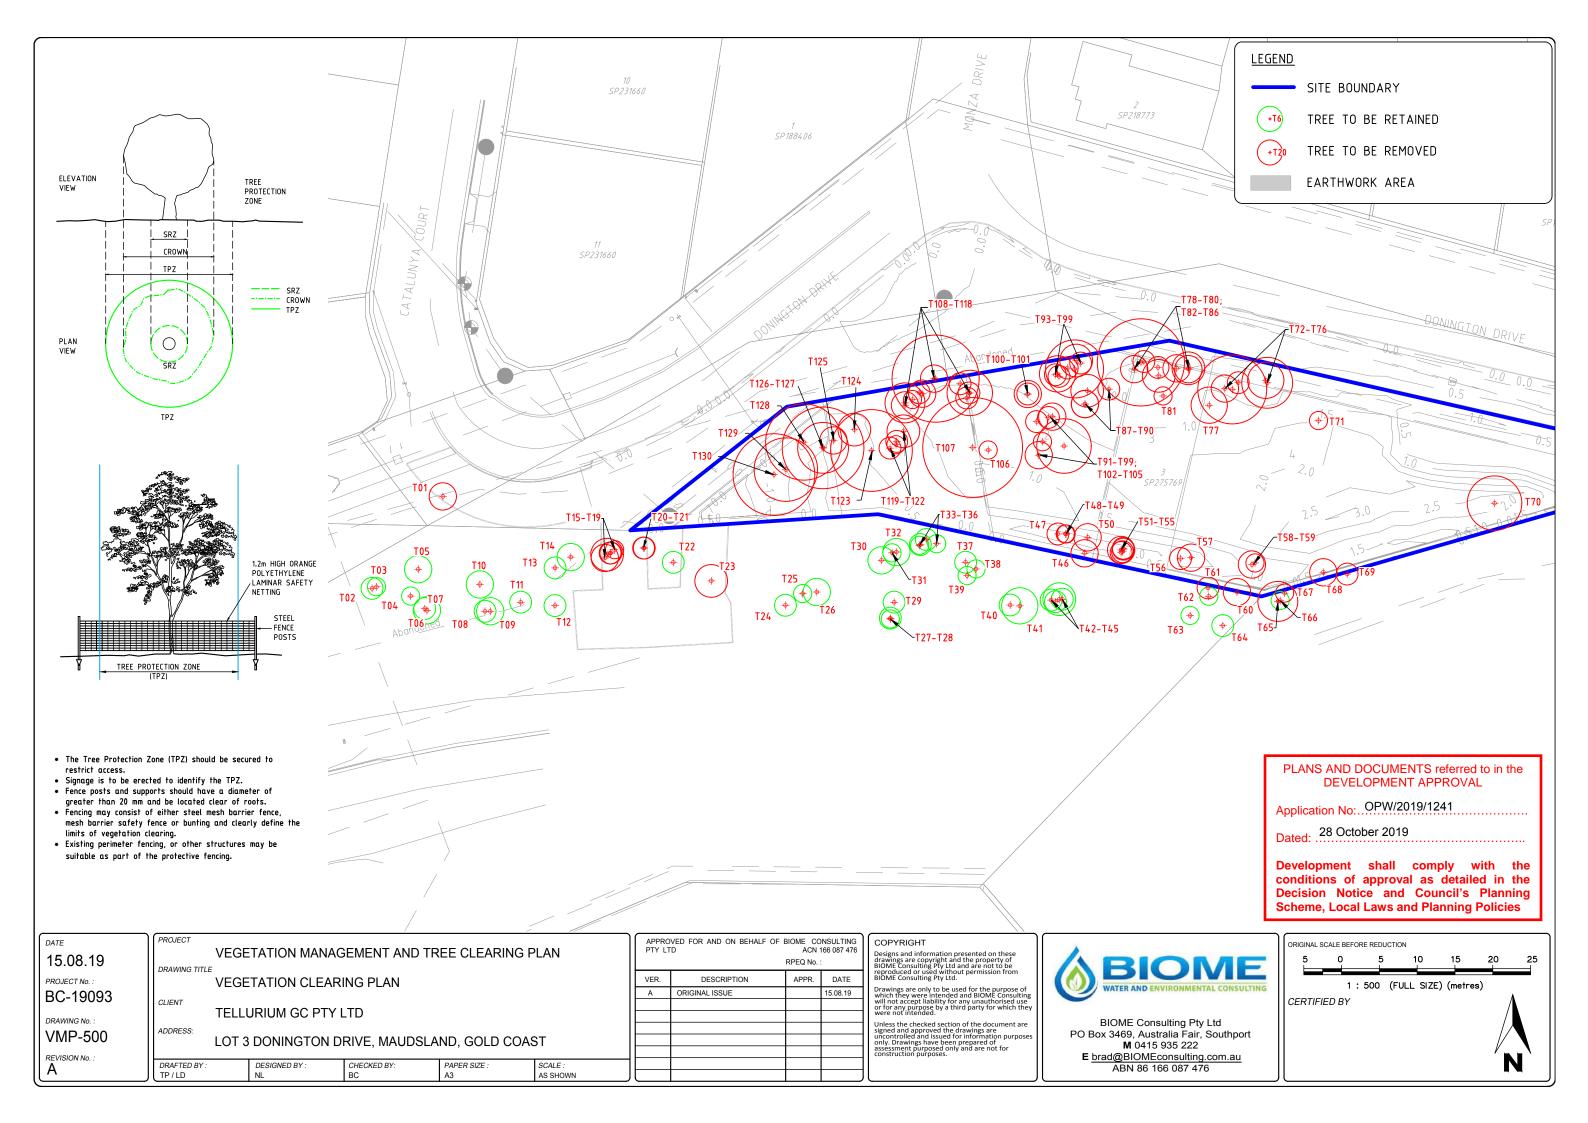
DESIGNED RB DRAWN EP

APPROVED ARE OF THE OFFICE OF









No.	Scientific	DHB(cm)	Height(m)	SRZ (m)	TPZ (m)	Tree Works
T1	Acacia disparrima	15	7	1.49	1.80	Removed - Impacted by earthworks
T2	Acacia disparrima	12	6	1.36	1.44	Retained
Т3	Acacia disparrima	10	7	1.26	1.20	Retained
T4	Acacia disparrima	10	6	1.26	1.20	Retained
T5	Eucalyptus siderophloia	15	9	1.49	1.80	Retained
T6	Eucalyptus siderophloia	15	9	1.49	1.80	Retained
Т7	Corymbia intermedia	12	9	1.36	1.44	Retained
Т8	Allocasuarina littoralis	12	9	1.36	1.44	Retained
Т9	Angophora leiocarpa	15	8	1.49	1.80	Retained
T10	Angophora leiocarpa	15	10	1.49	1.80	Retained
T11	Angophora leiocarpa	12	9	1.36	1.44	Retained
T12	Corymbia intermedia	12	9	1.36	1.44	Retained
T13	Allocasuarina littoralis	12	8	1.36	1.44	Retained
T14	Angophora leiocarpa	15	10	1.49	1.80	Retained
T15	Eucalyptus siderophloia	15	9	1.49	1.80	Removed - Impacted by earthworks
T16	Eucalyptus siderophloia	18	10	1.61	2.16	Removed - Impacted by earthworks
T17	Acacia disparrima	12	7	1.36	1.44	Removed - Impacted by earthworks
T18	Corymbia intermedia	12	9	1.36	1.44	Removed - Impacted by earthworks
T19	Corymbia intermedia	10	7	1.26	1.20	Removed - Impacted by earthworks
T20	Eucalyptus siderophloia	12	8	1.36	1.44	Removed - Impacted by earthworks
T21	Corymbia intermedia	12	8	1.36	1.44	Removed - Impacted by earthworks
T22	Eucalyptus siderophloia	12	8	1.36	1.44	Retained
T23	Eucalyptus siderophloia	18	11	1.61	2.16	Removed - Impacted by earthworks
T24	Corymbia intermedia	12	8	1.36	1.44	Retained
T25	Eucalyptus siderophloia	10	8	1.26	1.20	Retained
T26	Eucalyptus siderophloia	15	10	1.49	1.80	Retained
T27	Eucalyptus siderophloia	10	8	1.26	1.20	Retained
T28	Eucalyptus siderophloia	12	9	1.36	1.44	Retained
T29	Eucalyptus siderophloia	12	9	1.36	1.44	Retained
T30	Eucalyptus siderophloia	15	9	1.49	1.80	Retained
T31	Eucalyptus siderophloia	10	8	1.26	1.20	Retained
T32	Standing dead wood	15	10	1.49	1.80	Retained
T33	Acacia disparrima	10	8	1.26	1.20	Retained

No.	Scientific	DHB(cm)	Height(m)	SRZ (m)	TPZ (m)	Tree Works
T34	Eucalyptus siderophloia	12	9	1.36	1.44	Retained
T35	Eucalyptus siderophloia	12	9	1.36	1.44	Retained
T36	Eucalyptus acmenoides	10	8	1.26	1.20	Retained
T37	Corymbia intermedia	12	9	1.36	1.44	Retained
T38	Allocasuarina littoralis	10	8	1.26	1.20	Retained
T39	Acacia disparrima	10	8	1.26	1.20	Retained
T40	Allocasuarina littoralis	12	9	1.36	1.44	Retained
T41	Allocasuarina littoralis	20	9	1.68	2.40	Retained
T42	Allocasuarina littoralis	12	9	1.36	1.44	Retained
T43	Acacia disparrima	12	8	1.36	1.44	Retained
T44	Angophora leiocarpa	18	11	1.61	2.16	Retained
T45	Acacia disparrima	12	9	1.36	1.44	Retained
T46	Angophora leiocarpa	15	10	1.49	1.80	Removed - Impacted by earthworks
T47	Allocasuarina littoralis	12	7	1.36	1.44	Removed - Impacted by earthworks
T48	Eucalyptus acmenoides	10	8	1.26	1.20	Removed - Impacted by earthworks
T49	Eucalyptus acmenoides	10	8	1.26	1.20	Removed - Impacted by earthworks
T50	Acacia disparrima	15	8	1.49	1.80	Removed - Impacted by earthworks
T51	Allocasuarina littoralis	12	7	1.36	1.44	Removed - Impacted by earthworks
T52	Allocasuarina littoralis	12	7	1.36	1.44	Removed - Impacted by earthworks
T53	Allocasuarina littoralis	15	8	1.49	1.80	Removed - Impacted by earthworks
T54	Allocasuarina littoralis	12	8	1.36	1.44	Removed - Impacted by earthworks
T55	Acacia disparrima	12	8	1.36	1.44	Removed - Impacted by earthworks
T56	Allocasuarina littoralis	12	8	1.36	1.44	Removed - Impacted by earthworks
T57	Allocasuarina littoralis	15	7	1.49	1.80	Removed - Impacted by earthworks
T58	Allocasuarina littoralis	10	8	1.26	1.20	Removed - Impacted by earthworks
T59	Allocasuarina littoralis	15	9	1.49	1.80	Removed - Impacted by earthworks
T60	Corymbia intermedia	15	9	1.49	1.80	Removed - Impacted by earthworks
T61	Allocasuarina littoralis	12	7	1.36	1.44	Removed - Impacted by earthworks
T62	Corymbia intermedia	10	8	1.26	1.20	Retained
T63	Allocasuarina littoralis	10	7	1.26	1.20	Retained
T64	Acacia disparrima	12	7	1.36	1.44	Retained
T65	Eucalyptus siderophloia	22	11	1.75	2.64	Removed —Impacted by earthworks
T66	Acacia melanoxylon	10	7	1.26	1.20	Retained

DATE
15.08.19
PROJECT No.:
BC-19093
DRAWING No.:
VMP-600
REVISION No.:

VEGETATION MANAGEMENT AND TREE CLEARING PLAN

DRAWING TITLE

TREE INFORMATION TABLE - 1

TELLURIUM GC PTY LTD

ADDRESS:

CLIENT

LOT 3 DONINGTON DRIVE, MAUDSLAND, GOLD COAST

SCALE : AS SHOWN

 DRAFTED BY:
 DESIGNED BY:
 CHECKED BY:
 PAPER SIZE:

 TP / LD
 NL
 BC
 A3

PTY LT			166 087 476
VER.	DESCRIPTION	APPR.	DATE
Α	ORIGINAL ISSUE		15.08.19

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ABN 86 166 087 476

PLANS AND DOCUMENTS referred to in the DEVELOPMENT APPROVAL

Application No: OPW/2019/1241

Dated: 28 October 2019

Development shall comply with the conditions of approval as detailed in the Decision Notice and Council's Planning Scheme, Local Laws and Planning Policies

No.	Scientific	DHB(cm)	Height(m)	SRZ (m)	TPZ (m)	Tree Works
T67	Allocasuarina littoralis	10	8	1.26	1.20	Removed - Impacted by earthworks
T68	Angophora leiocarpa	15	11	1.49	1.80	Removed - Impacted by earthworks
T69	Acacia disparrima	12	7	1.36	1.44	Removed - Impacted by earthworks
T70	Eucalyptus siderophloia	30	12	2.00	3.60	Removed - Impacted by earthworks
T71	Eucalyptus siderophloia	10	8	1.26	1.20	Removed - Impacted by earthworks
T72	Angophora leiocarpa	28	12	1.94	3.36	Removed - Impacted by earthworks
T73	Angophora leiocarpa	20	12	1.68	2.40	Removed - Impacted by earthworks
T74	Corymbia intermedia	12	9	1.36	1.44	Removed - Impacted by earthworks
T75	Angophora leiocarpa	38	14	2.20	4.56	Removed - Impacted by earthworks
T76	Eucalyptus siderophloia	15	10	1.49	1.80	Removed - Impacted by earthworks
T77	Corymbia intermedia	20	11	1.68	2.40	Removed - Impacted by earthworks
T78	Acacia disparrima	18	7	1.61	2.16	Removed - Impacted by earthworks
T79	Eucalyptus acmenoides	15	8	1.49	1.80	Removed - Impacted by earthworks
T80	Corymbia intermedia	15	10	1.49	1.80	Removed - Impacted by earthworks
T81	Corymbia intermedia	10	8	1.26	1.20	Removed - Impacted by earthworks
T82	Eucalyptus acmenoides	18	9	1.61	2.16	Removed - Impacted by earthworks
T83	Acacia disparrima	12	7	1.36	1.44	Removed - Impacted by earthworks
T84	Angophora leiocarpa	12	6	1.36	1.44	Removed - Impacted by earthworks
T85	Angophora leiocarpa	48	15	2.43	5.76	Removed - Impacted by earthworks
T86	Acacia disparrima	15	8	1.49	1.80	Removed - Impacted by earthworks
T87	Standing dead wood	12	7	1.36	1.44	Removed - Impacted by earthworks
T88	Eucalyptus acmenoides	18	10	1.61	2.16	Removed - Impacted by earthworks
T89	Corymbia intermedia	15	7	1.49	1.80	Removed - Impacted by earthworks
T90	Corymbia intermedia	15	9	1.49	1.80	Removed - Impacted by earthworks
T91	Eucalyptus siderophloia	30	14	2.00	3.60	Removed - Impacted by earthworks
T92	Acacia disparrima	15	8	1.49	1.80	Removed - Impacted by earthworks
T93	Eucalyptus acmenoides	12	6	1.36	1.44	Removed - Impacted by earthworks
T94	Eucalyptus acmenoides	18	9	1.61	2.16	Removed - Impacted by earthworks
T95	Corymbia intermedia	32	13	2.05	3.84	Removed - Impacted by earthworks
T96	Eucalyptus acmenoides	12	9	1.36	1.44	Removed - Impacted by earthworks
T97	Eucalyptus acmenoides	12	9	1.36	1.44	Removed - Impacted by earthworks
Т98	Eucalyptus acmenoides	12	9	1.36	1.44	Removed - Impacted by earthworks

No.	Scientific	DHB(cm)	Height(m)	SRZ (m)	TPZ (m)	Tree Works
T99	Eucalyptus acmenoides	20	10	1.68	2.40	Removed - Impacted by earthworks
T100	Acacia disparrima	15	8	1.49	1.80	Removed - Impacted by earthworks
T101	Acacia disparrima	12	10	1.36	1.44	Removed - Impacted by earthworks
T102	Acacia disparrima	12	9	1.36	1.44	Removed - Impacted by earthworks
T103	Acacia disparrima	12	10	1.36	1.44	Removed - Impacted by earthworks
T104	Allocasuarina littoralis	10	8	1.26	1.20	Removed - Impacted by earthworks
T105	Corymbia intermedia	15	9	1.49	1.80	Removed - Impacted by earthworks
T106	Corymbia intermedia	10	7	1.26	1.20	Removed - Impacted by earthworks
T107	Eucalyptus acmenoides	55	15	2.57	6.60	Removed - Impacted by earthworks
T108	Acacia disparrima	12	8	1.36	1.44	Removed - Impacted by earthworks
T109	Acacia disparrima	12	8	1.36	1.44	Removed - Impacted by earthworks
T110	Angophora leiocarpa	25	12	1.85	3.00	Removed - Impacted by earthworks
T111	Eucalyptus acmenoides	12	8	1.36	1.44	Removed - Impacted by earthworks
T112	Eucalyptus siderophloia	15	10	1.49	1.80	Removed - Impacted by earthworks
T113	Angophora leiocarpa	48	16	2.43	5.76	Removed - Impacted by earthworks
T114	Angophora leiocarpa	12	7	1.36	1.44	Removed - Impacted by earthworks
T115	Corymbia intermedia	15	10	1.49	1.80	Removed - Impacted by earthworks
T116	Corymbia intermedia	10	6	1.26	1.20	Removed - Impacted by earthworks
T117	Corymbia intermedia	22	11	1.75	2.64	Removed - Impacted by earthworks
T118	Eucalyptus acmenoides	15	10	1.49	1.80	Removed - Impacted by earthworks
T119	Angophora leiocarpa	18	10	1.61	2.16	Removed - Impacted by earthworks
T120	Eucalyptus acmenoides	12	8	1.36	1.44	Removed - Impacted by earthworks
T121	Eucalyptus acmenoides	10	7	1.26	1.20	Removed - Impacted by earthworks
T122	Corymbia intermedia	12	8	1.36	1.44	Removed - Impacted by earthworks
T123	Eucalyptus acmenoides	45	10	2.37	5.40	Removed - Impacted by earthworks
T124	Corymbia intermedia	18	11	1.61	2.16	Removed - Impacted by earthworks
T125	Corymbia intermedia	15	10	1.49	1.80	Removed - Impacted by earthworks
T126	Eucalyptus siderophloia	28	18	1.94	3.36	Removed - Impacted by earthworks
T127	Eucalyptus acmenoides	45	9	2.37	5.40	Removed - Impacted by earthworks
T128	Eucalyptus siderophloia	42	18	2.30	5.04	Removed - Impacted by earthworks
T129	Corymbia intermedia	35	12	2.13	4.20	Removed - Impacted by earthworks
T130	Eucalyptus acmenoides	45	14	2.37	5.40	Removed - Impacted by earthworks

15.08.19 PROJECT No. : BC-19093 DRAWING No. : VMP-601 REVISION No. :

VEGETATION MANAGEMENT AND TREE CLEARING PLAN DRAWING TITLE

TREE INFORMATION TABLE - 2

CLIENT TELLURIUM GC PTY LTD

ADDRESS:

LOT 3 DONINGTON DRIVE, MAUDSLAND, GOLD COAST

DRAFTED BY : TP / LD DESIGNED BY : NL CHECKED BY: BC PAPER SIZE : A3 SCALE : AS SHOWN

APPRO PTY LT	=		166 087 476
VER.	DESCRIPTION	APPR.	DATE
Α	ORIGINAL ISSUE		15.08.19

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BIOME Consulting Pty Ltd PO Box 3469, Australia Fair, Southport

M 0415 935 222 E brad@BIOMEconsulting.com.au ABN 86 166 087 476 PLANS AND DOCUMENTS referred to in the DEVELOPMENT APPROVAL

Application No: OPW/2019/1241

Dated: 28 October 2019

Development shall comply with the conditions of approval as detailed in the **Decision Notice and Council's Planning** Scheme, Local Laws and Planning Policies

Date: 12 November 2019
Contact: Craig Morse
Location: City Development
Telephone: 07 5582 8866

Your reference:

Our reference: OPW/2019/1257



Robin Russell & Associates Pty. Ltd. C/- Tania Deller UNIT 204 / 6 Babarra St STAFFORD QLD 4053

Dear Sir/Madam

Decision Notice

Property description Lot 3 SP275769

Property location Lot 3 Gaven Arterial Road, MAUDSLAND QLD 4210

Application details Operational Works

Please find enclosed the decision notice for the proposed development identified above.

For further information regarding the assessment of this application, access the Planning and Development page on City of Gold Coast's website <u>cityofgoldcoast.com.au</u> and reference application number OPW/2019/1257.

If you are unable to access the website, please email your query to mail@goldcoast.qld.gov.au and reference your application number.

Contacting us

Should you wish to clarify any issues contained in this letter, please do not hesitate to contact Planning Assessment on 07 5582 8866.

Yours sincerely

City Development Branch
Planning & Environment Directorate
For the Chief Executive Officer
Council of the City of Gold Coast

Our reference: OPW/2019/1257

Decision notice— approval (with conditions)

(Given under section 63(2) of the Planning Act 2016)

Date of decision notice: 11 November 2019

Applicant details

Applicant name: Robin Russell & Associates Pty. Ltd.

Applicant contact details: C/- Tania Deller

UNIT 204 / 6 Babarra St STAFFORD QLD 4053

Application details

Application number: OPW/2019/1257

Approval sought: Development permit for Operational work

Details of proposed

development:

Operational work for Electrical Reticulation

Location details

Street address: Lot 3 Gaven Arterial Road, Maudsland Qld 4210

Real property description: Lot 3 SP275769

Decision

Date of decision 11 November 2019

Decision details: Under Delegated Authority, the Executive Coordinator for Engineering

and Environmental Assessment has resolved to approve the

development application in full with conditions.

Referral agency(s) for the application

Not applicable – no part of the application required referral.

Details of the approval

Development permit Operational work for Electrical Reticulation

Conditions

The conditions that have been imposed by Council, as Assessment manager, are enclosed.

Properly made submissions

Not applicable—No part of the application required public notification.

Currency period for the approval (section 85 of the Planning Act 2016)

In accordance with section 85 of the *Planning Act 2016*, this approval has a currency period of two years.

Approved plans and drawings

Approved plans and drawings are attached and are identified in the conditions imposed by Council as the Assessment manager.

Appeal rights

Applicant

You have appeal rights in relation to this decision. An appeal may be made against, as applicable:

- the refusal of part of the development application; or
- · a provision of the development approval; or
- if a development permit was applied for, the decision to give a preliminary approval.

An appeal must be started within 20 business days after this notice is given to you.

An appeal may be made to the Planning and Environment Court or, for certain matters which are identified in section 1(2) of Schedule 1 of the *Planning Act 2016*, to a development tribunal.

An appeal is started by lodging a notice of appeal with the registrar of the Planning and Environment Court or a development tribunal, as applicable. The notice of appeal must be in the approved form, succinctly state the grounds of the appeal and be accompanied by the required fee.

An appellant to the Planning and Environment Court must give a copy of the notice of appeal, within 10 business days after the appeal is started, to the persons identified in section 230(3) of the *Planning Act 2016.* A person who is appealing to the Planning and Environment Court must comply with the rules of the court that apply to the appeal.

An extract of Chapter 6, Part 1 and Schedule 1 of the *Planning Act* 2016 is attached to this notice, which sets out further information about the appeal rights.

For further information please contact Craig Morse, Civil Engineer on p: 07 5582 8866 or via email mail@goldcoast.qld.gov.au who will be pleased to assist.

AUTHORISED BY

Sam Hartley

Executive Coordinator Engineering & Environmental Assessment

For the Chief Executive Officer
Council of the City of Gold Coast

Enc:

Conditions imposed by Council as Assessment manager

Attach:

Stamped approved plans and drawings Appeal rights extract

General

1. Timing

All conditions of this development approval must be complied with at no cost to Council at all times unless otherwise stated in another condition.

2. Approved drawings

Undertake and maintain the development generally in accordance with the following drawings including as amended in red by the Council:

Operational Works											
Drawing Title	Author	Date	Drawing No.	Ver							
Electricity Reticulation – Community titles	Robin Russell	28/08/19	D134-01A – 1	A							
Electricity Reticulation – Community titles	Robin Russell	28/08/19	D134-01A – 2	A							

The conditions of this approval are to be read in conjunction with the attached stamped approved drawings. Where a conflict occurs between the conditions of this approval and the stamped approved drawings, the conditions of this approval shall take precedence.

Engineering

3. Rectification of Council's infrastructure

Rectify any damage caused to Council infrastructure (including kerb, channelling, service pits, footpaths and water and sewer reticulation networks) at all times, at no cost to Council.

Electrical Reticulation

4. Construction of electrical and lighting reticulation

- a. All existing underground services are to be located prior to the commencement of construction.
- b. If no conduits exist, road crossings are to be bored.
- c. In accordance with section 6.11 of City Plan Policy Land Development Guidelines, Standard Specifications and Drawings conflict between water service points and electrical distribution pillars at a common boundary is not permitted. Prior to the installation of electrical distribution pillars, a comparison with proposed water service connection points must be made to ensure that no conflict at a common boundary occurs. Council will not issue a compliance certificate for the subdivision plan until any conflicts are rectified.
- d. Roads and verge areas are to be reinstated to the satisfaction of the Chief Executive Officer, at no cost to Council.

5. Approval required from electricity supplier

a. The applicant must obtain approval from an authorised electricity supplier (eg. ENERGEX) for the electrical reticulation. In seeking that approval, the applicant must submit to the electricity supplier a copy of this decision notice, together with the stamped approved plans/drawings.

6. Electricity supply

- In supplying power to the site, no additional poles and/or pole-mounted transformers are to be erected.
- b. Prior to Council's compliance assessment of subdivision plans, submit to Council a copy of the 'Certificate of Supply' from an authorised electricity supplier (e.g. ENERGEX) as evidence that underground electricity supply is available to all proposed lots.

Advice Notes

A. Consistency with other related approvals

The assessment and approval of the operational work the subject of this permit, has been attended to having regard to the conditions of MCU/2017/1129 PN349822/12/DA1 dated 1 May 2018. Should any change to any of these approvals be sought and achieved, consideration by the applicant should also be had to the consequences on the related approvals (and the potential need to make subsequent changes to these related approvals).

B. Compliance with conditions

Once this development approval takes effect, the conditions attach to the land and are applicable in perpetuity. It is a development offence to contravene a development approval, including any of its conditions.

C. Development infrastructure

Development infrastructure required to be provided in implementing this development approval is non-trunk development infrastructure unless otherwise stated in a condition of the approval.

D. | Encroachment of works

If any operational works, the subject of this approval encroaches on adjoining land, a letter from the adjoining owner must be submitted to Council consenting to the carrying out of these works.

E. Fire ant control

Northern suburbs of the Gold Coast are within Fire Ant Biosecurity zone 2 and must remain vigilant for the presence of fire ants. Under the Biosecurity Act 2014 individuals and organisations whose activities involve the movement or storage of fire ant carriers have a general biosecurity obligation to take all reasonable steps to ensure they do not spread fire ants. Movement of a fire ant carrier from within the fire ant biosecurity zone may need a biosecurity instrument permit. More information is available on the Department of Agriculture and Fisheries website www.daf.qld.gov.au/plants/weeds-pest-animals-ants/invasive-ants/fire-ants.

F. Connections to, alteration or realignment of Council infrastructure

Where development works require the connection to, alteration, removal or realignment of Council infrastructure or impact on other public utility infrastructure (e.g. telecommunications, electricity and gas), the applicant must obtain the necessary approvals from the relevant public utility authority prior to works commencing.

Connection to, alteration, removal or realignment of Council infrastructure includes (but is not limited to) fire hydrants, water service meters, sewer maintenance hole covers, stormwater drainage infrastructure, reinstatement of maintenance hole covers, stormwater drainage infrastructure, crossovers, footpaths, road pavement, kerb and channel, kerb ramps, medians, traffic islands, road furniture, signage and line-marking.

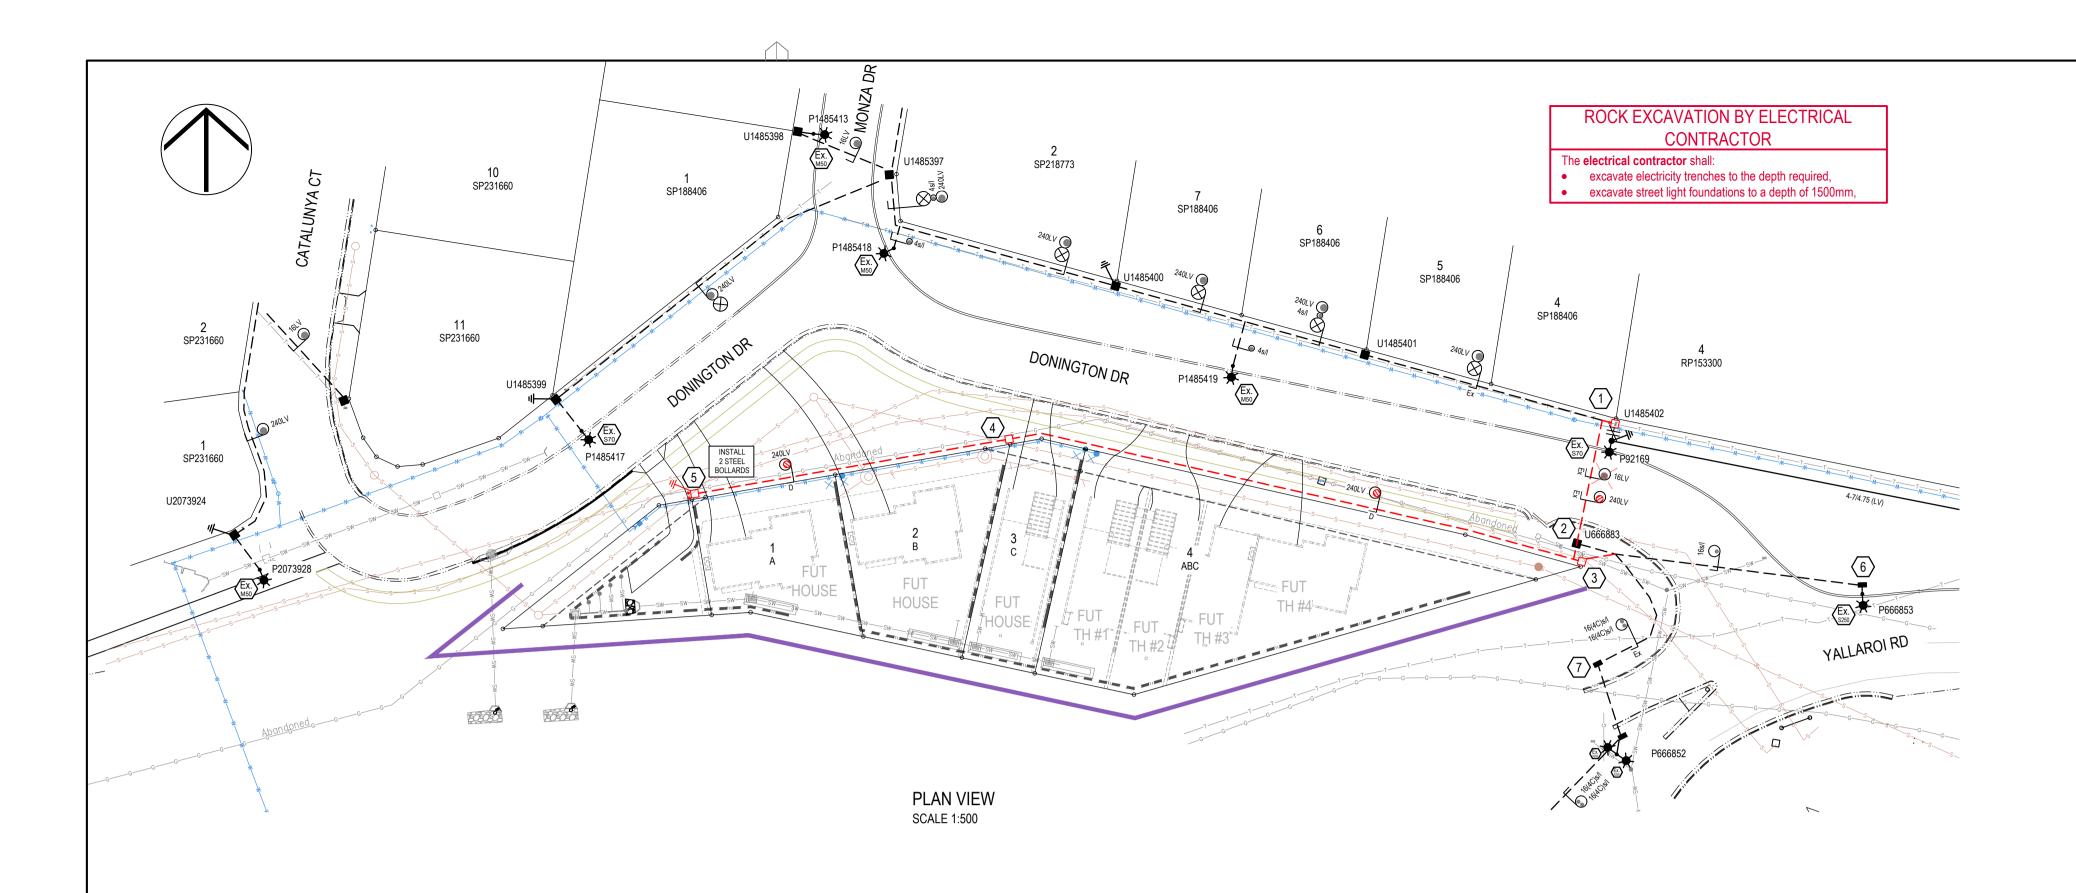
G. Applicant responsibilities

The applicant is responsible for securing all necessary approvals and tenure, providing statutory notifications and complying with all relevant laws.

Nothing in this decision notice alleviates the need for the applicant to comply with all relevant local, State and Commonwealth laws and to ensure appropriate tenure arrangements have been made where the use of/reliance upon land other than that owned by the applicant is involved. Without liming this obligation, the applicant is responsible for:

- a. Obtaining all other/further necessary approvals, licences, permits, resource entitlements etc by whatever name called required by law before the development the subject of this approval can be lawfully commended and to carry out the activity for its duration;
- b. Providing any notifications required by law (by way of example only, to notify the administering authority pursuant to the *Environment Protection Act 1994* of environmental harm being caused/threatened by the activity, and upon becoming aware the premises is being used for a 'notifiable activity');

- c. Securing tenure/permission from the relevant owner to use private or public land not owned by the applicant (including for access required by conditions of approval);
- d. Ensuring the correcting siting of structures on the land. An identification survey demonstrating correct siting and setbacks of structures may be requested of the applicant to ensure compliance with this decision notice and applicable codes;
- e. Providing Council with proof of payment of the Portable Long Service Leave building construction levy (or proof of appropriate exemption) where the value of the Operational Works exceed \$150,000. Acceptable proof of payment is a Q.Leave –Notification and Payment Form approved by the Authority. Proof of payment must be provided before Council can issue a development permit for the Operational works. This is a requirement of section 77(1) of the Building and Construction Industry (Portable Long Service Leave) Act 1991; and
- f. Making payment of any outstanding Council rates and charges applicable to the development site prior to the lodgement of subdivision plans.



LABELS

CONSTRUCTION CONTACTS

ROBIN RUSSELL & ASSOCIATES PTY LTD

ELECTRICAL ENGINEER

WILLIAM SCHARDT ph: 0419 778 552

CONSTRUCTION COORDINATOR BERNIE RUSSELL ph: 0413 598 560

CIVIL ENGINEER

SURVEYOR

MORTONS URBAN SOLUTIONS KEVIN FOX ph: 5571 1099

JOHN GILLESPIE ph: 5479 5311

CAD CON SURVEYING & TOWN PLANNING

DATE | REV | REVISION


28/8/2019 A PRELIMINARY ISSUE

DESIGNER

The contractor shall check label details against existing labels on site. Report any discrepancies immediately to the Contract Superintendent

LV SWI	TCHB	DARD	LABI	ELS AT MUGGELLO DR SC1485388
CIRCUIT No.	LABEL SIZE	LABEL COLOUR	LETTER SIZE	LABEL INFORMATION
TRANSF. ISOLATOR	80x35	WB	6	TRANSFORMER ISOLATOR
1	80x35	WB	5	[EXIST]
2	80x35	WB	5	TO MONZA DR U1485394 DIRECT, THEN DONINGTON DR P92169 & SERVICES
3	80x35	WB	5	[EXIST]
4	80x35	WB	5	[EXIST]

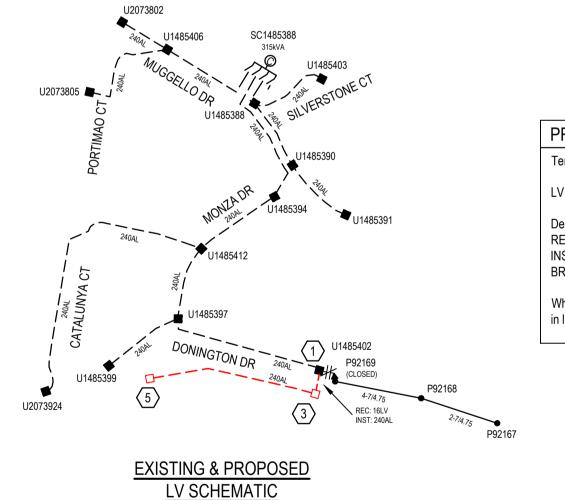APP. DATE REV REVISION



SCALE 1:2500

PROPOSED COMMISSIONING PLAN

Tentative only; subject to amendment by ENERGEX outage coordinator.

LV Switching x 1

Description of switching: RECOVER 16LV (STN 1-2)

INSTALL 240LV (STN 1-3)

BRIDGE IN & COMMISSION LV CABLE AT STN 1 U1485402

Where interruptions to existing consumers are required, they shall be notified in line with ENERGEX policies.

PLANS AND DOCUMENTS referred to in the

Application No: OPW/2019/1257

Dated: 11 November 2019

GENERAL NOTES

required by the authorities.

CIVIL CONTRACTOR

Electrical Safety Act 2002.

ground level inside the lot.

Energex's manual at:

Section C1: Conduits

Section C2: Excavation

http://www.robrus.com.au

'as constructed' departures from the civil design.

ON-SITE SERVICES CHECKS

identification can be obtained from:

Telephone 1100

Fax 1300 652 077

relevant service authorities.

Dial Before You Dig Service

http://www.1100.com.au.

on the associated RRA works plan.

directly above the electrical conduits.

On-line enquiries can be made at:

Section C3: Transformer Sites

first be authorised in writing by the Contract Superintendent.

ELECTRICAL CONTRACTOR

In the event of conflict between this works plan and drawings and specifications of the relevant future

the drawings and specifications of the future asset owner shall take precedence. Exceptions apply

asset owner, i.e. Energex, Ergon, local authority, Department of Transport & Main Roads, NBNTM, etc.,

where RRA design documentation specify clearances, depths & separations greater than the minimum

The contractor shall not accept a verbal instruction from any person to depart from the requirements of

this works plan or RRA General Specification. Any departure from the works plan or specification must

The works detailed on this drawing shall be constructed in accordance with Robin Russell & Associates'

The installation of all electrical conduits shall be supervised by the holder of an electrical work licence

Where road-crossing conduits are installed deeper than usual (under culverts or pipes) they must rise to a

depth of not more than 1200mm at each end. If uncertain, seek advice from RRA Construction Coordinator.

The civil contractor shall install enveloping conduits under retaining walls behind pillars - two 100mm conduits into each lot (one for Electricity, one for Communications), 500mm deep behind the pillar, near

Relevant specifications in Energex's Underground Distribution Construction Manual are found at -

These sections of the manual can be downloaded from the following Energex web site:

Care! Lighting of new or altered existing roads might not comply with specified standards

until new road lighting has been commissioned. The civil contractor shall ensure that necessary warning signs are installed and speed restrictions are applied if necessary.

https://swp.energex.com.au/service_providers/technical_docs/asp/technical_documents.asp

Civil engineers who have registered for access to the following RRA website may download extracts from

The civil contractor shall ensure that all conduits have been installed before constructing retaining walls, paths, driveways & water services. The civil contractor shall please inform the electrical contractor of any

Robin Russell & Associates gives no warranty regarding the presence or location of buried services,

including newly-installed services. "As Constructed" locations may differ from what is drawn on this

Having determined which services may be present, on-site locations should then be arranged with

Sewerage and water plans for the subdivision may be obtained on request from the Superintendent.

INSTALLATION OF RRA DESIGNED TELECOMMUNICATIONS CONDUIT

In residential subdivisions, Telecommunications conduits shall be installed generally in shared trenches,

be installed in a separate trench on the specified communications alignment.

Telecoms conduits and pits shall be supplied and installed by the civil and electrical contractors as specified

In commercial subdivisions or other situations where this is not possible, Telecommunications conduits shall

works plan. Contractors shall be responsible to identify and locate all buried services. Initial

Energex conduits and transformer site retaining walls shall be installed strictly in accordance with

Energex's specifications (see below). They will be inspected for compliance upon completion.

General Specification for Installation of Electricity Reticulation and Street Lighting - Issue 'AA'.

conditions of approval as detailed in the **Decision Notice and Council's Planning Scheme, Local Laws and Planning Policies**

TELECOMMUNICATIONS INFRASTRUCTURE

CONDUITS & PITS | to be designed by: Robin Russell & Associates

to be installed by: civil & electrical contractors to be owned by:

TELECOMMUNICATIONS INFRASTRUCTURE to be provided by:

NBNCo

DURCE DOCUMENTS								
EATOR	DRAWING	DWG. NO.						

OURCE DOCUMENTS											
REATOR	DRAWING	DWG. NO.	REV. NO.	DATE							
ORTONS URBAN SOLUTIONS	CIVIL BASE	36901-ALL.zip	-	15/8/2019							
NERGEX	MAINS MAP	Drawing2.dwg	-	16/8/2019							

LEGEND: ELECTRICAL

— — — EXISTING UNDERGROUND CABLE

— — PROPOSED UNDERGROUND CABLE

— — FUTURE UNDERGROUND CABLE

BORED CONDUIT GAS IN SHARED TRENCH

(12) (12L) STATION NUMBERS

PADMOUNT TRANSFORMER, EXISTING / PROPOSED / FUTURE

(R)/(R) / (R) RING MAIN UNIT, EXISTING / PROPOSED / FUTURE

POLE TRANSFORMER, EXISTING / PROPOSED / FUTURE

CABLE FAULT INDICATOR

■/□/□ SERVICE PILLAR, EXISTING / PROPOSED / FUTURE

■/N/N LINK PILLAR, EXISTING / PROPOSED / FUTURE

+/+/+ LV LINKS (OPEN), EXISTING / PROPOSED / FUTURE

LV LINKS (CLOSED), EXISTING / PROPOSED / FUTURE

——— EXISTING OVERHEAD ELECTRICITY MAINS

PROPOSED OVERHEAD ELECTRICITY MAINS

FUTURE OVERHEAD ELECTRICITY MAINS

O/O/O HV POLE, EXISTING / PROPOSED / FUTURE ●/●/● HV + LV POLE, EXISTING / PROPOSED / FUTURE

• / • / • LV POLE, EXISTING / PROPOSED / FUTURE -||•|/ -||•| EARTH, EXISTING / PROPOSED / FUTURE

The street light, existing / proposed / future — — EXISTING RATE 3 STREETLIGHT CABLE

— — PROPOSED RATE 3 STREETLIGHT CABLE FUTURE RATE 3 STREETLIGHT CABLE

RATE 3 STREET LIGHT, EXISTING / PROPOSED / FUTURE RATE 3 STREET LIGHT,

RATE 3 SWITCHBOARD, EXISTING / PROPOSED

— — EXISTING CONSUMERS UNDERGROUND CABLE

— — PROPOSED CONSUMERS UNDERGROUND CABLE

TO BE RECOVERED

● / Ø CABLE, EXISTING / PROPOSED

32/40mm HD CONDUIT 80/100mm LD CONDUIT

 \circ

100mm WHITE ENERGEX COMMS. CONDUIT ᢒ

 \otimes 125mm LD CONDUIT

△ "ENERGEX ELECTRIC CABLE" MARKER PLATE

DEVELOPMENT APPROVAL

1: 1000 (A1 - NOT REDUCED)

"AS CONSTRUCTED" DOCUMENTS

The electrical contractor shall email the "as constructed" drawing, test results & closure documents to:

subdivision@energex.com.au

as.constructed@robrus.com.au

UNDERGROUND CABLE CERTIFICATION

All cables detailed on this drawing have been checked using the cable locator described below and are, according to measurements taken, on the correct alignment and at correct depths below the finished level, except as marked up. Alignments are subject to the

accuracy of survey pegs present at the time of measurement.

Model: Date Cables Checked: Serial No: Name of Person Who Conducted Checks:

Certified (signature of checker)

Phone No. of checker:

SITE INFORMATION

TOTAL NUMBER OF LOTS PROPERTY DESCRIPTION PROPOSED LOTS 1-4 CANCELLING LOT 3 on SP275769

D134-01A ENERGEX PROJECT No.

APP. | CURRENT REVISION CHANGES:

CONSULTING ENGINEERS - ELECTRICAL

SUBDIVISION **ELECTRICAL SERVICES** 204/6 Babarra Street, Stafford, QLD 4053 Tel: (07) 3872 5555 Fax: (07) 3872 5566 Email: rr@robrus.com.au www.robrus.com.au A.B.N. 78 010 589 661

ENERGEX WCS47.1 DESIGNED W.Schardt SPECIFICATION GOLD COAST CITY DRAWN COUNCIL The Drafting Room ROBIN RUSSELL APPROVED BY COUNCIL REF PN349822/12/DA1 RPEQ 1546 Map Grid GC 16 G10 Robin homela **UBD REF** SIGNED DWT REV DATE 28/8/2019 V47 - 20190715

ELECTRICITY RETICULATION -COMMUNITY TITLES TELLURIUM GG Pty Ltd

DESCRIPTION

DONINGTON DRIVE SUBDIVISION DONINGTON DR MAUDSLAND

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S0106748 1 of 2

URD CONDUIT SCHEDULE - FOOTPATHS - BY **ELECTRICAL** CONTRACTOR

				CONDUIT LENGTH (**)							X-SECTION (m)				
	STAT	STATIONS		CONDUIT LENGTH (m)									KERB		
LOCATION	FROM - TO		40mm HD	No	100mm LD	No	125mm LD	No	ENERGEX 100mm Comms MD	(m)	EXCAV/ TAPE		MARK 'E'	REMARKS	TRENCH
DONINGTON DR	1	-			2	1					2	D		REPLACE CONDUIT AS REQ'D	2
	2	3			4	1					4	D		EXTEND CONDUI TO NEW PILLAR	4
	3	5			122	1					122	D			122
	3	6			5	1					5	D		DIVERT EXIST TO NEW PILLAR	5
	3	7			5	1					5	D		DIVERT EXIST TO NEW PILLAR	5
ALL STREETS AT PILLARS & POLES									8				PVC COVER STRIP AT PILLARS		
TOTAL					138					8	138				138

- 1. CONDUITS SHALL BE INSTALLED WITHIN A CORRIDOR 300-900mm FROM PROPERTY ALIGNMENT, IN ACCORDANCE WITH ENERGEX UNDERGROUND DISTRIBUTION
- CONSTRUCTION (UDC) MANUAL.
- 2. FOOTPATH CONDUITS SHALL HAVE MINIMUM 700mm COVER, REGARDLESS OF ENERGEX'S REQUIREMENTS.
- 3. CONNECT EXISTING CONDUITS, INCLUDING ROAD CROSSING CONDUITS, TO NEW FOOTPATH CONDUITS
- 4. TELECOMMUNICATION CONDUITS SHALL BE INSTALLED ABOVE THE ENERGEX CONDUITS IN A JOINT USE TRENCH ARRANGEMENT.

UNDERGROUND CABLE SCHEDULE

					• • •								
LOCATION	STATION		VOLTS	EX	REC	IN	CABLE SIZE/TYPE	MODEL ID	ROUTE LENGTH	CAE LENG	BLE TH (m)	REMARKS	
		Л - ТО							(m)	NEW	REC	1	
DONINGTON DR	1	2	LV		*		16mm ² Cu 4C XLPE/PVC	SCS820365	16		20		
	1	3	LV			*	240mm ² AI 4C XLPE/PVC	SCS820364	20	24			
	3	5	LV			*	240mm ² AI 4C XLPE/PVC	SCS820364	122	130			
	3	6	SL	*			16mm ² Cu 2C PVC/PVC	LVC216PVPV	36			T'FER EXIST CABLE	
	3	7	SL	*			16mm ² Cu 4C XLPE/PVC	SCS820365	52			T'FER EXIST CABLE	
	3	7	SL	*			16mm ² Cu 4C XLPE/PVC	SCS820365	52			T'FER EXIST CABLE	
ALL CTREETS	AT PI	LLARS	LV			*	16mm ² Cu 4C XLPE/PVC	SCS820365		12		BRIDGING	
ALL STREETS	STREET	TLIGHTS	SL			*	4mm ² Cu 2C PVC/PVC	LVC24PVPV		0			
VARIANCE	VARIANCE 5 %												
TOTALC							240mm ² AI 4C XLPE/PVC	SCS820364		162			
TOTALS							16mm² Cu 4C XLPE/PVC	SCS820365		13	20		

EQUIPMENT SCHEDULE - SERVICE PILLARS

LOCATION	STN NO.	SITE I.D.	EX	REC	IN	SIZE AND DESCRIPTION	COMP I.D.	CU/SC/ CONST. CODE	QTY	REMARKS
DONINGTON DR	1	U1485402	*	*		2 WAY PILLAR	PI1		1	2x240
					*	3 WAY PILLAR	PI1	LVSP9-6	1	3x240
	2	U666883	*	*	*	CROSS-ROAD PILLAR & S/L	PI1		1	1x16
	3	U2202884			*	2 WAY PILLAR & S/L	PI1	LVSP4-6SL	1	2x240
				*	SL FUSE HOLDER CFS		1043-3	2	ALTER FUSE PANEL	
										3 FUSES FOR LOT 4 + 3 SL FUSES
	4	U2202885			*	2 WAY PILLAR	PI1	LVSP4-6	1	2x240
	5	U2202886			*	1 WAY PILLAR, MEN	PI1	LVSP2-6	1	1x240
								1011-2	1	
					*	GALVANISED PIPE BOLLARD		1350-1	2	
VARIOUS LOCATIONS						ADDITIONAL EARTH		A DE	1	

CONDUIT BENDING RADIUS (mm)										
LOCATION	40mm Ø	100mm Ø	125mm Ø							
HORIZONTAL BEND	600	1830	1830							
PILLAR - MAIN CABLE	-	1200	-							
PILLAR - X-ROAD CABLE	-	450	-							
PILLAR - STREET LIGHT CABLE	600	-	ı							
STREET LIGHT	300	-	-							
POLE TERMINATION	300	1200	1830							
TRANSFORMER	r	o bends require	d							

LVSP9-6 1 LVSP4-6SL 1

1043-3 2 LVSP4-6 1 LVSP2-6 1 1350-1 2 1011-2 1

ADE 1

PLANS AND DOCUMENTS referred to in the DEVELOPMENT APPROVAL

Application No: OPW/2019/1257

Dated: 11 November 2019

Development shall comply with the conditions of approval as detailed in the Decision Notice and Council's Planning Scheme, Local Laws and Planning Policies

DATE	REV	REVISION	APP.	DATE	REV	REVISION	APP.	CURRENT REVISION CHANGES:
28/8/2019	Α	PRELIMINARY ISSUE	RR					



SUBDIVISION ELECTRICAL SERVICES								
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Tel: (07) 3872 5555 Fax: (07) 3872 5566								
Email: rr@robrus.com.au www.robrus.com.au								
A.B.N. 78 010 589 661								

ENERGEX SPECIFICATION	WCS47.1	DESIGNED	W.Schardt	DESCRIPTION	
COUNCIL	GOLD COAST CITY	DRAWN	The Drafting Room	ELECTR COMMU	
COUNCIL REF	PN349822/12/DA1	APPROVED BY	ROBIN RUSSELL RPEQ 1546	CLIENT	
UBD REF	Map Grid GC 16 G10	SIGNED	Robin homela	TELLURIU	
DWT REV	V47 - 20190715	DATE	28/8/2019	IELLURIC	

TELLURIUM GG Pty Ltd


DONINGTON DRIVE SUBDIVISION DONINGTON DR MAUDSLAND ELECTRICITY RETICULATION - COMMUNITY TITLES

D134-02A ENERGEX PROJECT No.

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^{1.} THE CONTRACTOR SHALL MEASURE ACTUAL CABLE LENGTHS REQUIRED, AFTER INSTALLATION OF CONDUITS, THEN ORDER CABLE ACCORDINGLY.


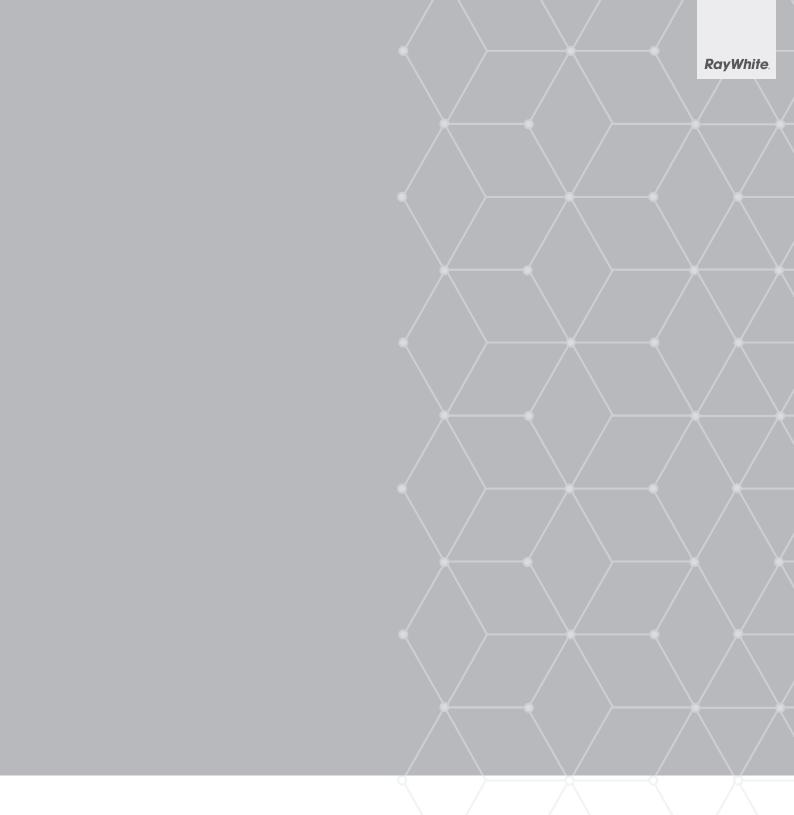
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